



TECHNICAL CONDITIONS OF CONTRACT (TCC)


VOLUME-IA PART – II CHAPTER – 2


DRAWINGS

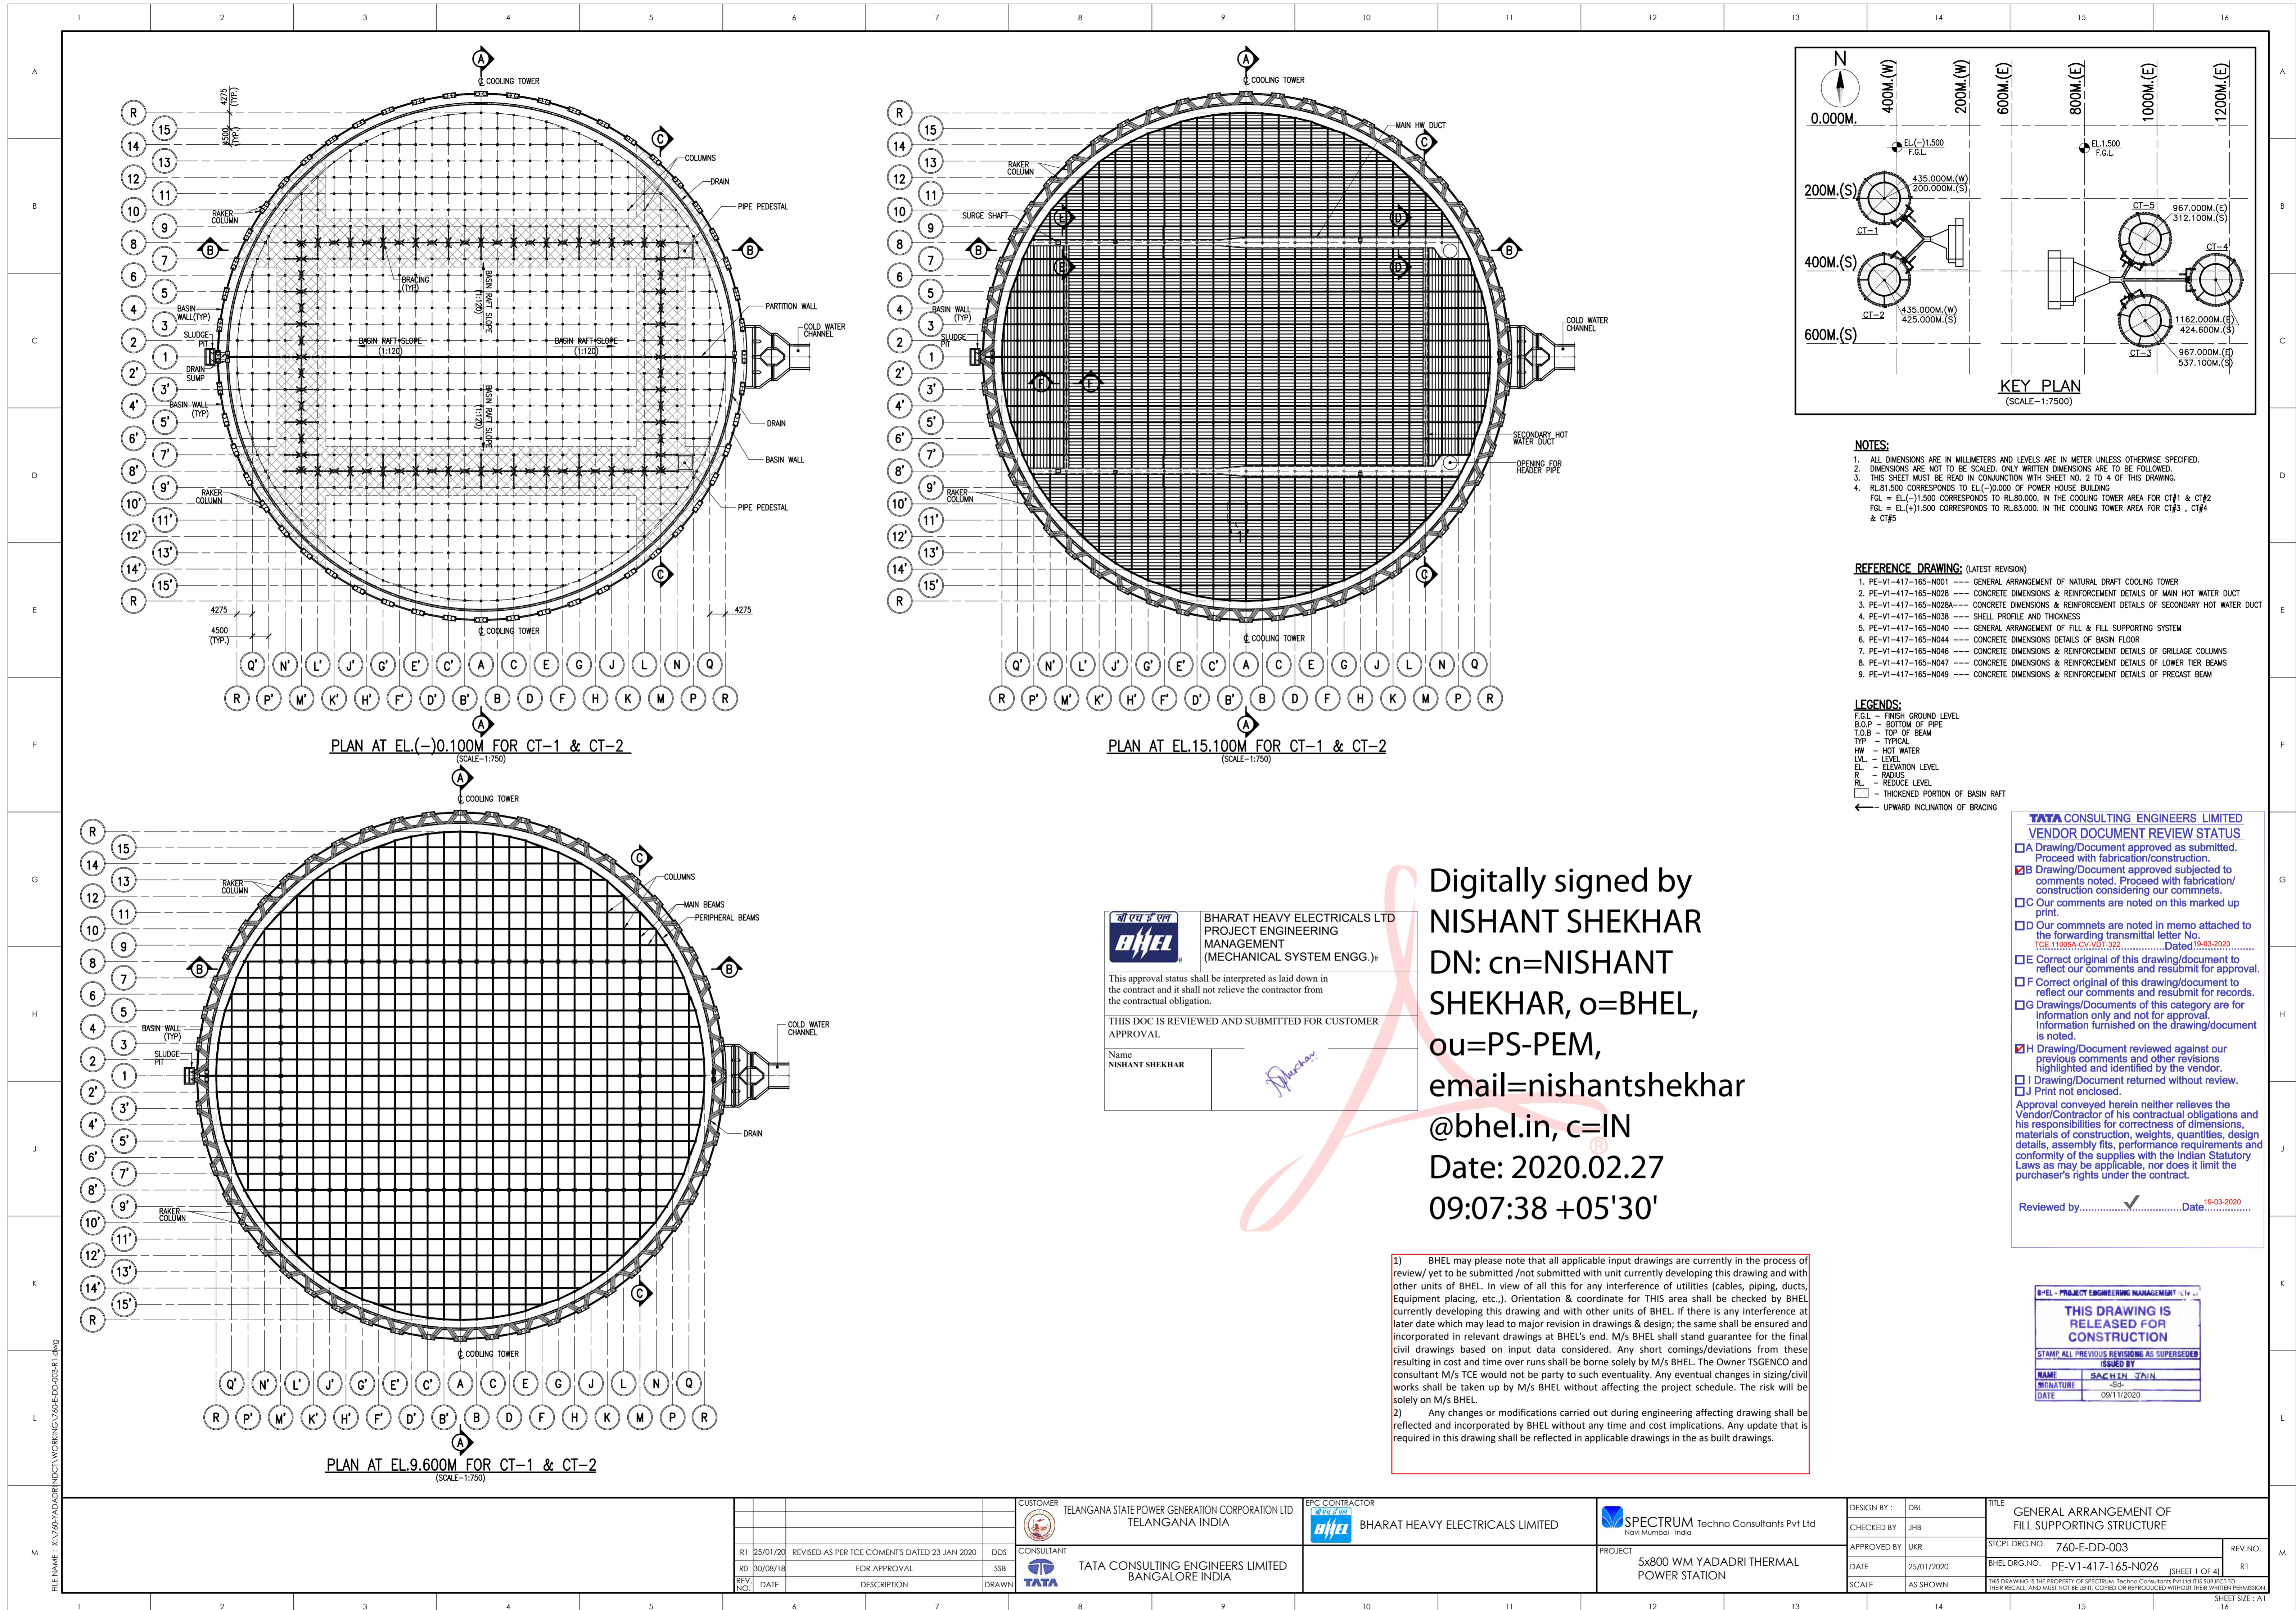

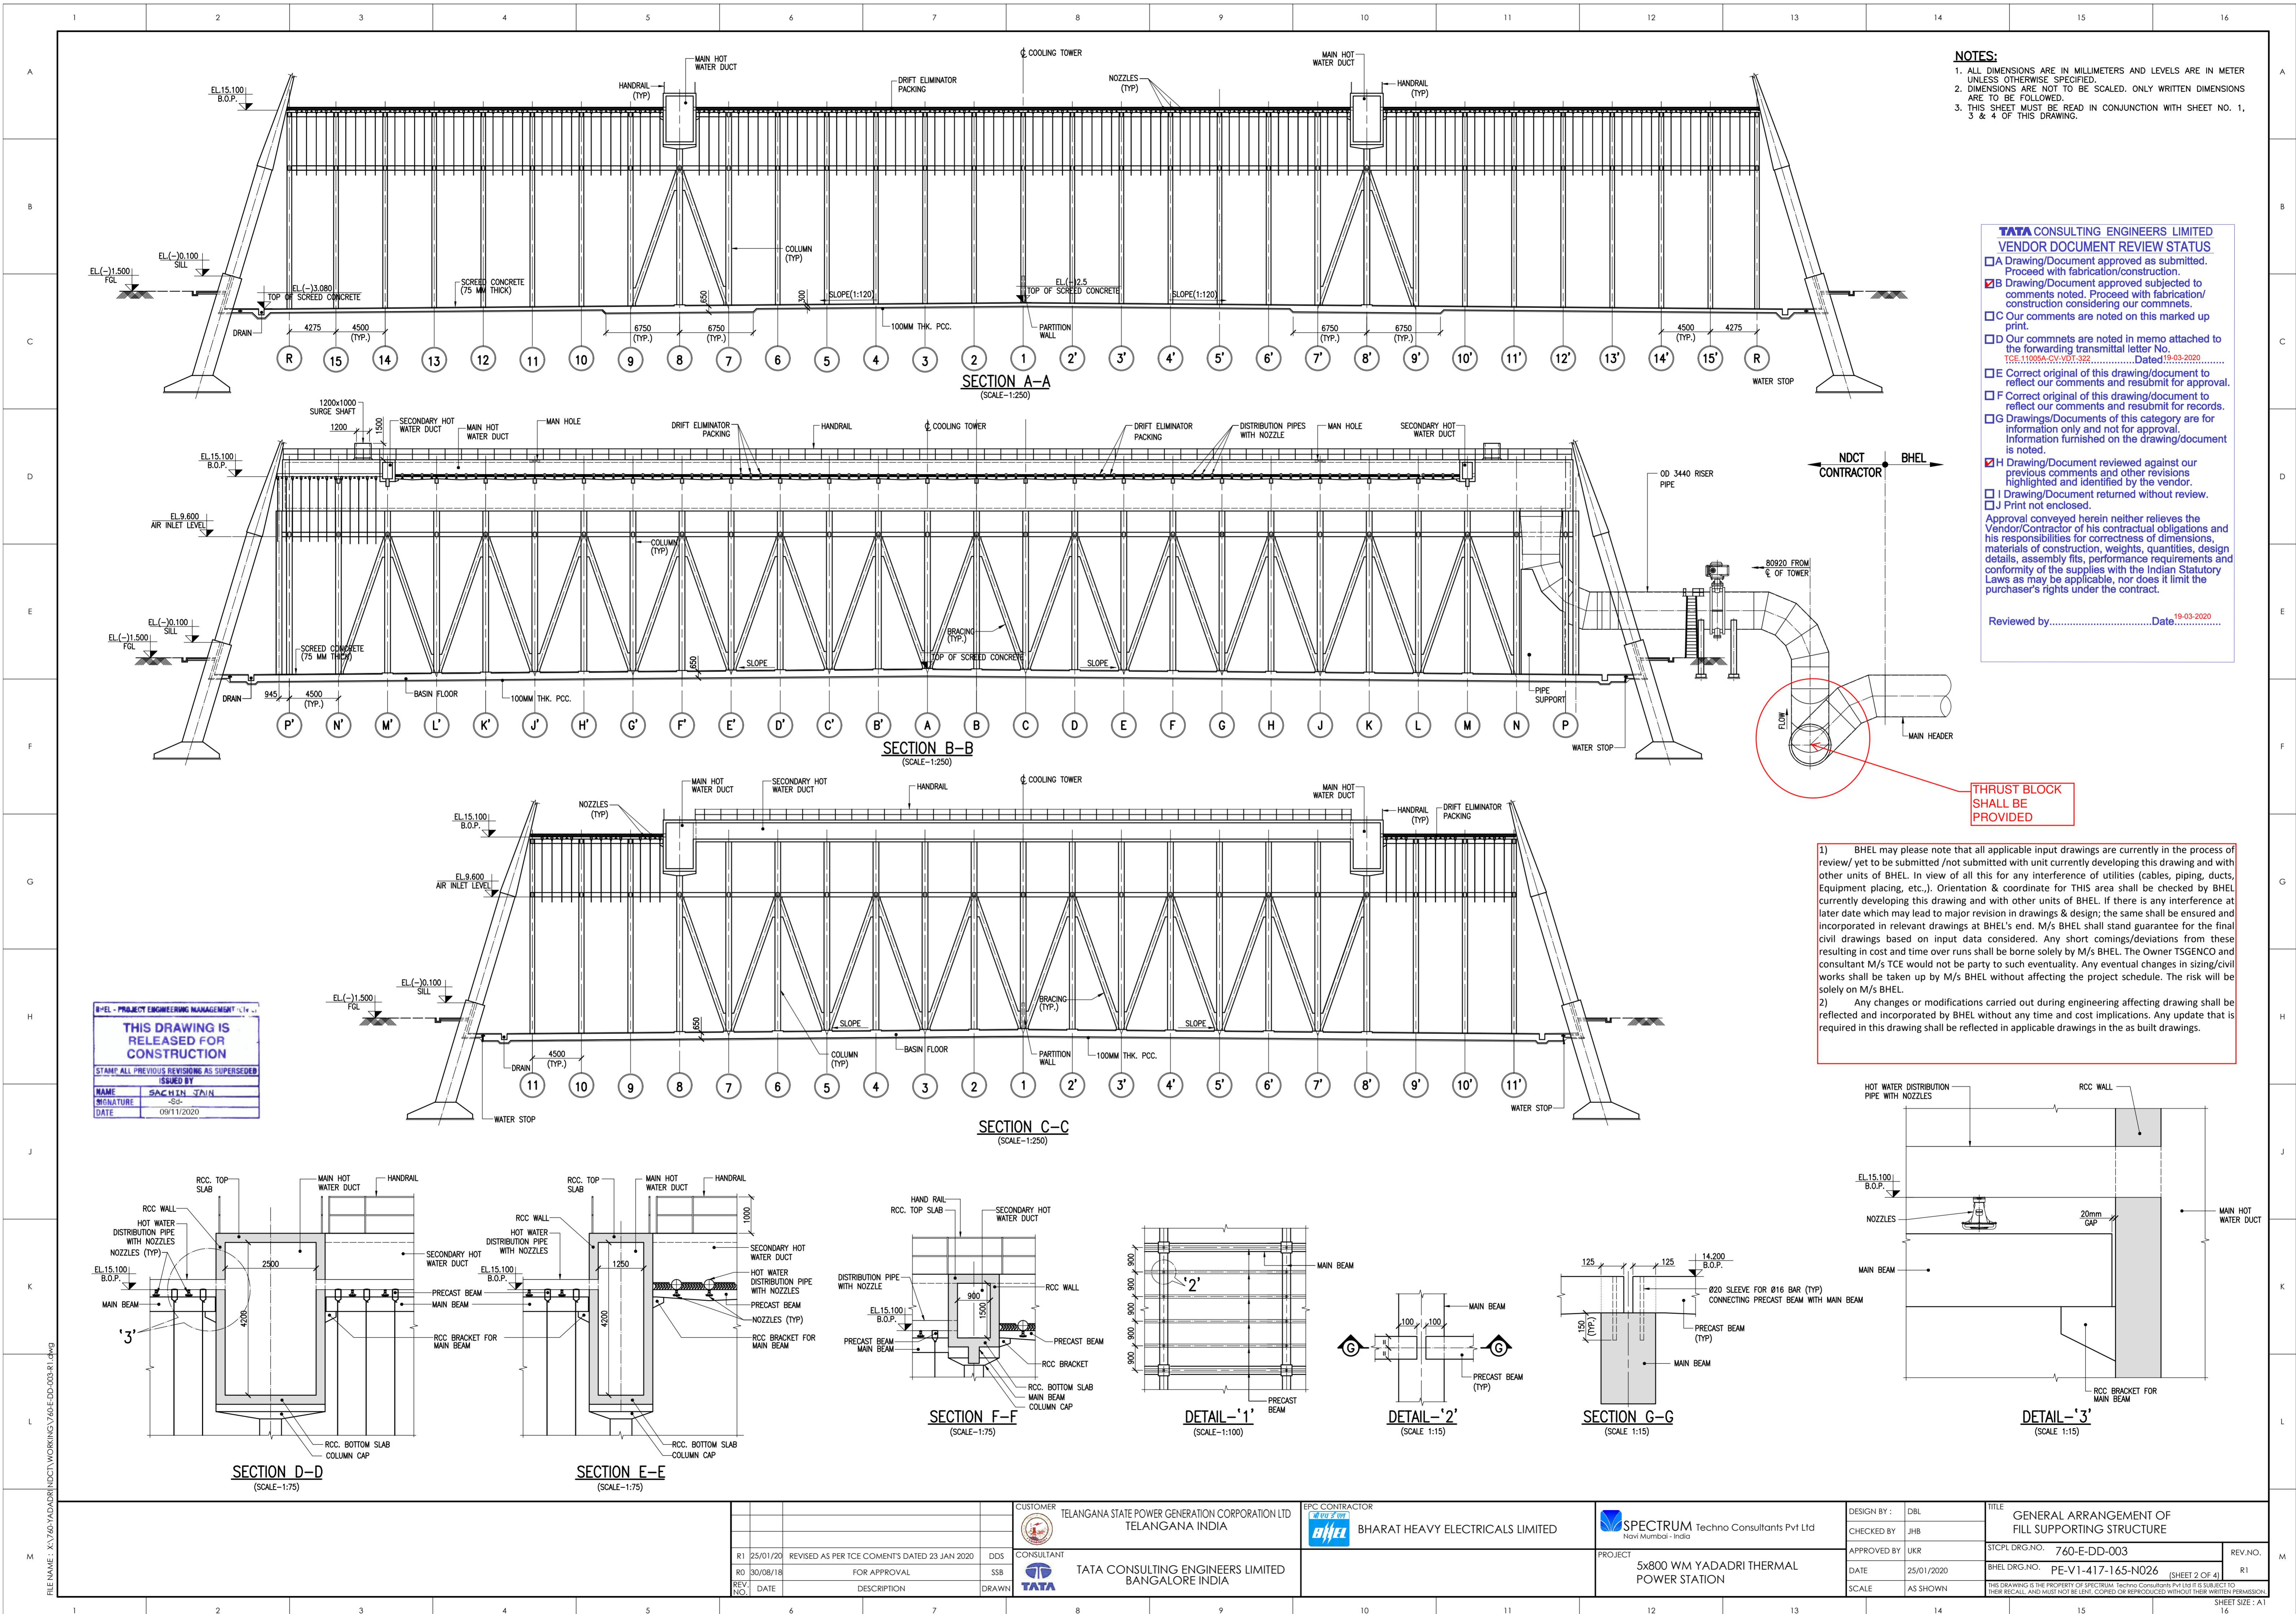

NOTES:
 1. ALL DIMENSIONS ARE IN MILLIMETERS AND LEVELS ARE IN METER UNLESS OTHERWISE SPECIFIED.
 2. DIMENSIONS ARE NOT TO BE SCALED. ONLY WRITTEN DIMENSIONS ARE TO BE FOLLOWED.
 3. THIS SHEET MUST BE READ IN CONJUNCTION WITH SHEET NO. 1, 2 & 4 OF THIS DRAWING.

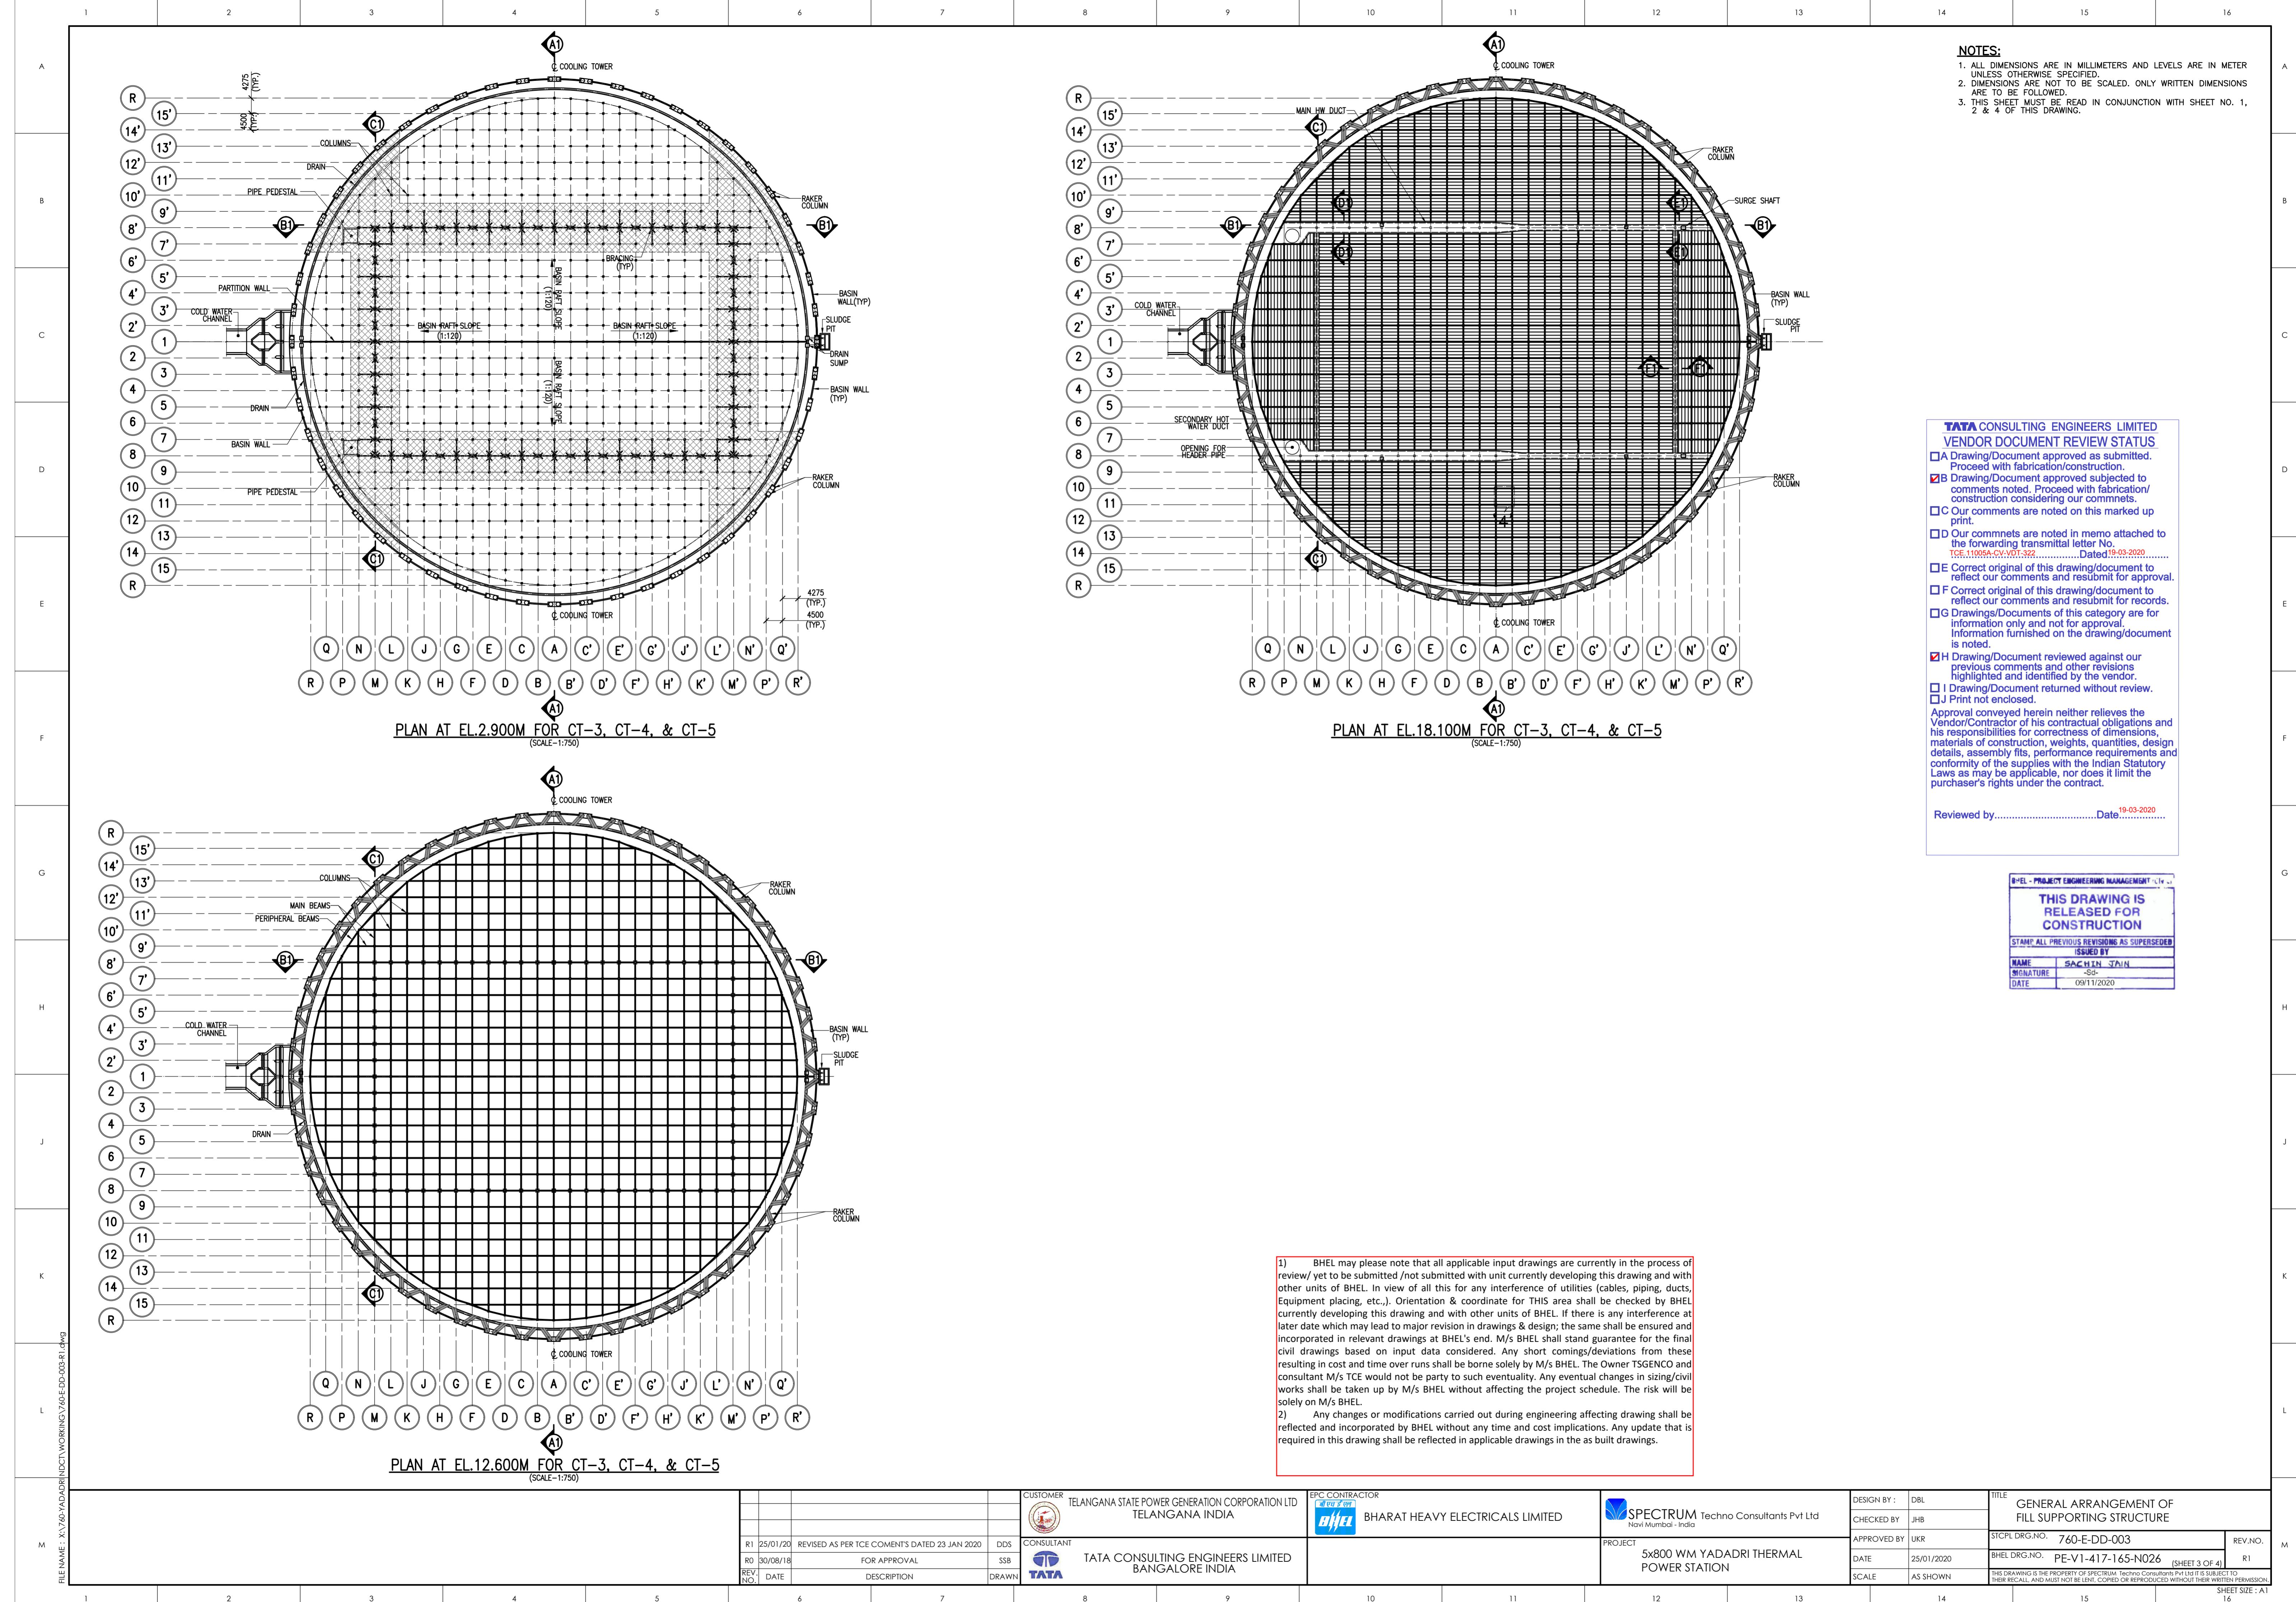

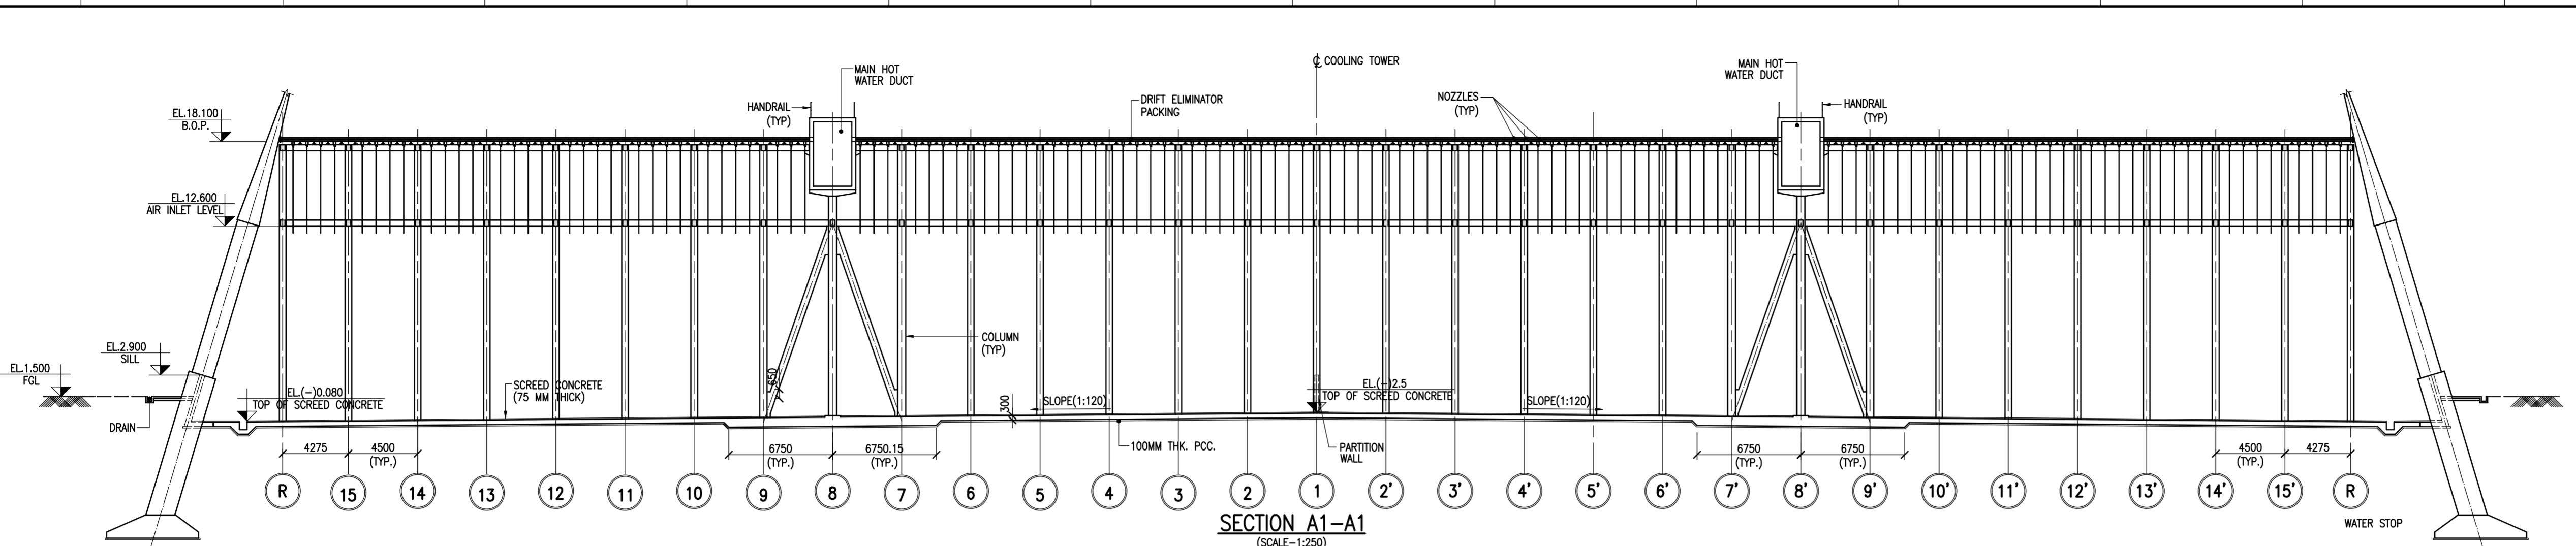

OTES:
ALL DIMENSIONS ARE IN MILLIMETERS AND LEVELS ARE IN METER
UNLESS OTHERWISE SPECIFIED.
DIMENSIONS ARE NOT TO BE SCALED. ONLY WRITTEN DIMENSIONS
ARE TO BE FOLLOWED.
THIS SHEET MUST BE READ IN CONJUNCTION WITH SHEET NO. 1 TO
3 OF THIS DRAWING.

ATA CONSULTING ENGINEERS LIMITED
VENDOR DOCUMENT REVIEW STATUS

Drawing/Document approved as submitted.
Proceed with fabrication/construction.

Drawing/Document approved subjected to
comments noted. Proceed with fabrication/
construction considering our comments.
Our comments are noted on this marked up
print.

Our comments are noted in memo attached to
the forwarding transmittal letter No.
TCE.11005A-CV-VDT-322.....Dated 19-03-2020

Correct original of this drawing/document to
reflect our comments and resubmit for approval.

Correct original of this drawing/document to
reflect our comments and resubmit for records.

Drawings/Documents of this category are for
information only and not for approval.
Information furnished on the drawing/document
is noted.

Drawing/Document reviewed against our
previous comments and other revisions
highlighted and identified by the vendor.

Drawing/Document returned without review.
Print not enclosed.



any conveyance herein neither relieves the

oval conveyed herein neither relieves the Vendor/Contractor of his contractual obligations and responsibilities for correctness of dimensions, materials of construction, weights, quantities, design details, assembly fits, performance requirements and conformity of the supplies with the Indian Statutory Standards as may be applicable, nor does it limit the Purchaser's rights under the contract.


Reviewed by..... Date..... 19-03-2020

PROJECT ENGINEERING MANAGEMENT (PEM)	
<p>THIS DRAWING IS RELEASED FOR CONSTRUCTION</p> <p>ALL PREVIOUS REVISIONS AS SUPERSEDED</p> <p>ISSUED BY</p> <p>SACHIN JAIN</p> <p>-Sd-</p> <p>09/11/2020</p>	
TURE	


- 1) BHEL may please note that all applicable input drawings are currently in the process of review/ yet to be submitted /not submitted with unit currently developing this drawing and with other units of BHEL. In view of all this for any interference of utilities (cables, piping, ducts, Equipment placing, etc.,). Orientation & coordinate for THIS area shall be checked by BHEL currently developing this drawing and with other units of BHEL. If there is any interference at later date which may lead to major revision in drawings & design; the same shall be ensured and incorporated in relevant drawings at BHEL's end. M/s BHEL shall stand guarantee for the final civil drawings based on input data considered. Any short comings/deviations from these resulting in cost and time over runs shall be borne solely by M/s BHEL. The Owner TSGENCO and consultant M/s TCE would not be party to such eventuality. Any eventual changes in sizing/civil works shall be taken up by M/s BHEL without affecting the project schedule. The risk will be solely on M/s BHEL.
- 2) Any changes or modifications carried out during engineering affecting drawing shall be reflected and incorporated by BHEL without any time and cost implications. Any update that is required in this drawing shall be reflected in applicable drawings in the as built drawings.

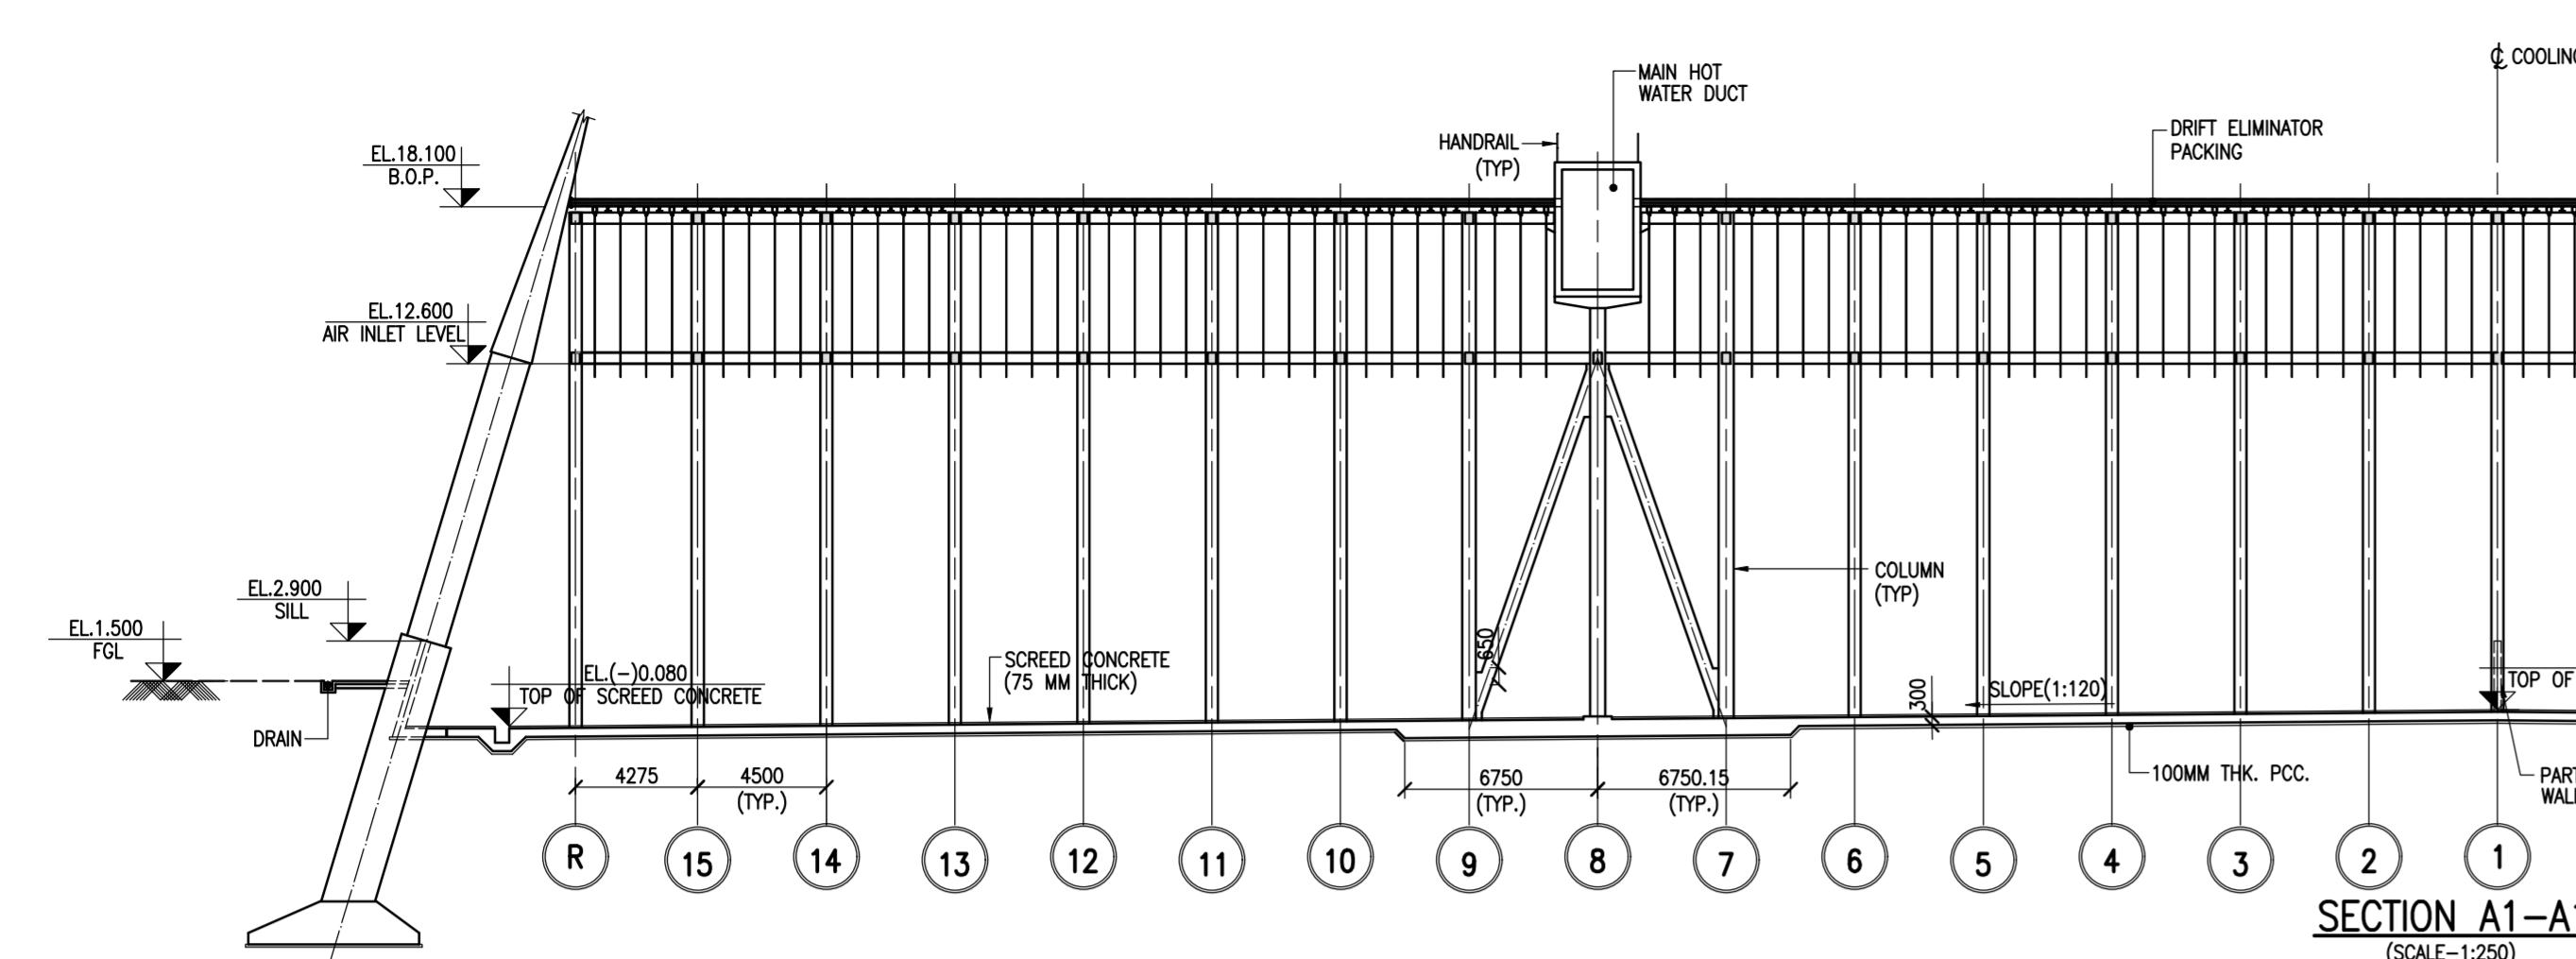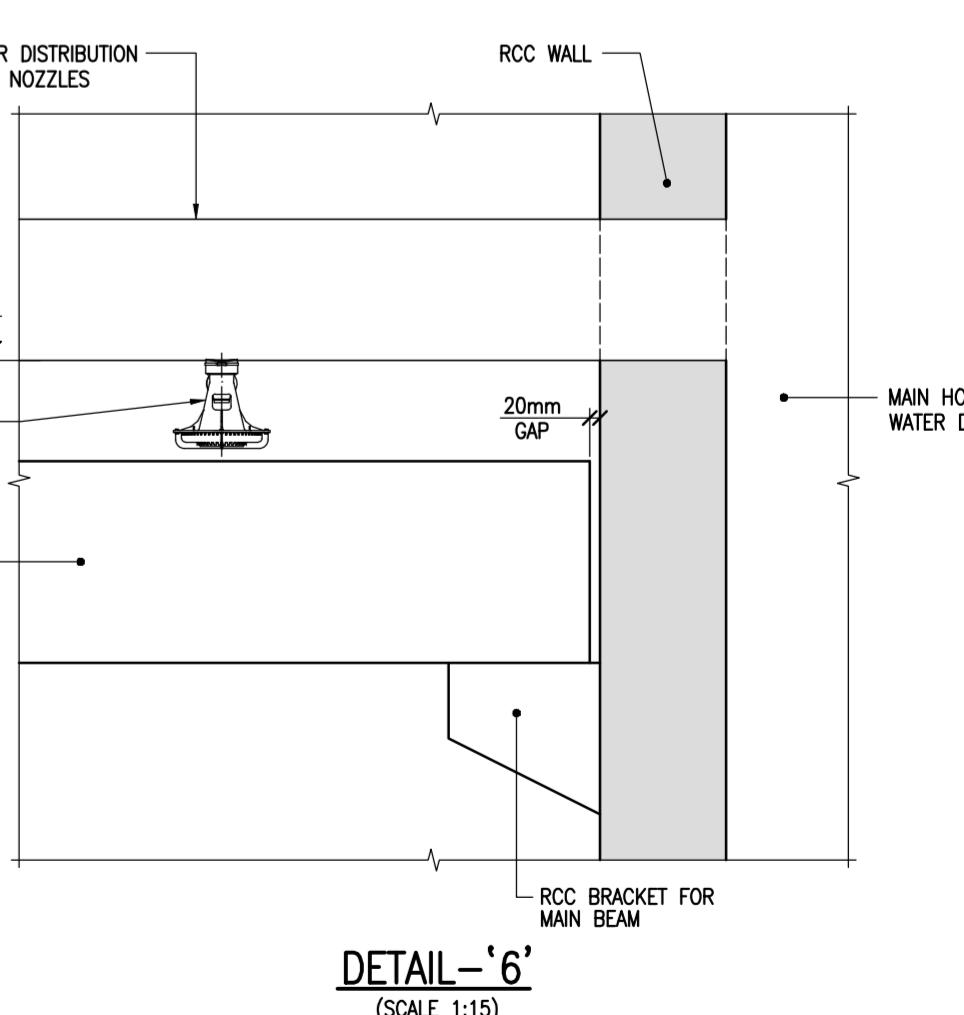


SECTION A1-A1
(SCALE-1:250)

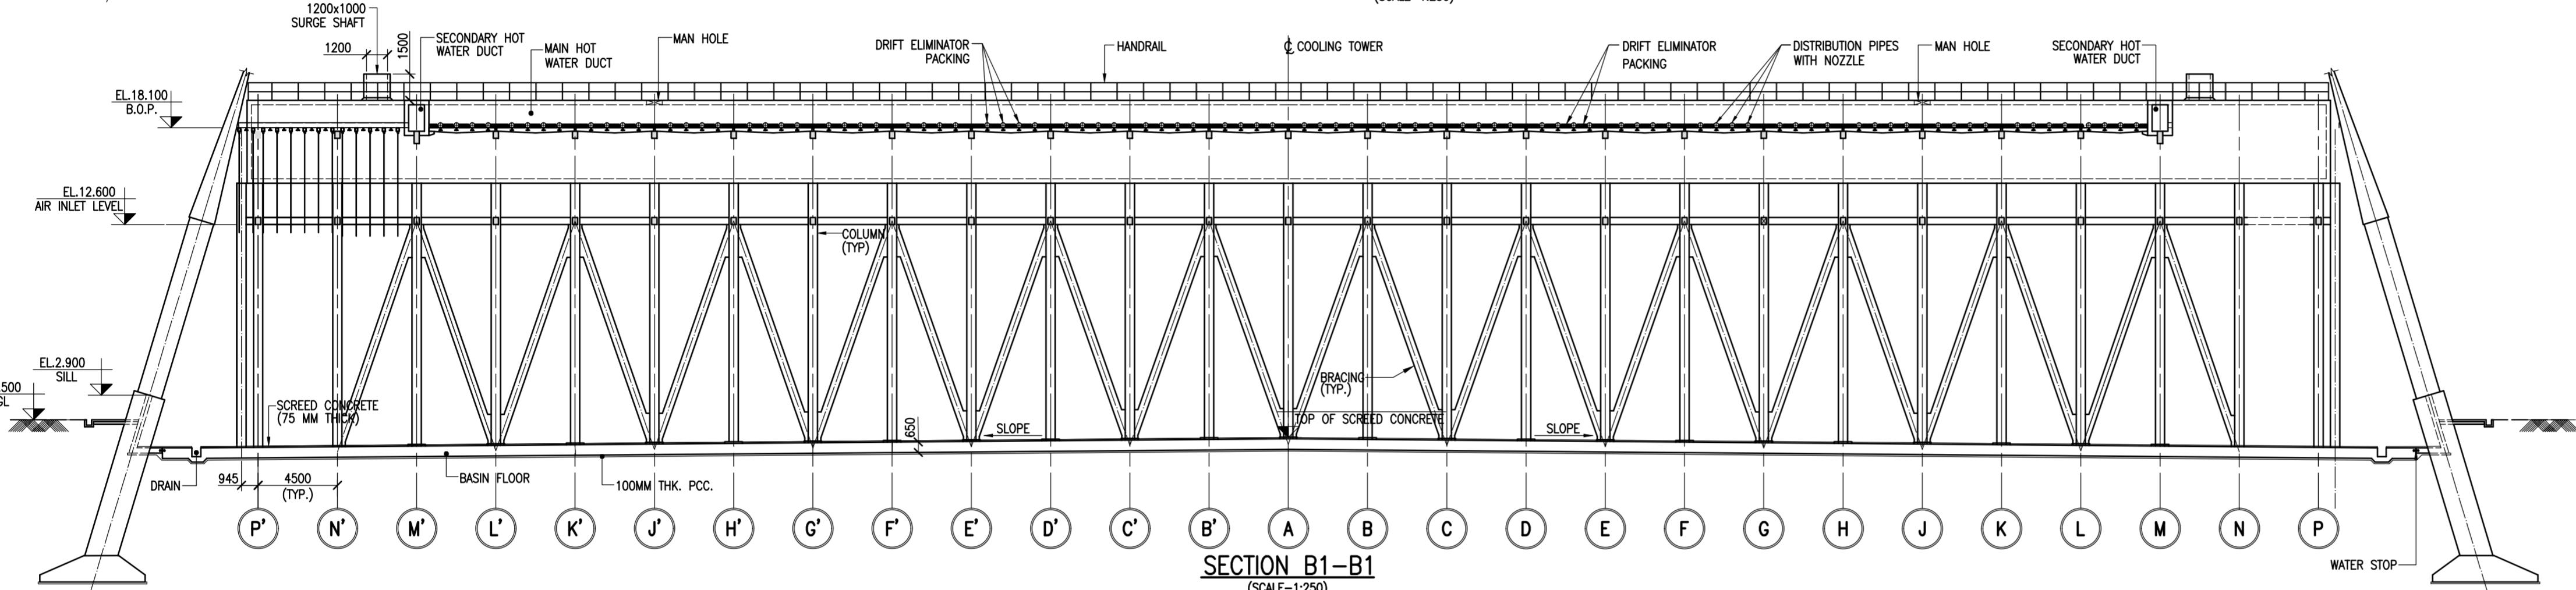


SECTION B1-B1
(SCALE 1:250)

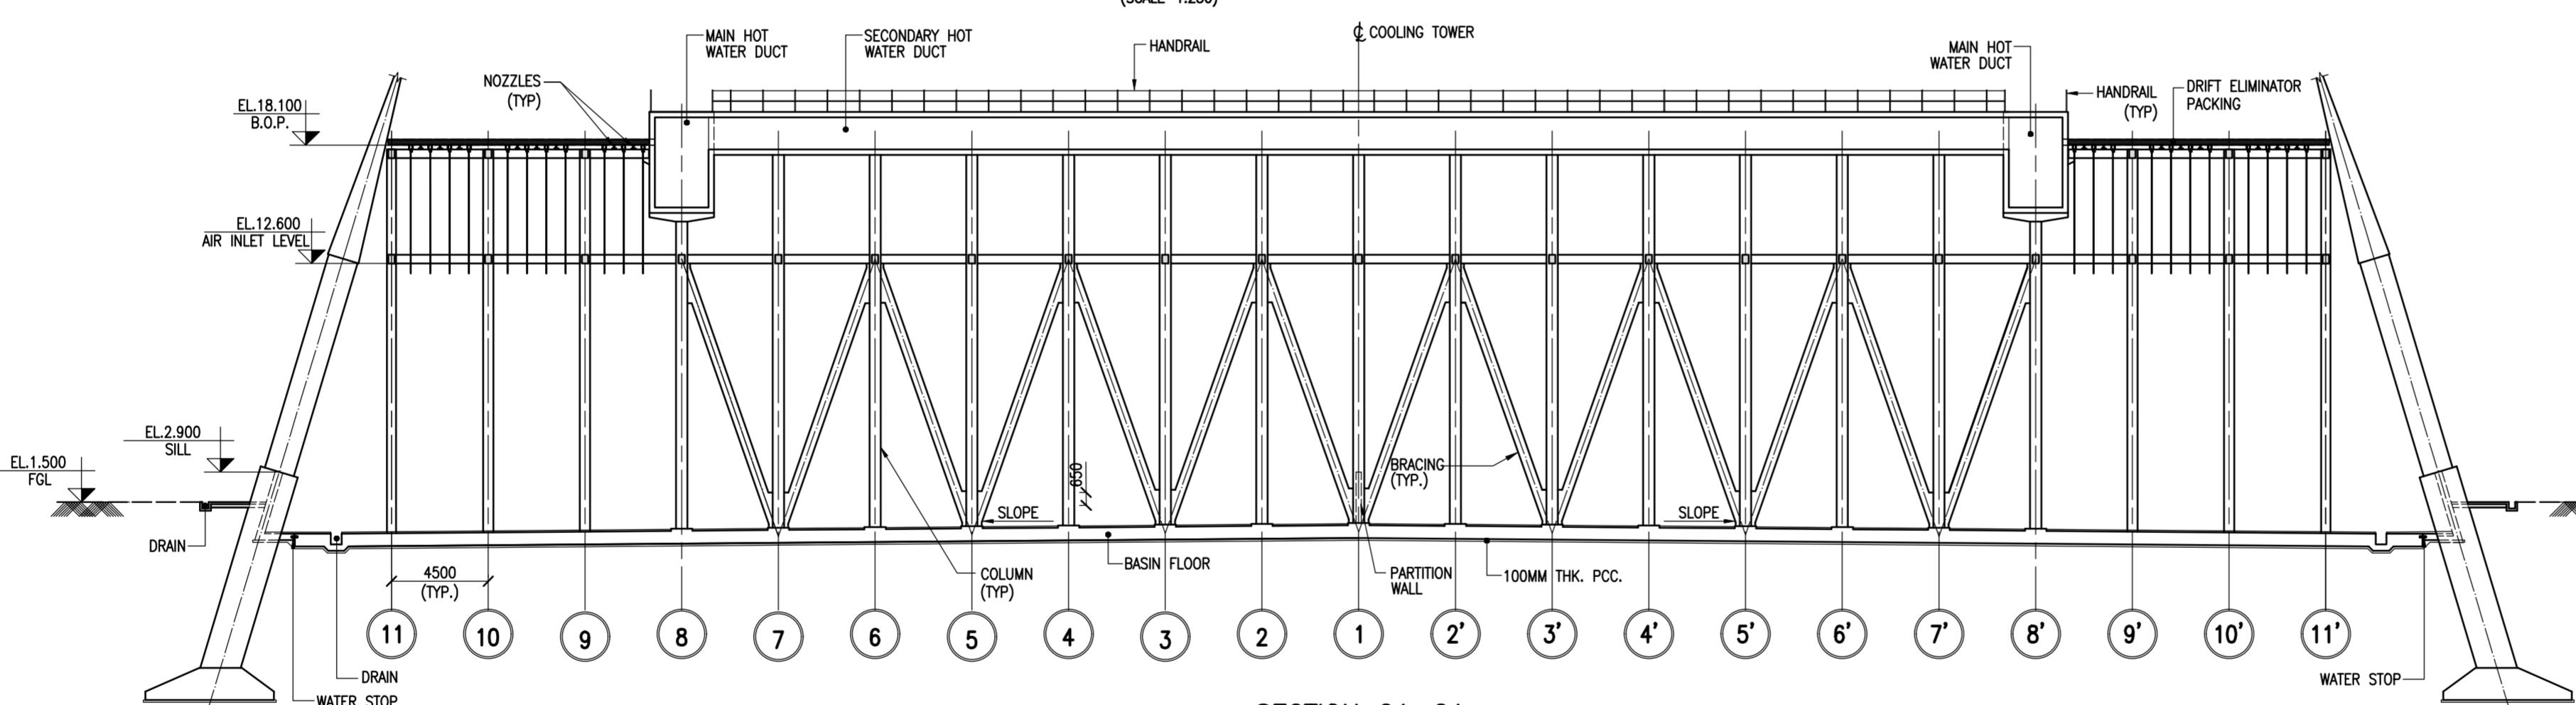


SECTION C1-

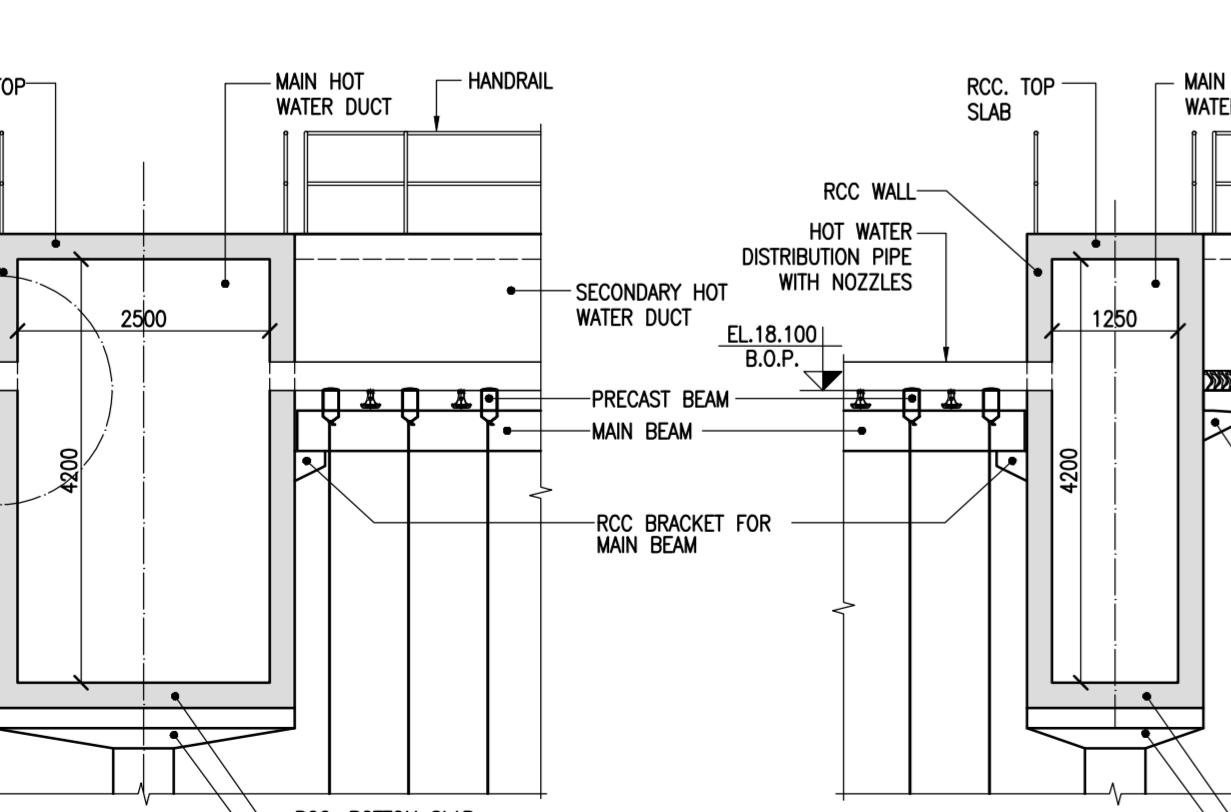


SECTION D-

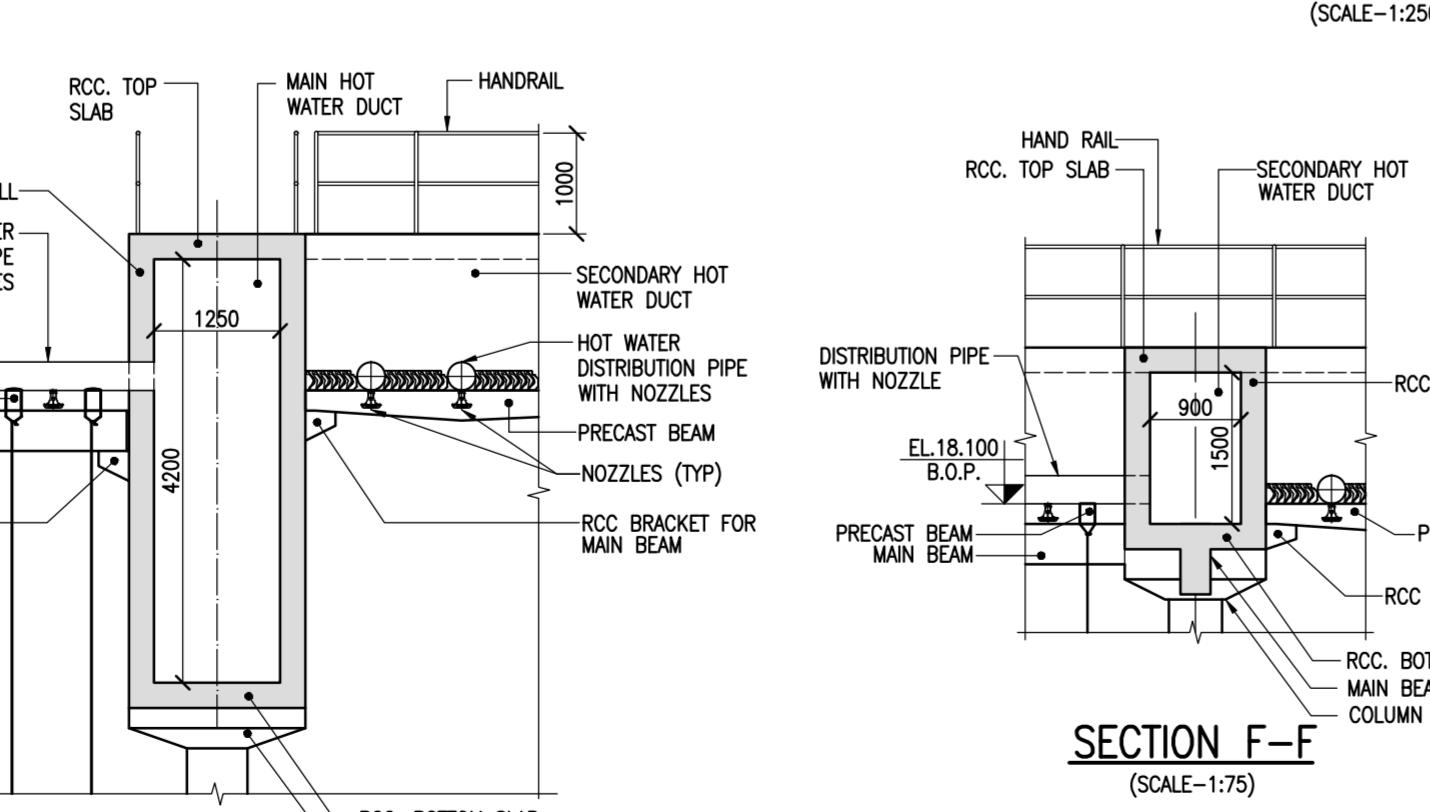



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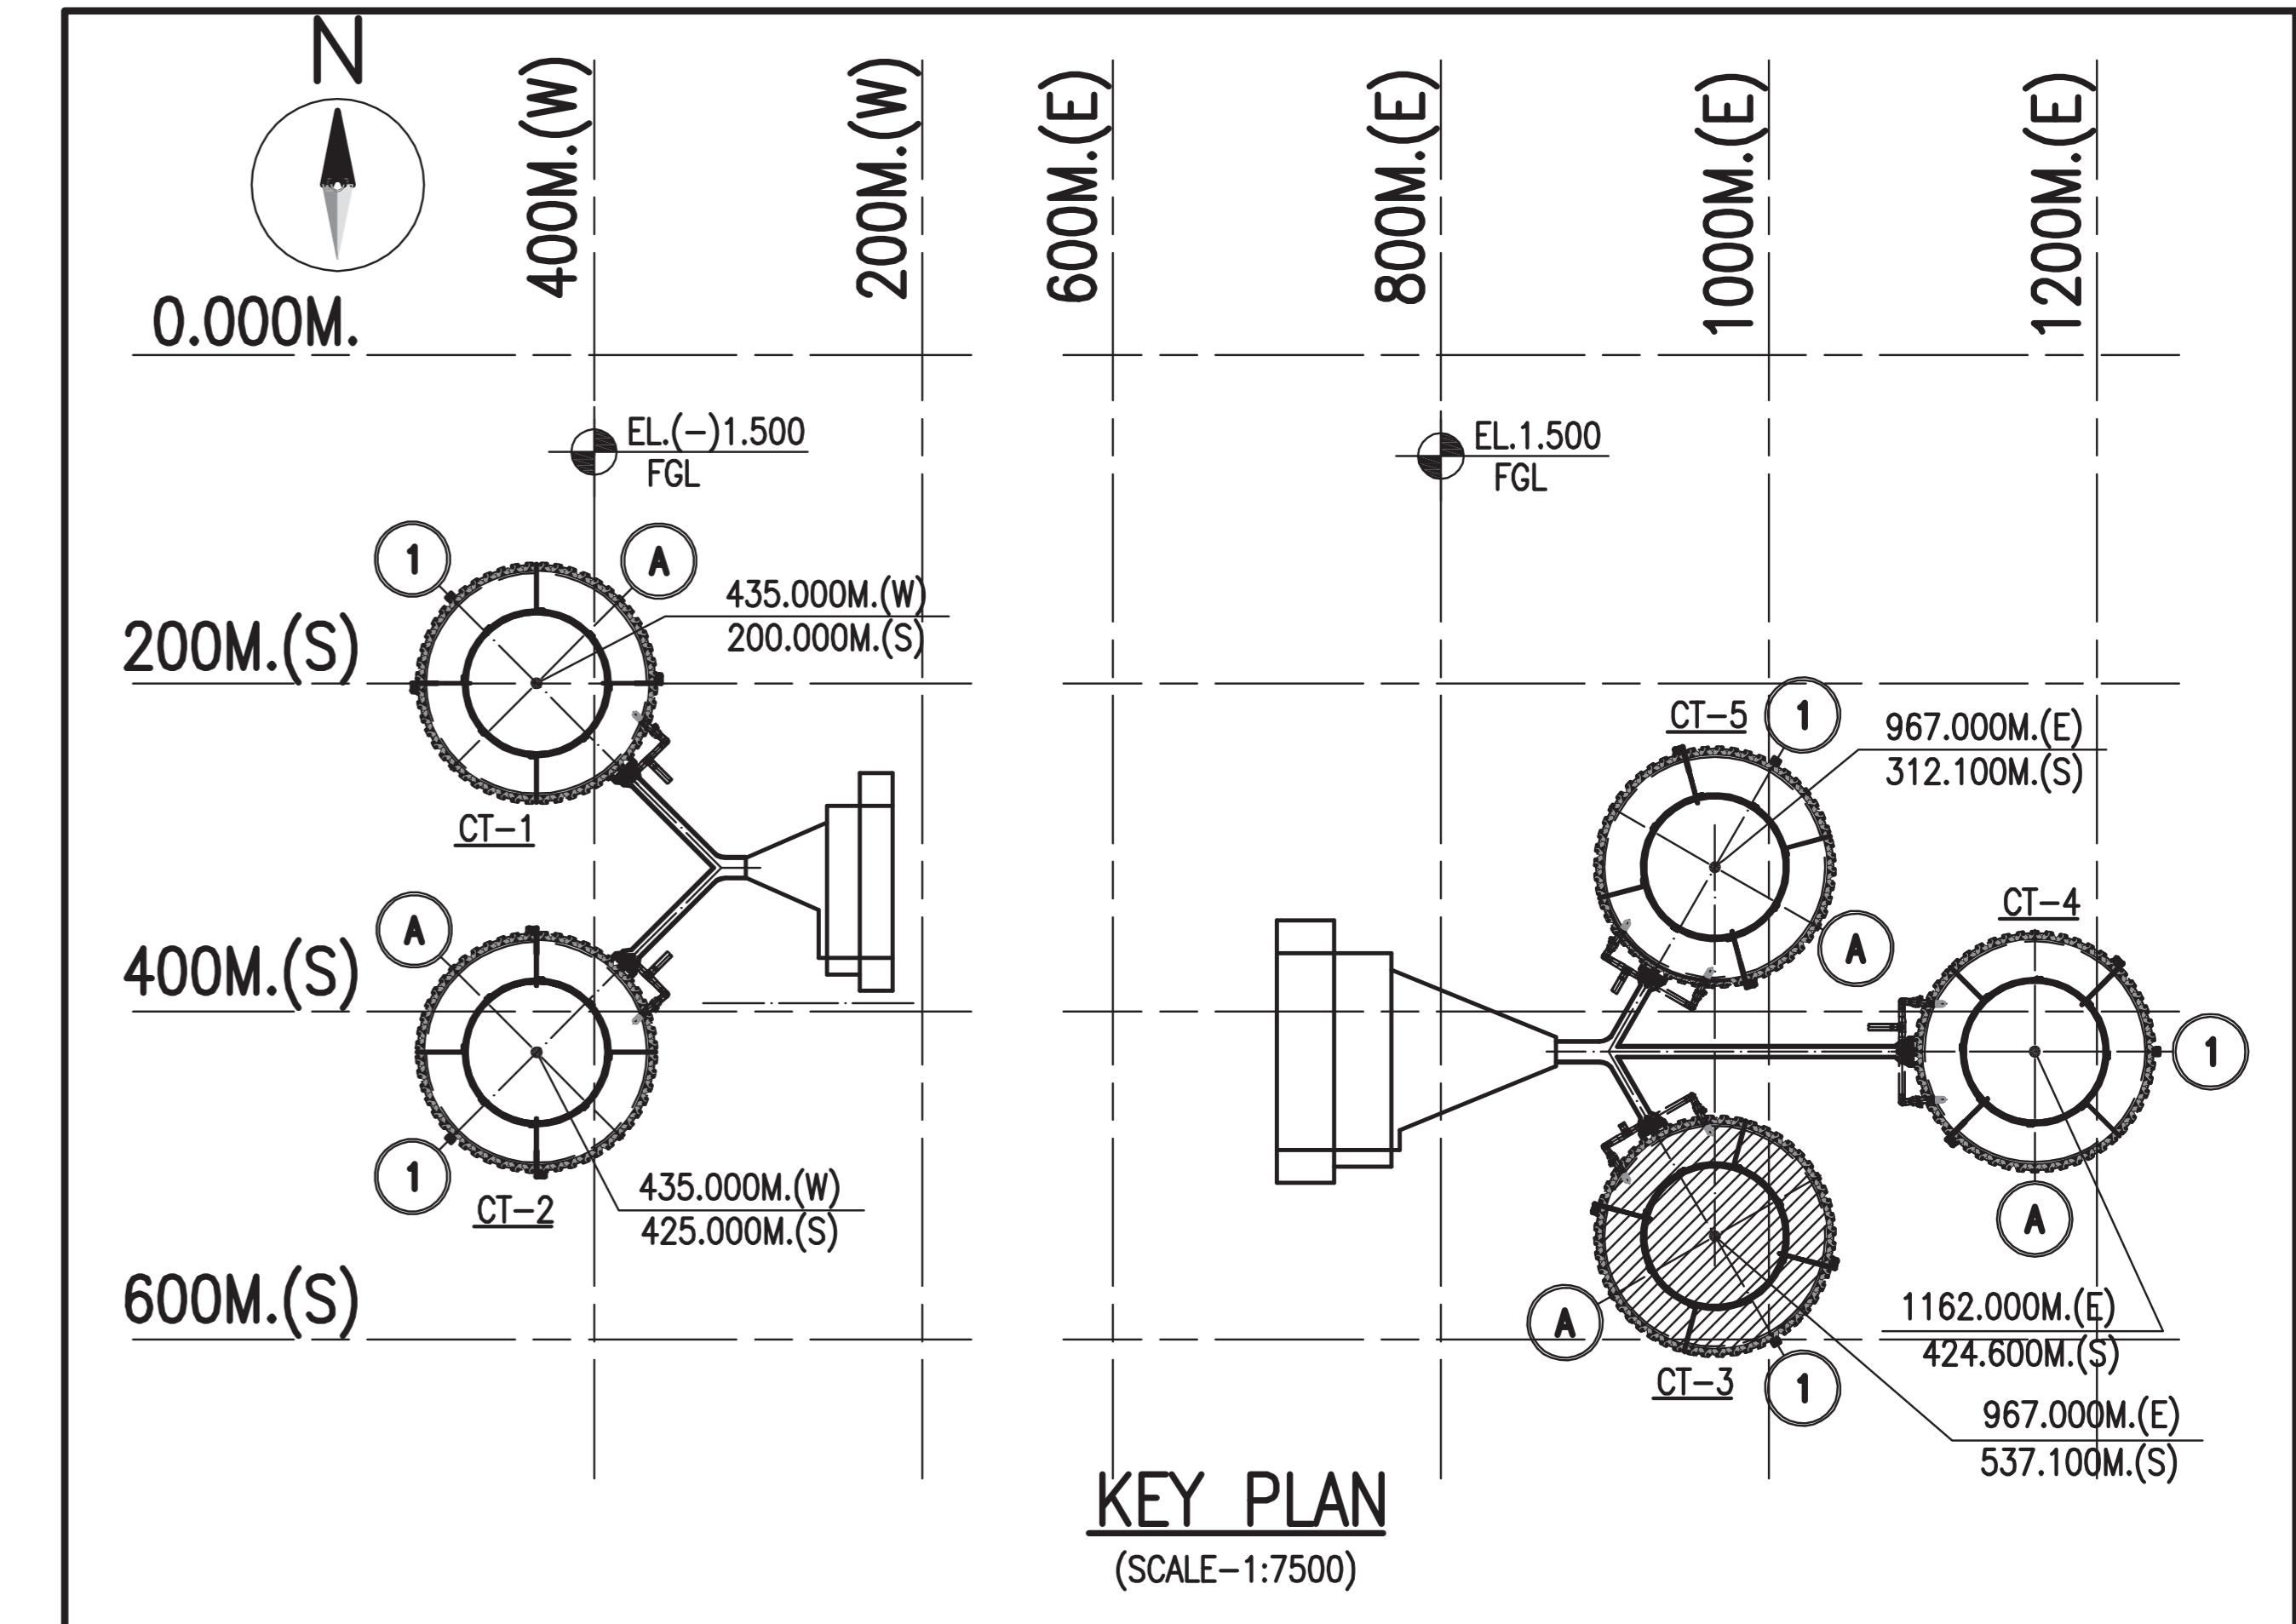
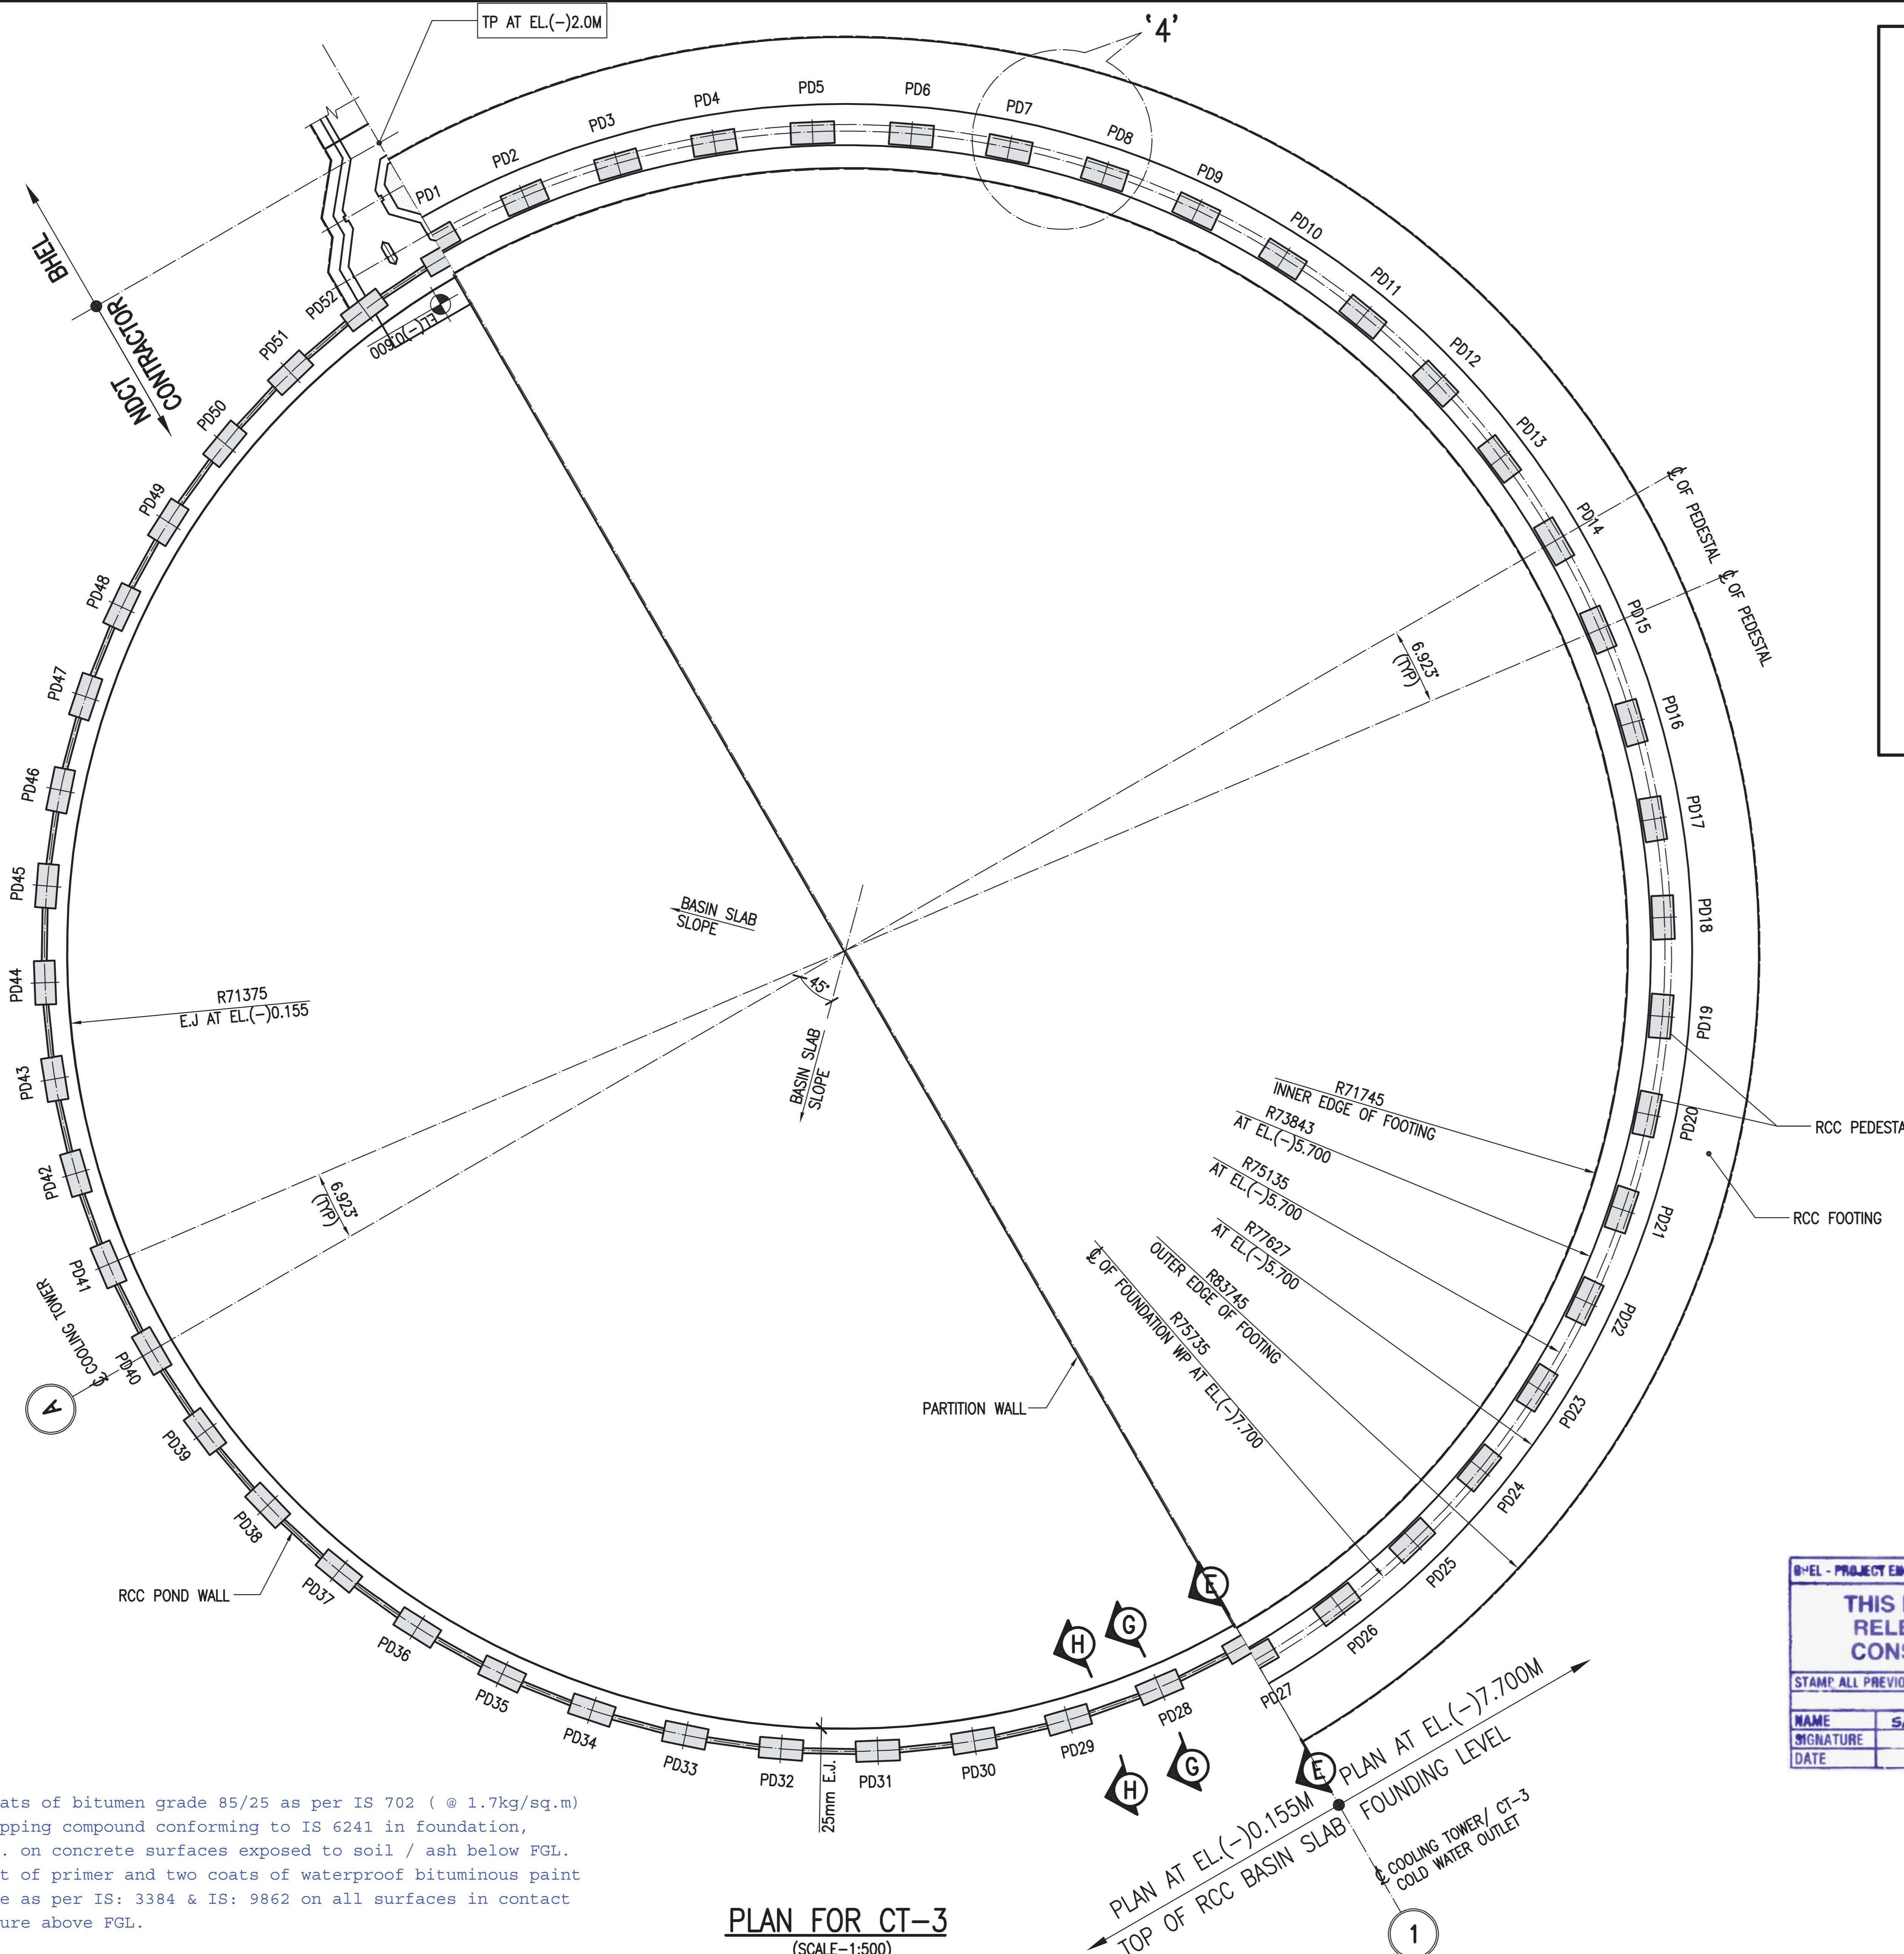


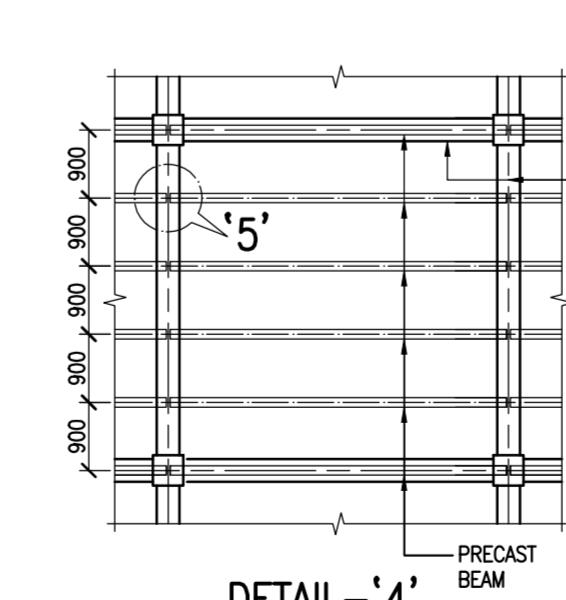DETAIL - '4
(SCALE - 1:100)

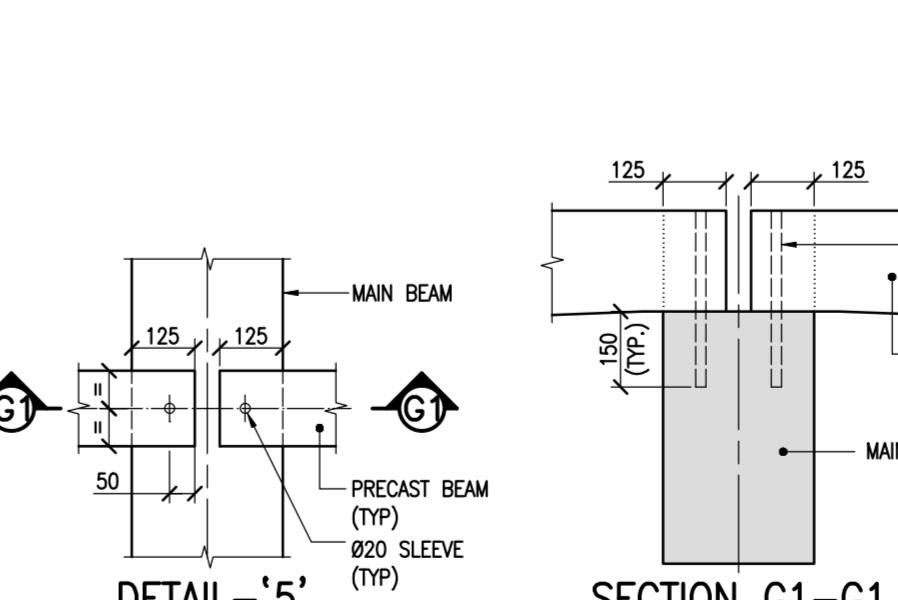

SECTION G1-G
(SCALE 1:15)

			
SECTION D-D (SCALE-1:75)		SECTION E-E (SCALE-1:75)	
FILE NAME : X:\760-YADADRI\NDCT\WORK		CUSTOMER  TELANGANA STATE POWER GENERATION CORPORATION LTD TELANGANA INDIA	
EPC CONTRACTOR  BHARAT HEAVY ELECTRICALS LIMITED		DESIGN BY : DB CHECKED BY : JB	
PROJECT  5800 MW YADADRI THERMAL POWER STATION		APPROVED BY : UKR	
CONSULTANT  TATA CONSULTING ENGINEERS LIMITED BANGALORE INDIA		STCPL DRG NO. 760-EDD-003 BLD DRG NO. PEV-147-155N02 DATE 25/01/2020 REV. NO. 01 SSB DATE 30/08/2018 DESCRIPTION SCALE AS SHOWN DRAWN	
<small>THIS DRAWING IS THE PROPERTY OF SPECTRUM Techno Consultants Pvt Ltd. IT IS SUBJECT TO THE RECALL AND MUST NOT BE COPIED OR REPRODUCED WITHOUT THE WRITTEN PERMISSION.</small>			

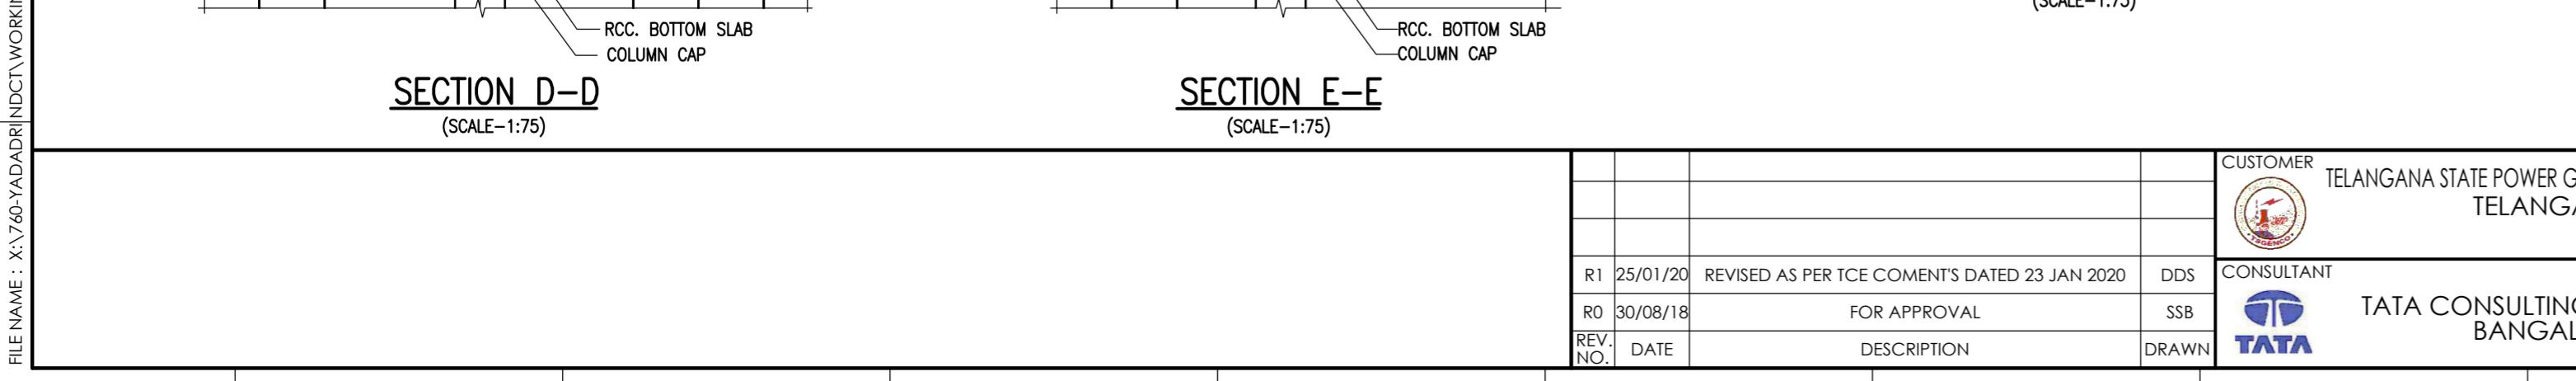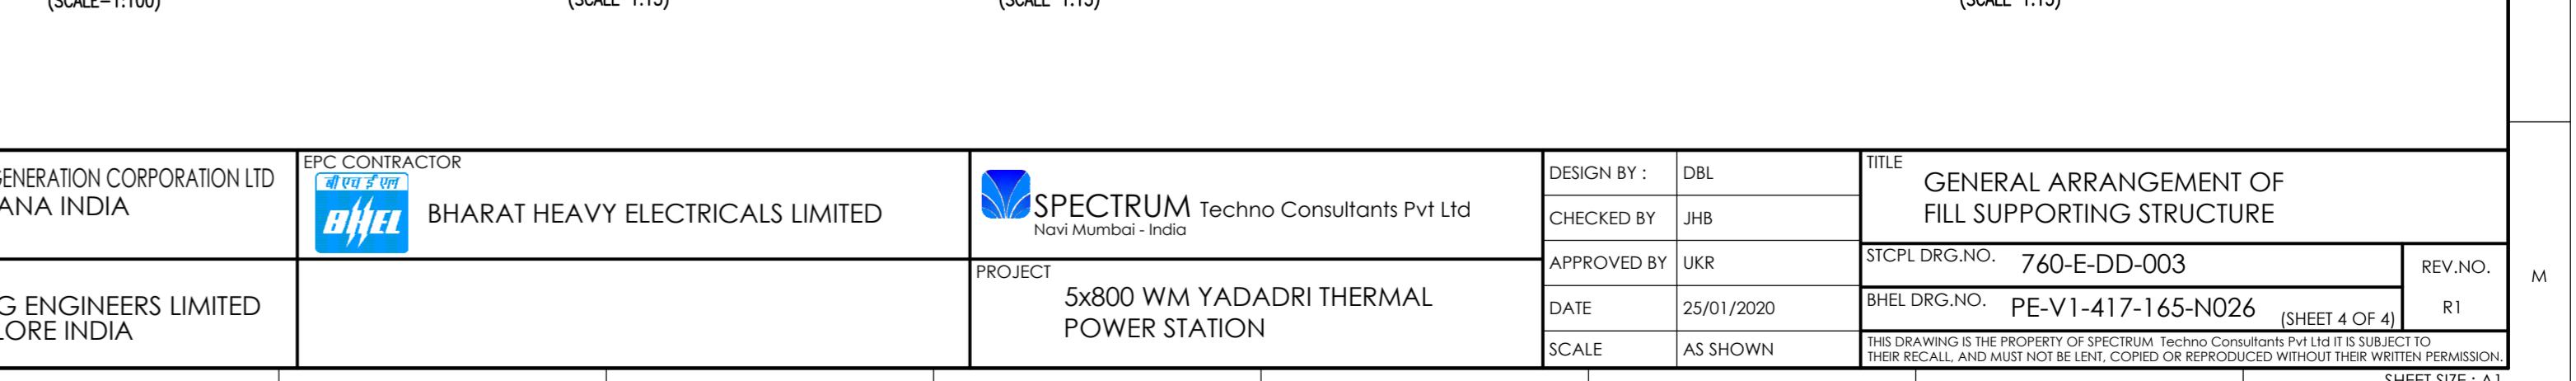

NOTES:

1. ALL DIMENSIONS ARE IN MILLIMETERS AND LEVELS ARE IN METER UNLESS OTHERWISE SPECIFIED.
2. DIMENSIONS ARE NOT TO BE SCALED. ONLY WRITTEN DIMENSIONS ARE TO BE FOLLOWED.
3. ANY LOOSE SOIL,PACKETS,ETC. BELOW FOOTING SHALL BE REPLACED WITH PCC M10.
4. CONCRETE MIX M10 FOR P.C.C. WORKS, AS INDICATED.
5. CONCRETE GRADE
 - * FOOTING - M30
 - * PEDESTAL - M30
 - * POND WALL - M30
 - * RAKER COLUMN - M50
6. PEDESTALS SHALL BE KEPT LATERALLY SUPPORTED TILL THE CONCRETE IN ALL POND WALLS ACHIEVES ITS FULL STRENGTH.
7. RL.81.500 CORRESPONDS TO EL.(-)0.000 OF POWER HOUSE BUILDING
FGL = EL.(-)1.500 CORRESPONDS TO RL.80.000. IN THE COOLING TOWER AREA FOR CT#1 & CT#2 FGL = EL.(+)1.500 CORRESPONDS TO RL.83.000. IN THE COOLING TOWER AREA FOR CT#3 , CT#4 & CT#5
8. FIRST STAGE CONCRETING OF FOOTING SHALL BE DONE SIMULTANEOUSLY IN ALTERNATE SEGMENTS ALONG FULL CIRCUMFERENCE OR IN SELECTED FEW SEGMENTS.
9. SECOND STAGE CONCRETING SHALL BE DONE WHEN ADJACENT FIRST STAGE CONCRETE IS AT LEAST 7 DAYS OLD.
10. CONCRETE SURFACE AT CONSTRUCTION JOINT SHALL BE CHIPPED AND CLEARED WITH A WIRE BRUSH AND WELL WATERED FOR AT LEAST 3 HOURS PRIOR TO PLACING OF NEW CONCRETE. THE SURFACE SHALL THEN BE CLEARED WITH A WATER JET AND A NEAT CEMENT GROUT SHALL BE APPLIED OVER IT JUST BEFORE PLACING FRESH CONCRETE.
11. PCC FOR BASIN SLAB PORTION SHALL BE LAID ON WELL COMPACTED STRATA WITH MINIMUM 90% PROCTOR DENSITY.
12. ~~NDCT FOOTING, PEDESTAL, POND WALL & RAKER COLUMNS SHALL BE PAINTED WITH ONE COAT OF PRIMER AND TWO COATS OF WATER PROOF BITUMINOUS PAINT CONFORMING TO IS:3384 AND IS:9862 RESPECTIVELY.~~

REFERENCE DRAWING: (LATEST REVISION)

REFERENCE DRAWINGS (LATEST REVISION)


1. PE-V1-417-165-N001 --- GENERAL ARRANGEMENT OF NATURAL DRAFT COOLING TOWER
2. PE-V1-417-165-N033 --- EXCAVATION LAYOUT OF NDCT
3. PE-V1-417-165-N035 --- REINFORCEMENT DETAILS OF NDCT FOUNDATION, PEDESTAL & POND WALL
4. PE-V1-417-165-N036 --- CONCRETE DIMENSION OF RAKER COLUMN
5. PE-V1-417-165-N037 --- REINFORCEMENT DETAILS OF RAKER COLUMN
6. PE-V1-417-165-N038 --- SHELL PROFILE AND THICKNESS
7. PE-V1-417-165-N044 --- CONCRETE DIMENSIONS DETAILS OF BASIN FLOOR


LEGENDS

LEGENDS

FGL - FINISH GROUND LEVEL
CJ - CONSTRUCTION JOINT
TYP - TYPICAL
PD - PEDESTAL
£ - CENTER LINE
EL - ELEVATION LEVEL
WP - WORKING POINT
EJ - EXPANSION JOINT

FILE NAME : X:\760-YADADRI			CUSTOMER  TS GENCO TELANGANA STATE POWER GENERATION CORPORATION LTD 401, Raikar Bhawan, Plot No. 9, Sector 17, Vashi, Navi Mumbai 400705 India. Email: info@spectrumworld.net		EPC CONTRACTOR  BHEL SPECTRUM Techno Consultants Pvt Ltd TELANGANA INDIA		TITLE CONCRETE DIMENSION OF INDOCT FOUNDATION, BHARAT HEAVY ELECTRICALS LIMITED PEDESTAL & POND WALL (STAGE 2)		
			DRAWN BY : SPP		CHECKED BY : JIB				
			APPROVED BY : LKR		STCPL DRG. NO. : 760-E-ED-004				
			CONSULTANT  TATA CONSULTING ENGINEERS LIMITED BANGALORE INDIA		BHEL DRG. NO. : PE-V1-417-15-034 (SHEET 47)				
FILE NAME : X:\760-YADADRI	DATE : 26/12/18	DESCRIPTION : BASED ON CUSTOMER COMMENTS TRANSMITTAL NO: TCE.11005A-CV-VDT-071	DRAWN : SPP	DATE : 26/12/2018	SCALE : AS SHOWN	REV. NO. : R0	DATE : 11/09/18	DESCRIPTION : FOR APPROVAL	REV. NO. : R1

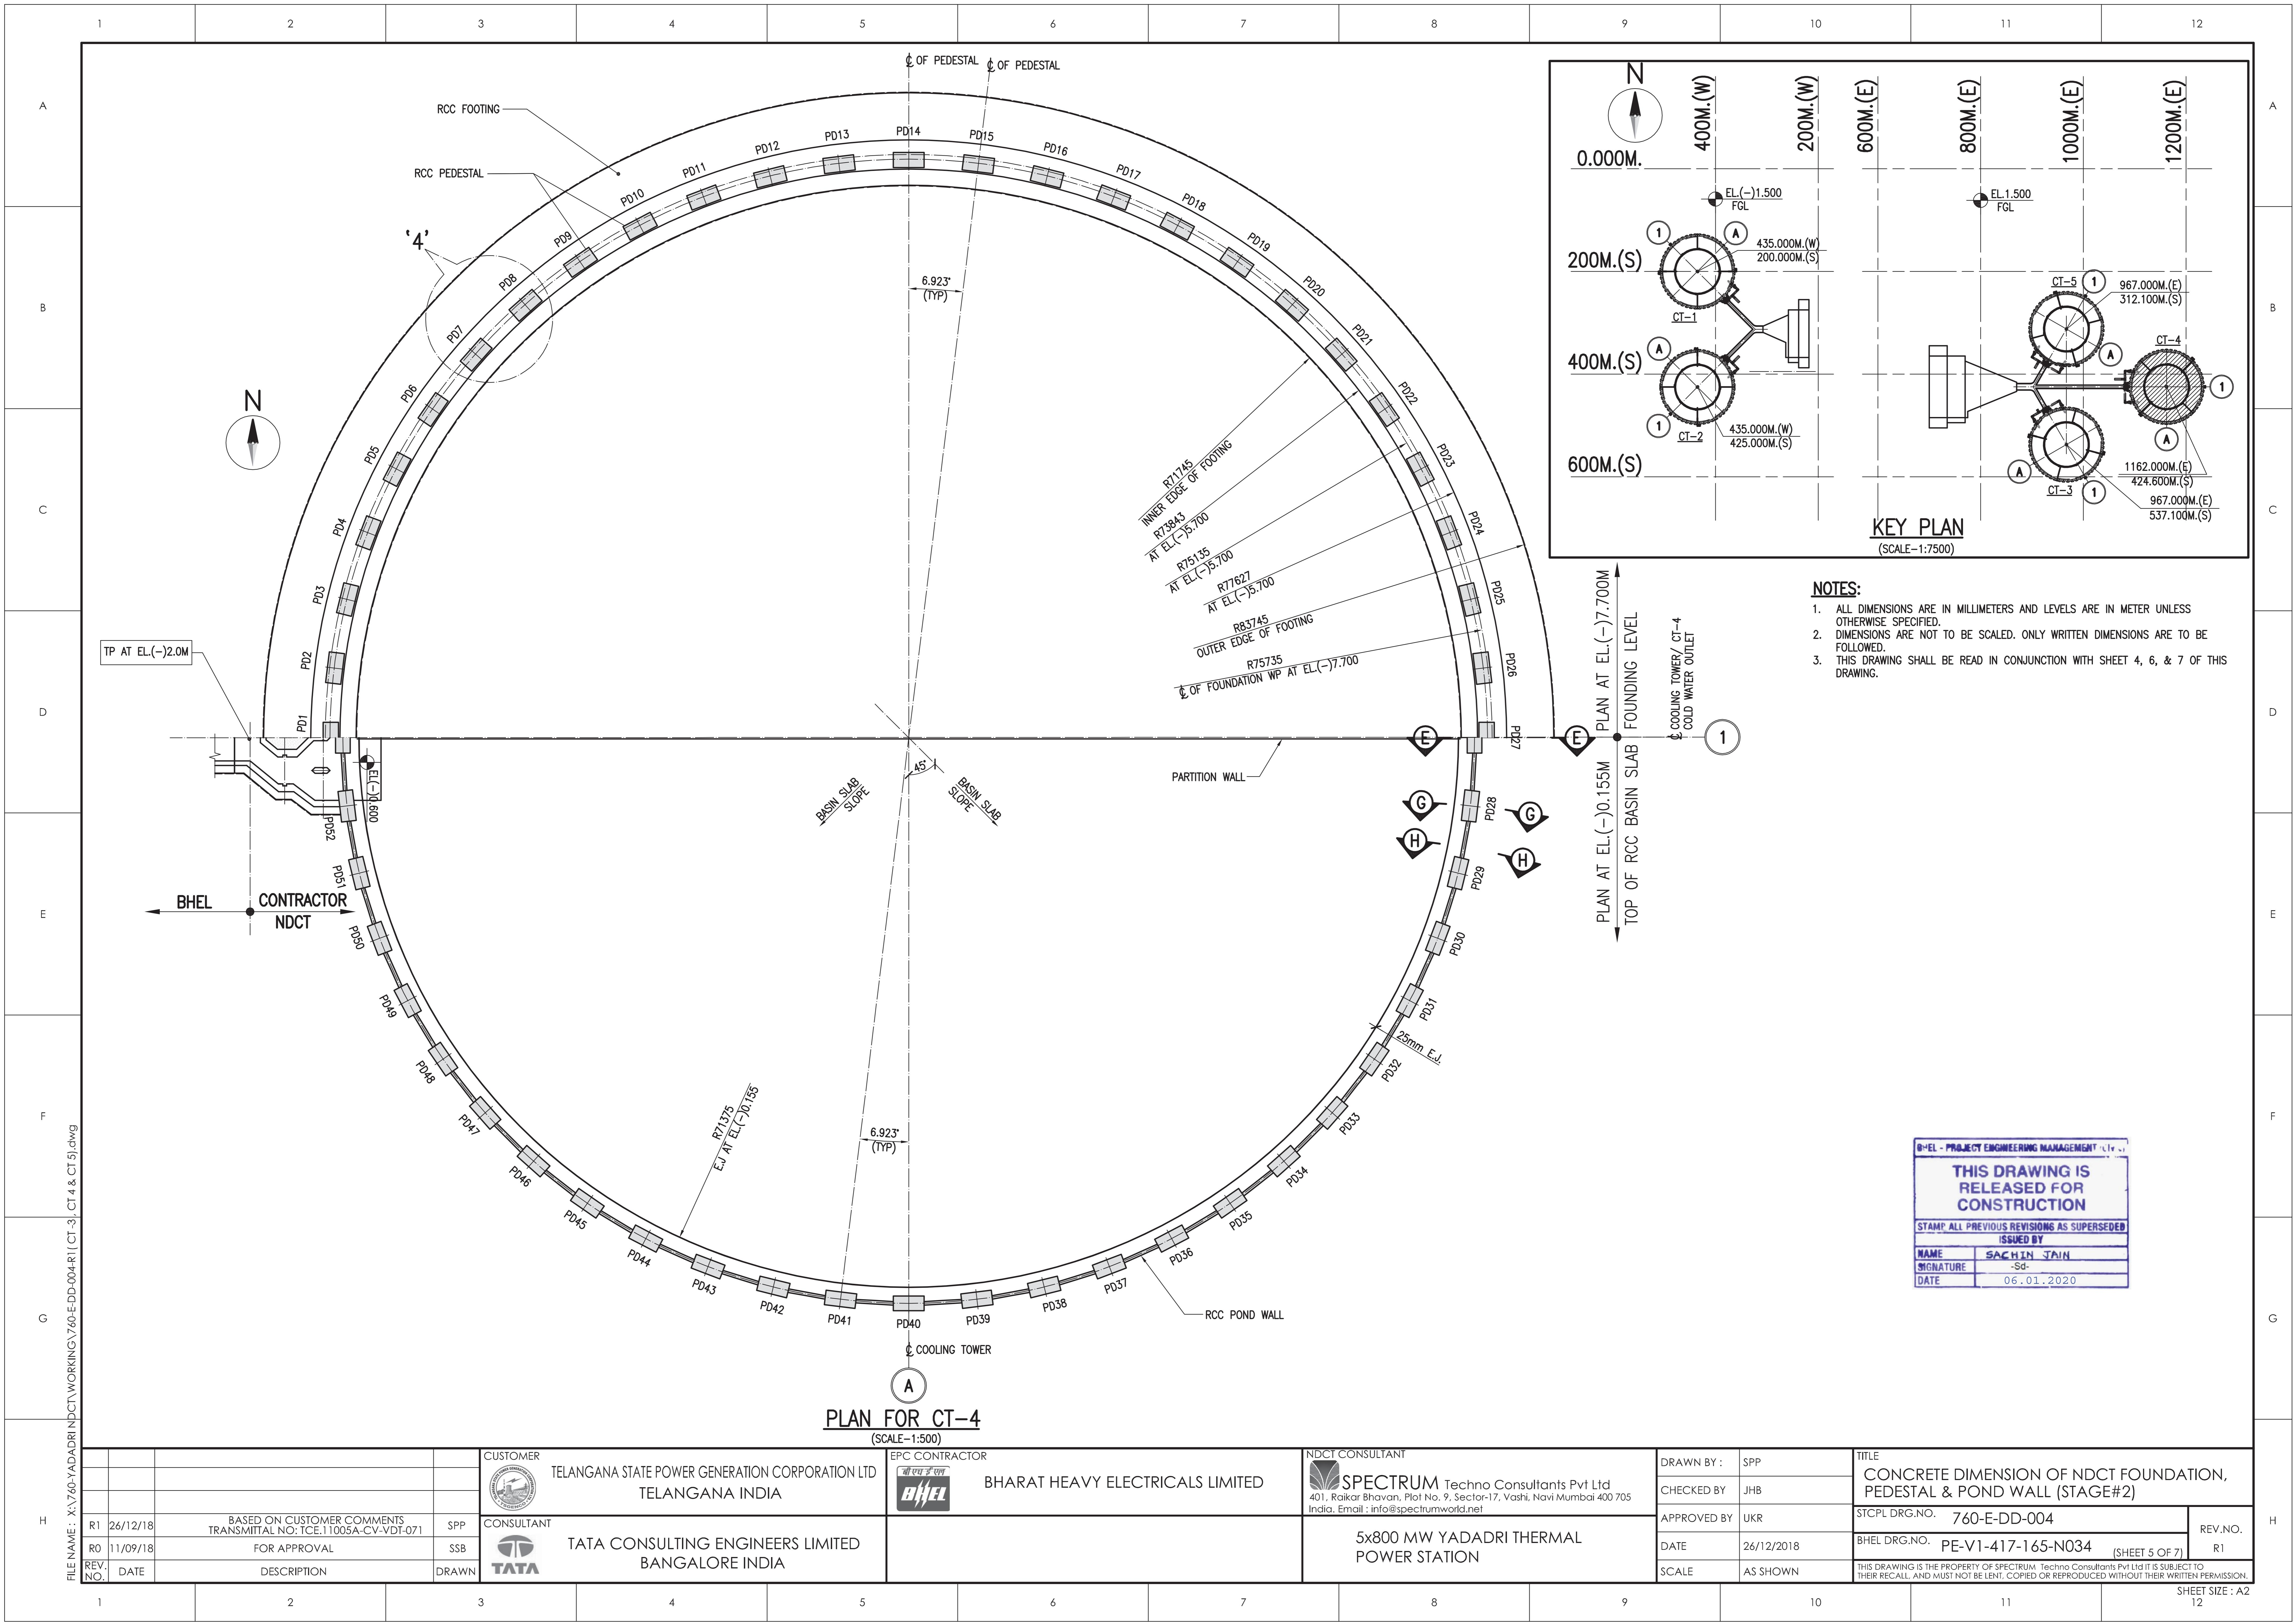

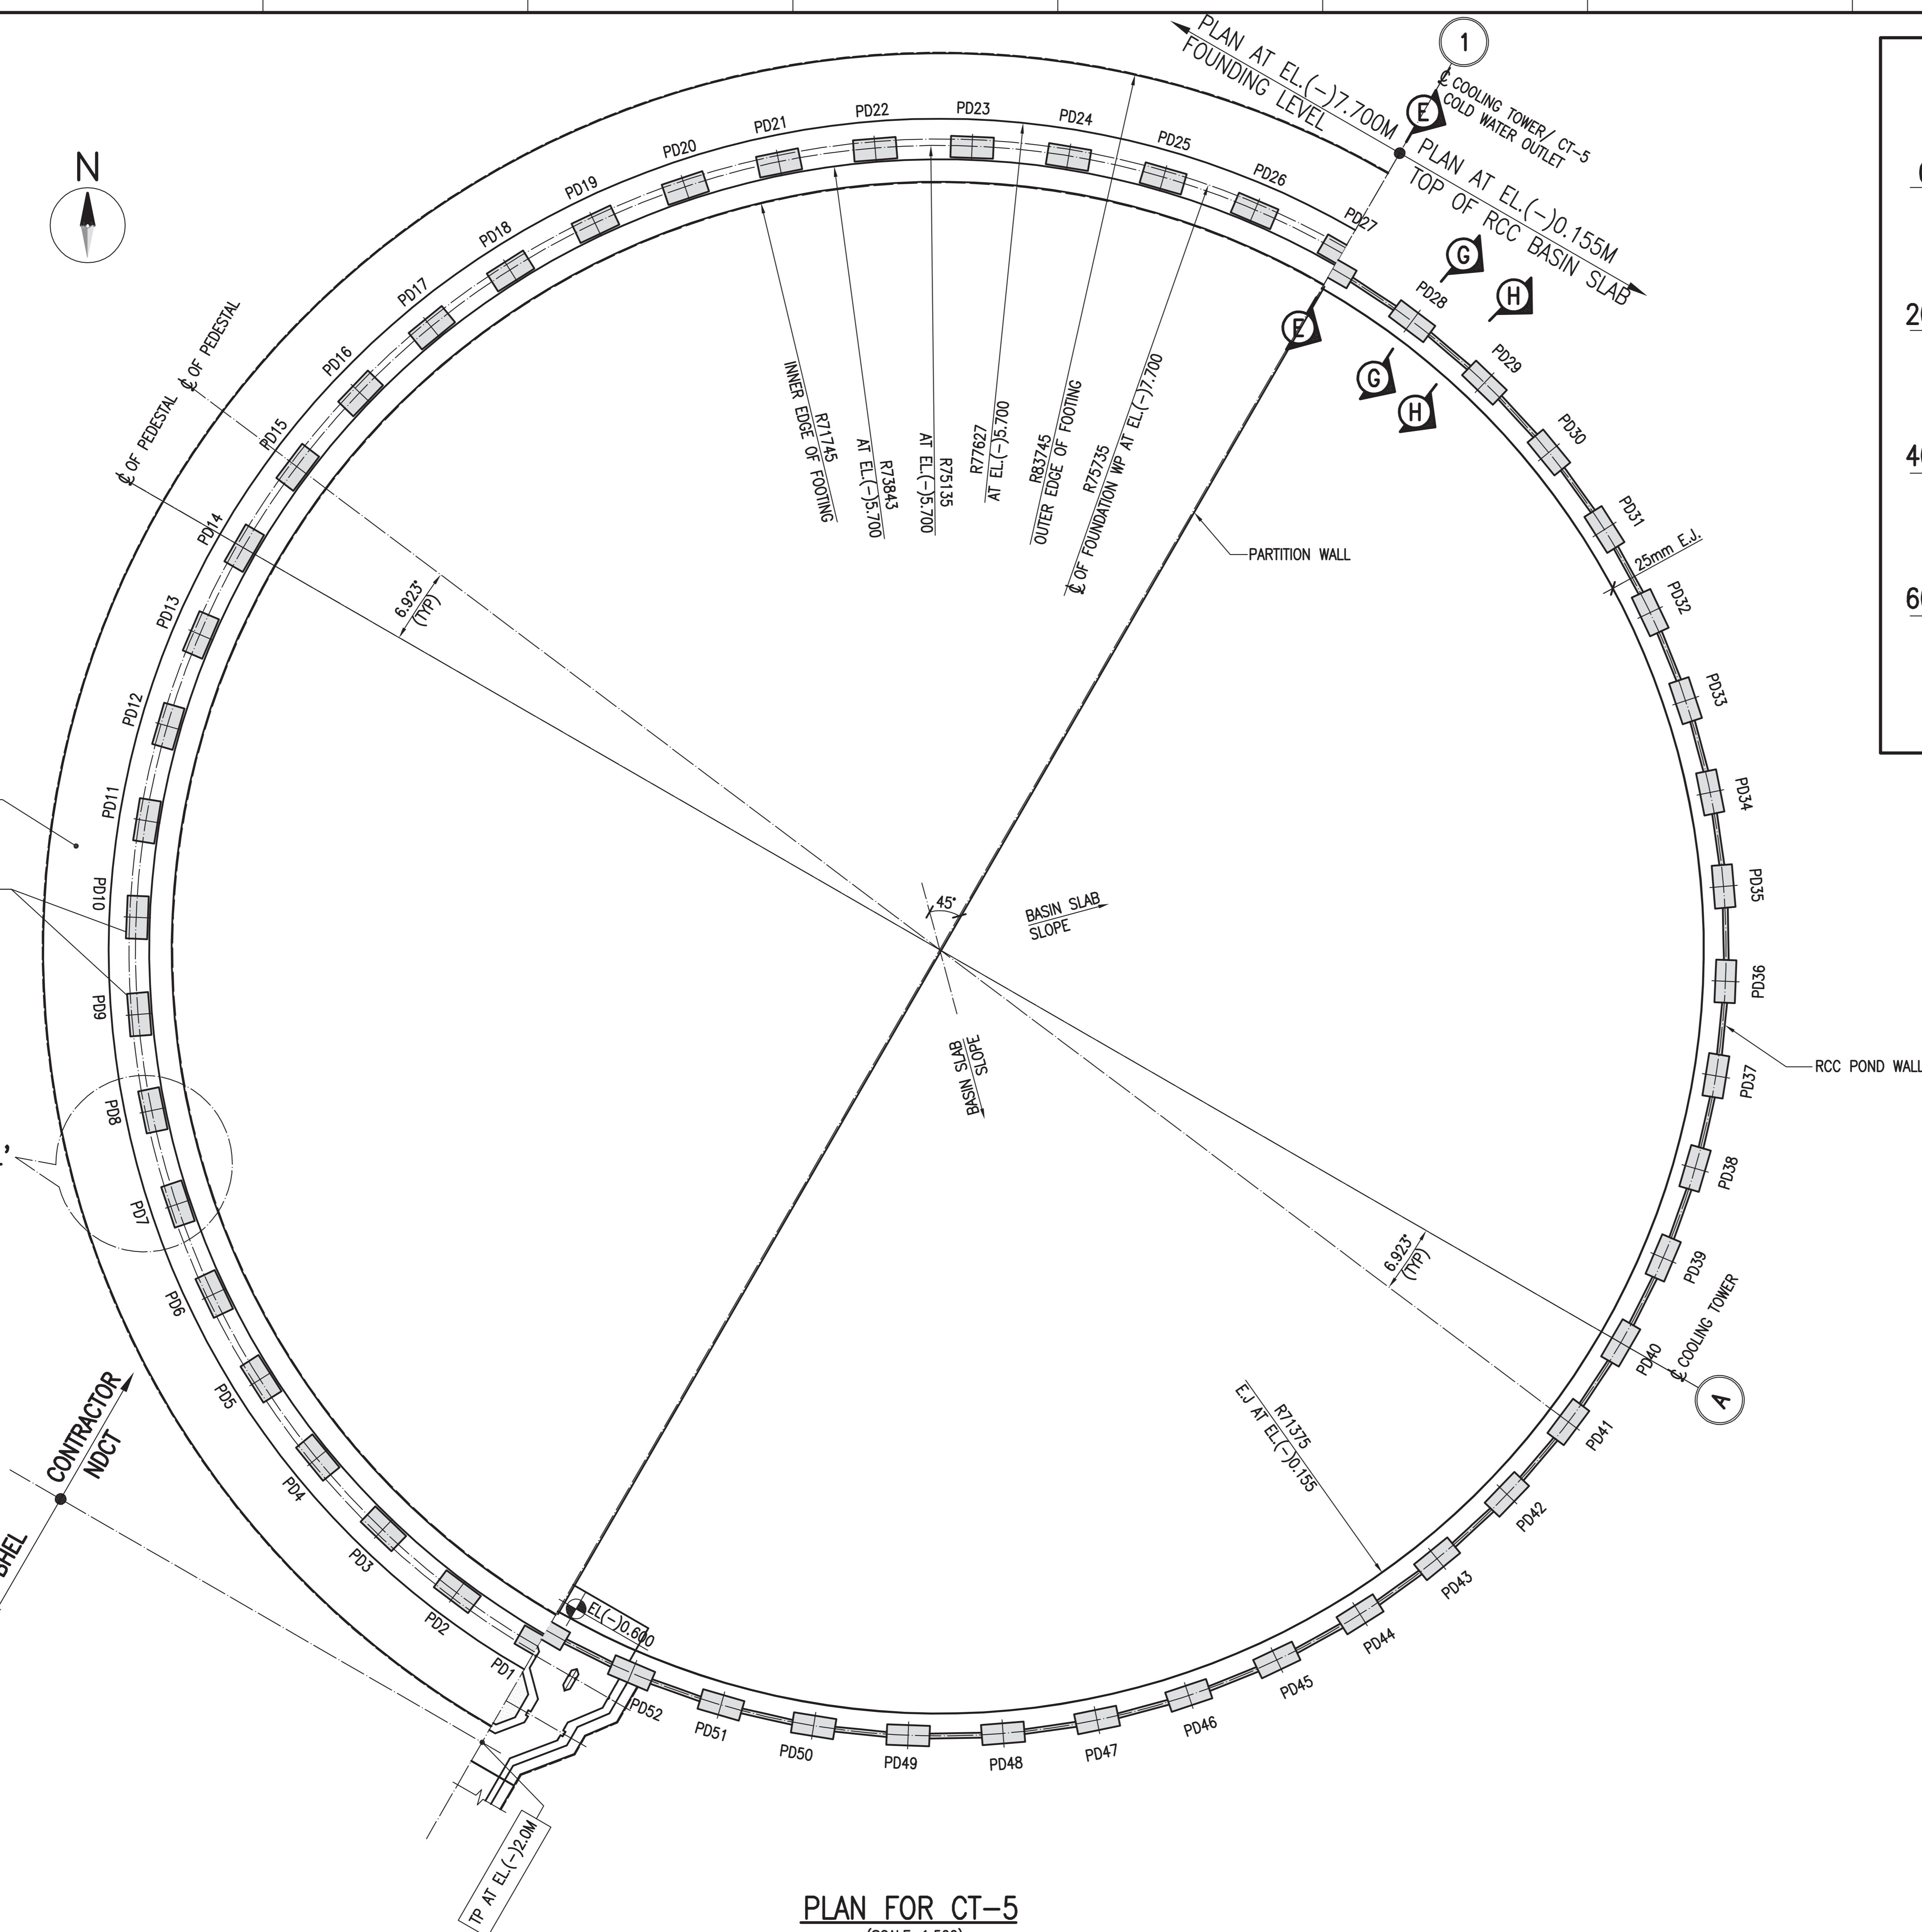

PLAN FOR CT-5

FILE NAME : X:\760-YADADRI NDCT\WORKING\760-E-DD-004-R1(CT -3, CT 4 & CT 5).dwg

R1	26/12/18	BASED ON CUSTOMER COMMENTS TRANSMITTAL NO: TCE.11005A-CV-VDT-071	SPP
R0	11/09/18	FOR APPROVAL	SSE
REV. NO.	DATE	DESCRIPTION	DRAW

CUS

STOMER

TELANGANA STATE POWER GENERATION CORPORATION

TELANGANA INDIA

N LTD

EPC CONTRACTOR

 BHARAT HEAVY ELECTRICALS LIMITED

NDCT CONSULT
 SPEC
401, Raikar Bhawan
India. Email : info@ndct.com

SPECTRUM Techno Consultants Pvt Ltd
Plot No. 9, Sector-17, Vashi, Navi Mumbai 400 705
info@spectrumworld.net

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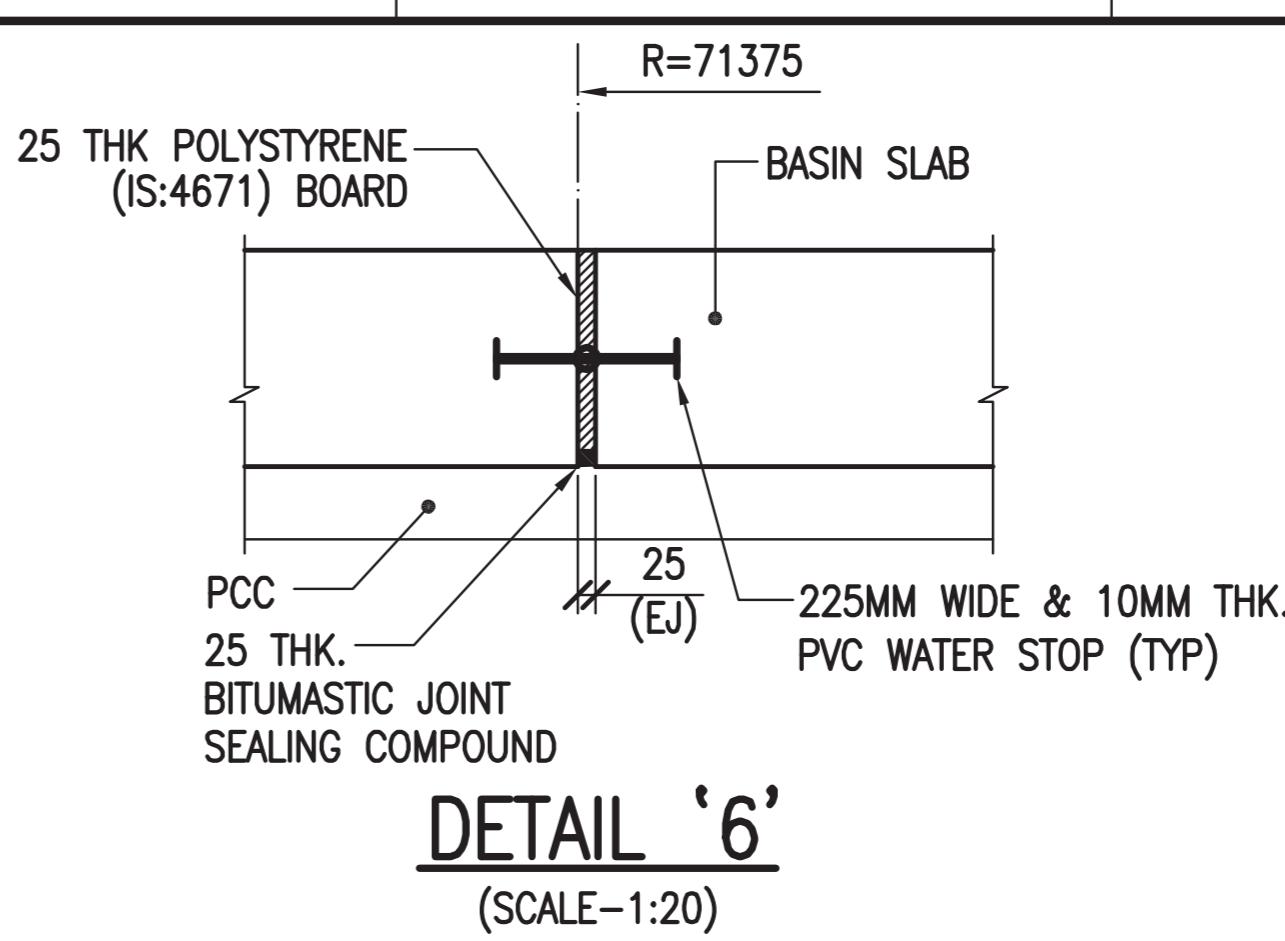
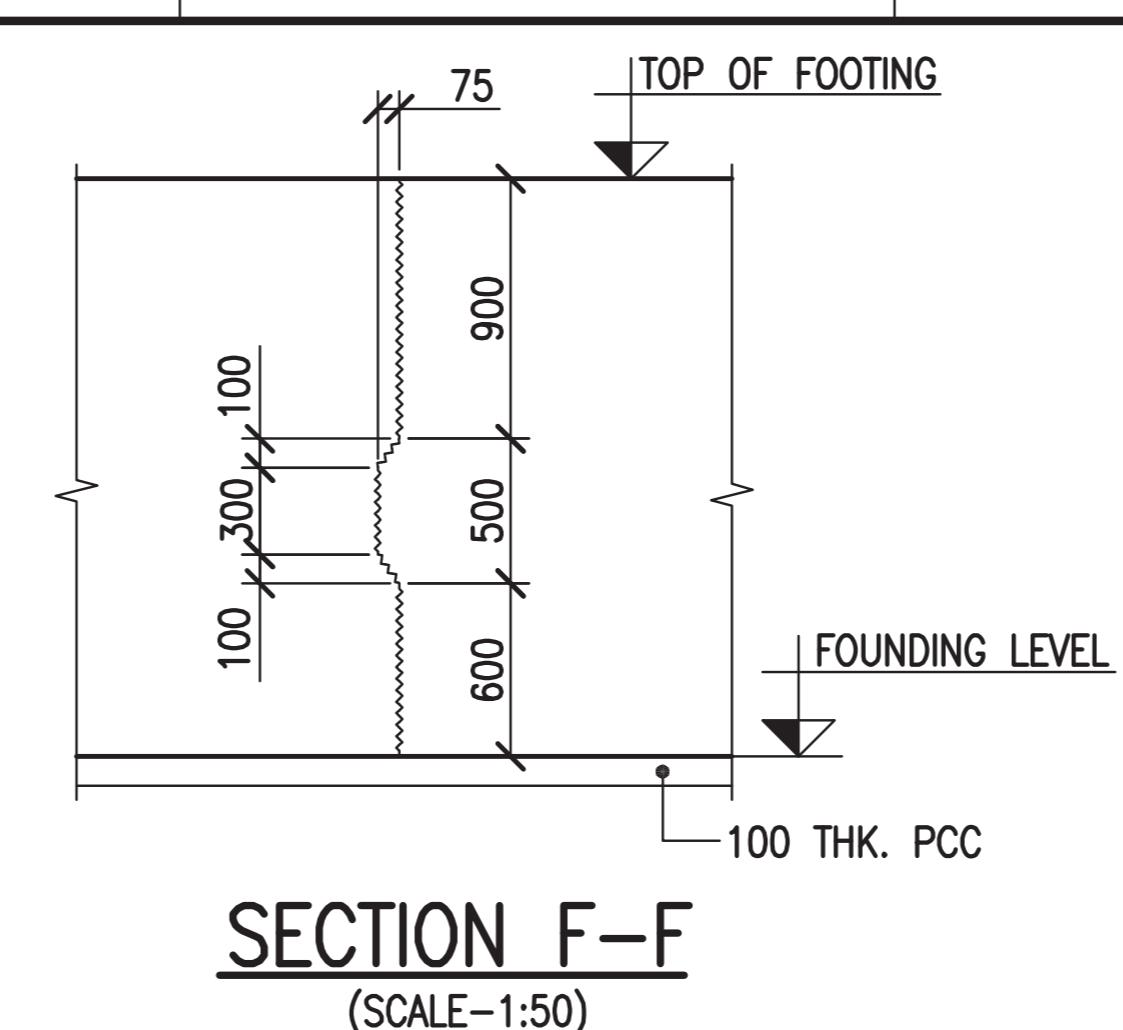
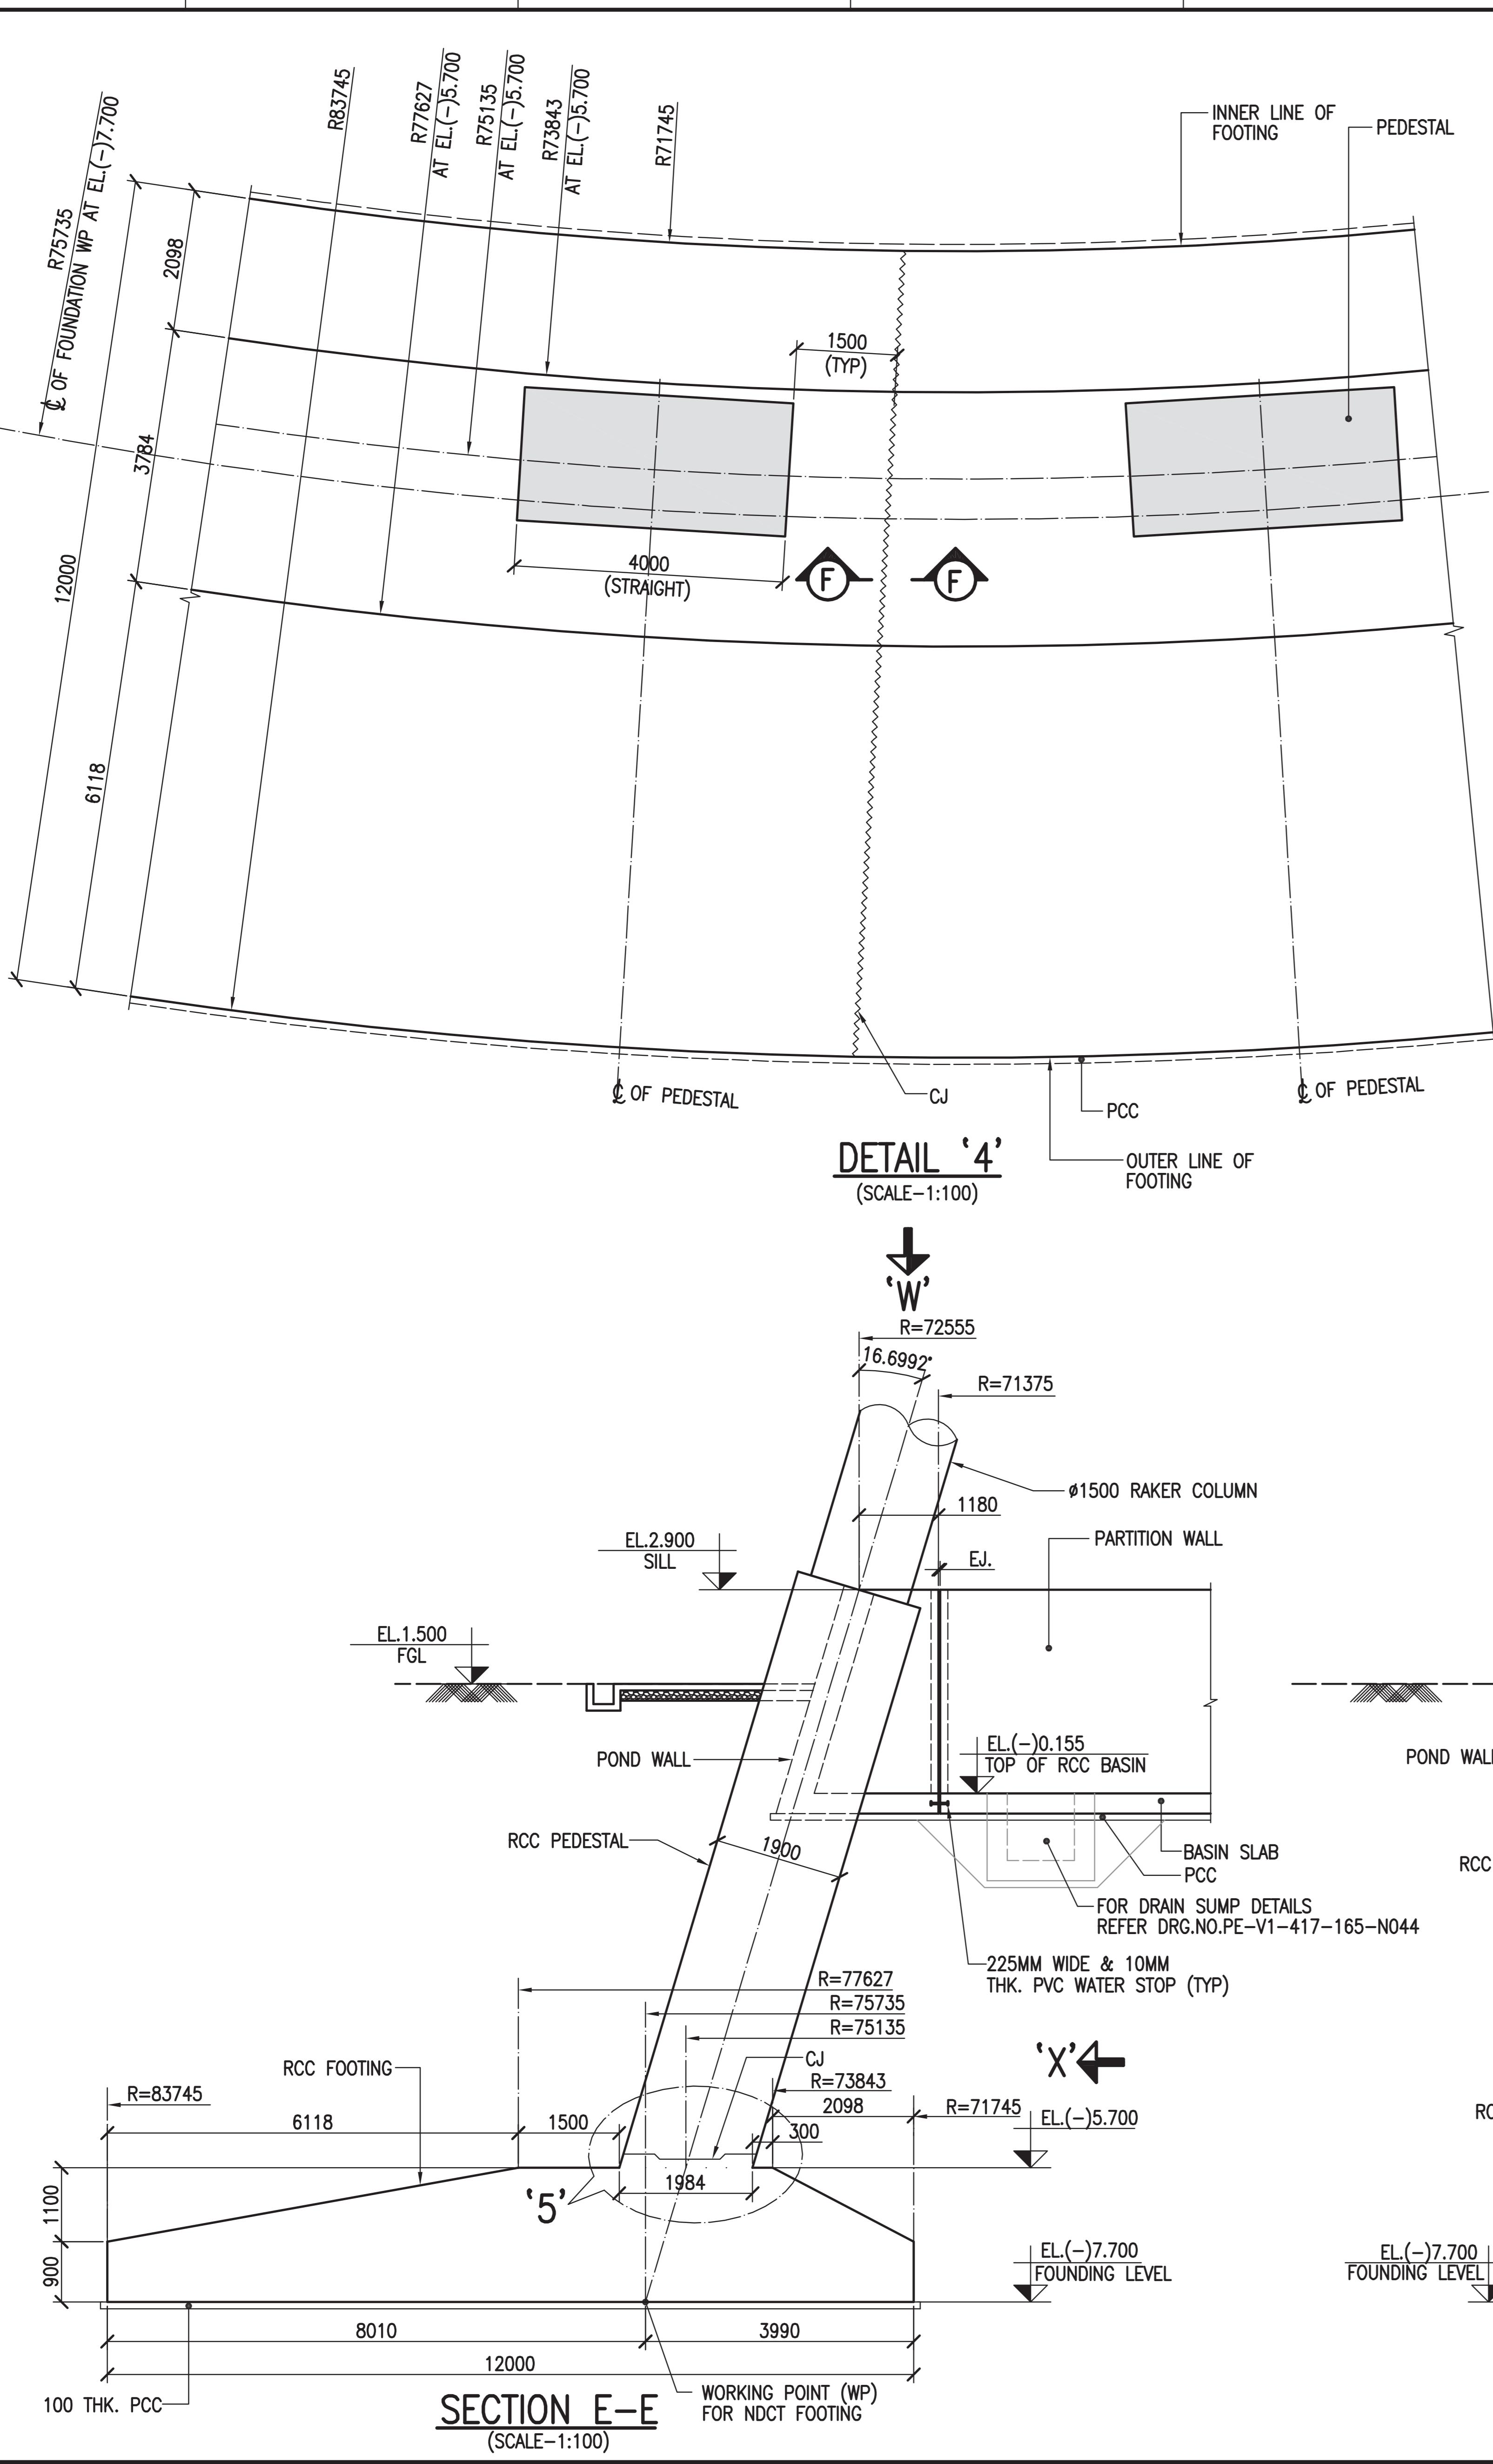
DOCT
GE#

CT FO
GE#2

THIS DRAWING IS RELEASED FOR CONSTRUCTION	
STAMP ALL PREVIOUS REVISIONS AS SUPERSEDED	
ISSUED BY	
NAME	SACHIN JAIN
SIGNATURE	-Sd-
DATE	06.01.2020

NOTES:

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- THIS DRAWING SHALL BE READ IN CONJUNCTION WITH SHEET 4, 5, & 7 OF THIS DRAWING.




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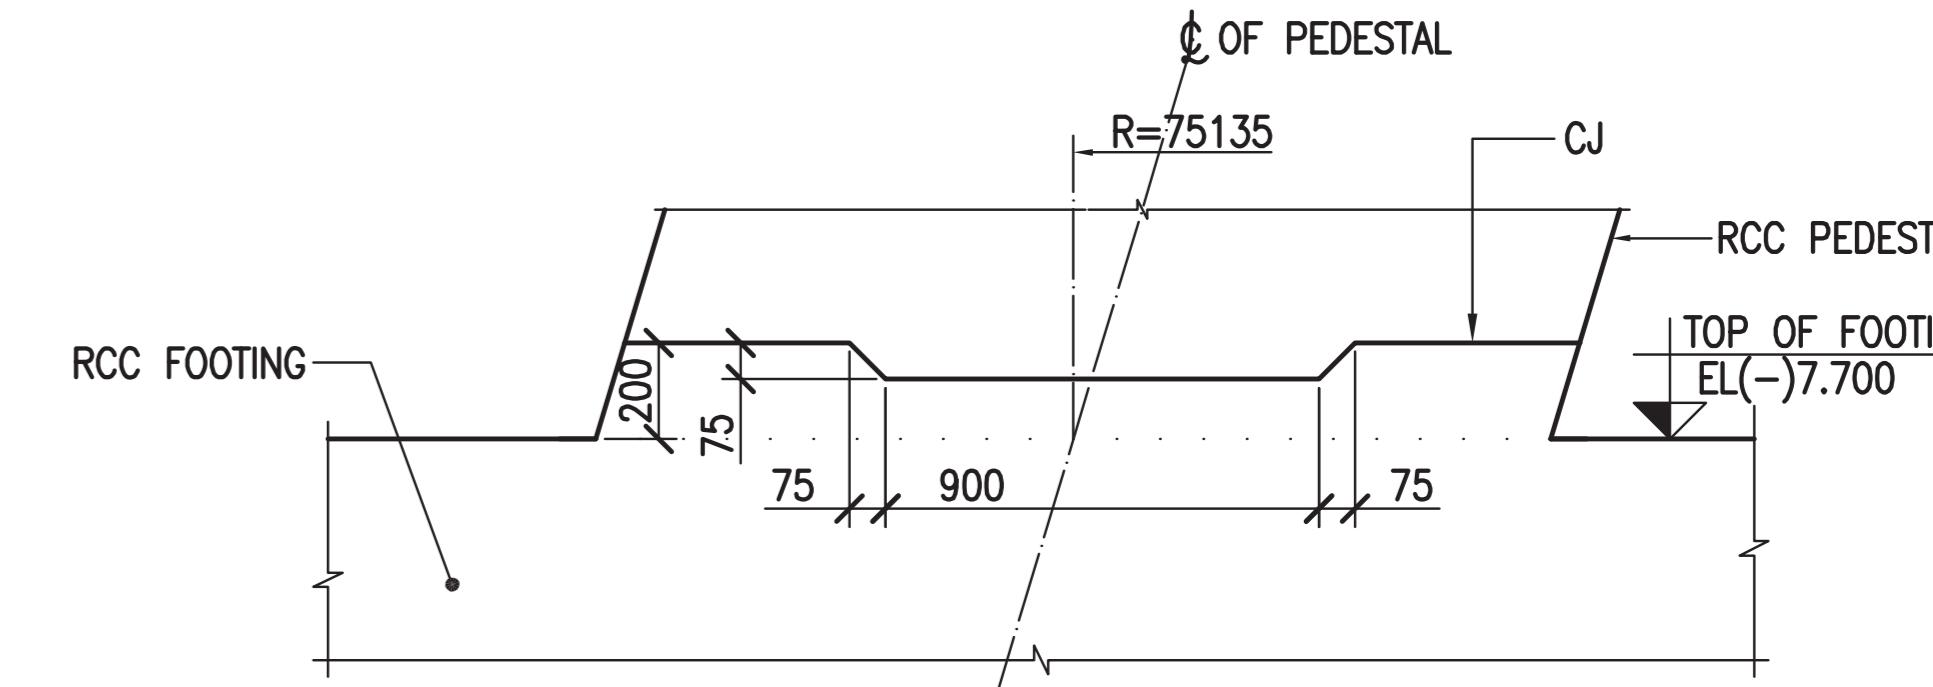
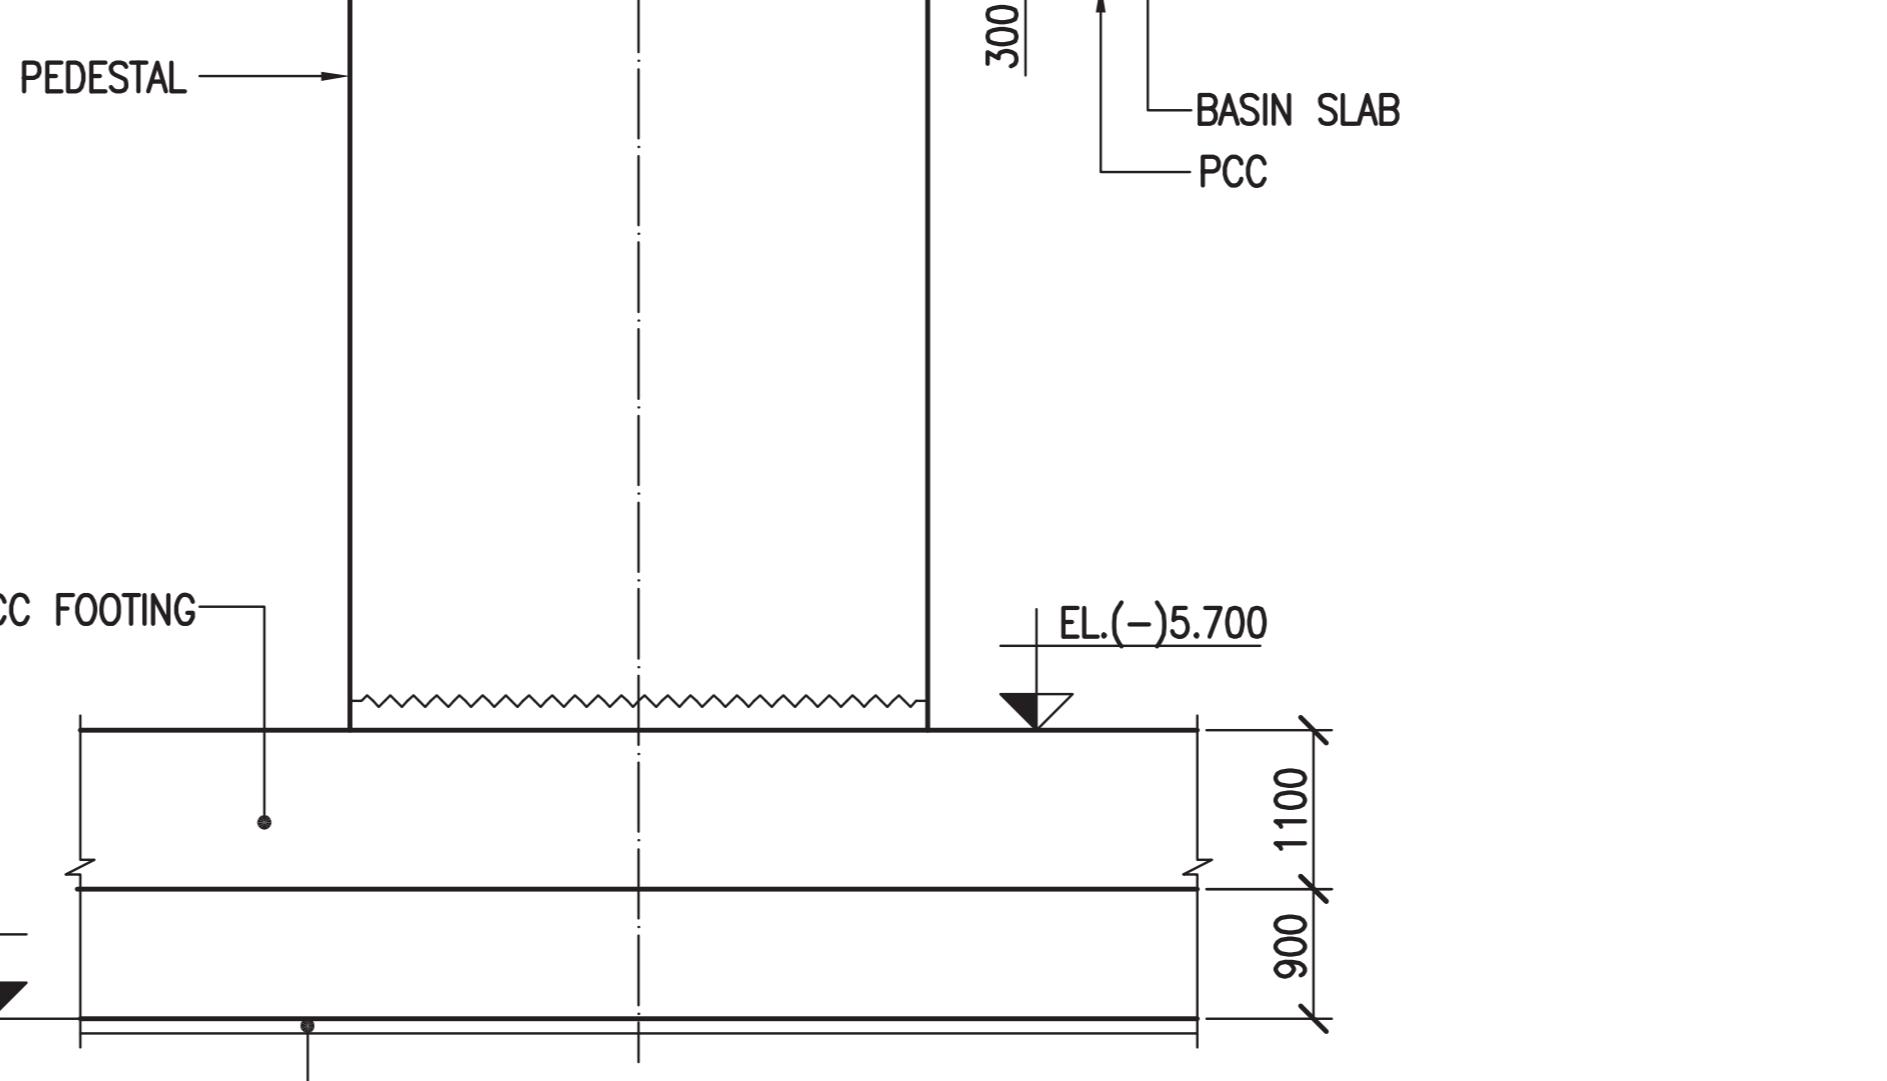
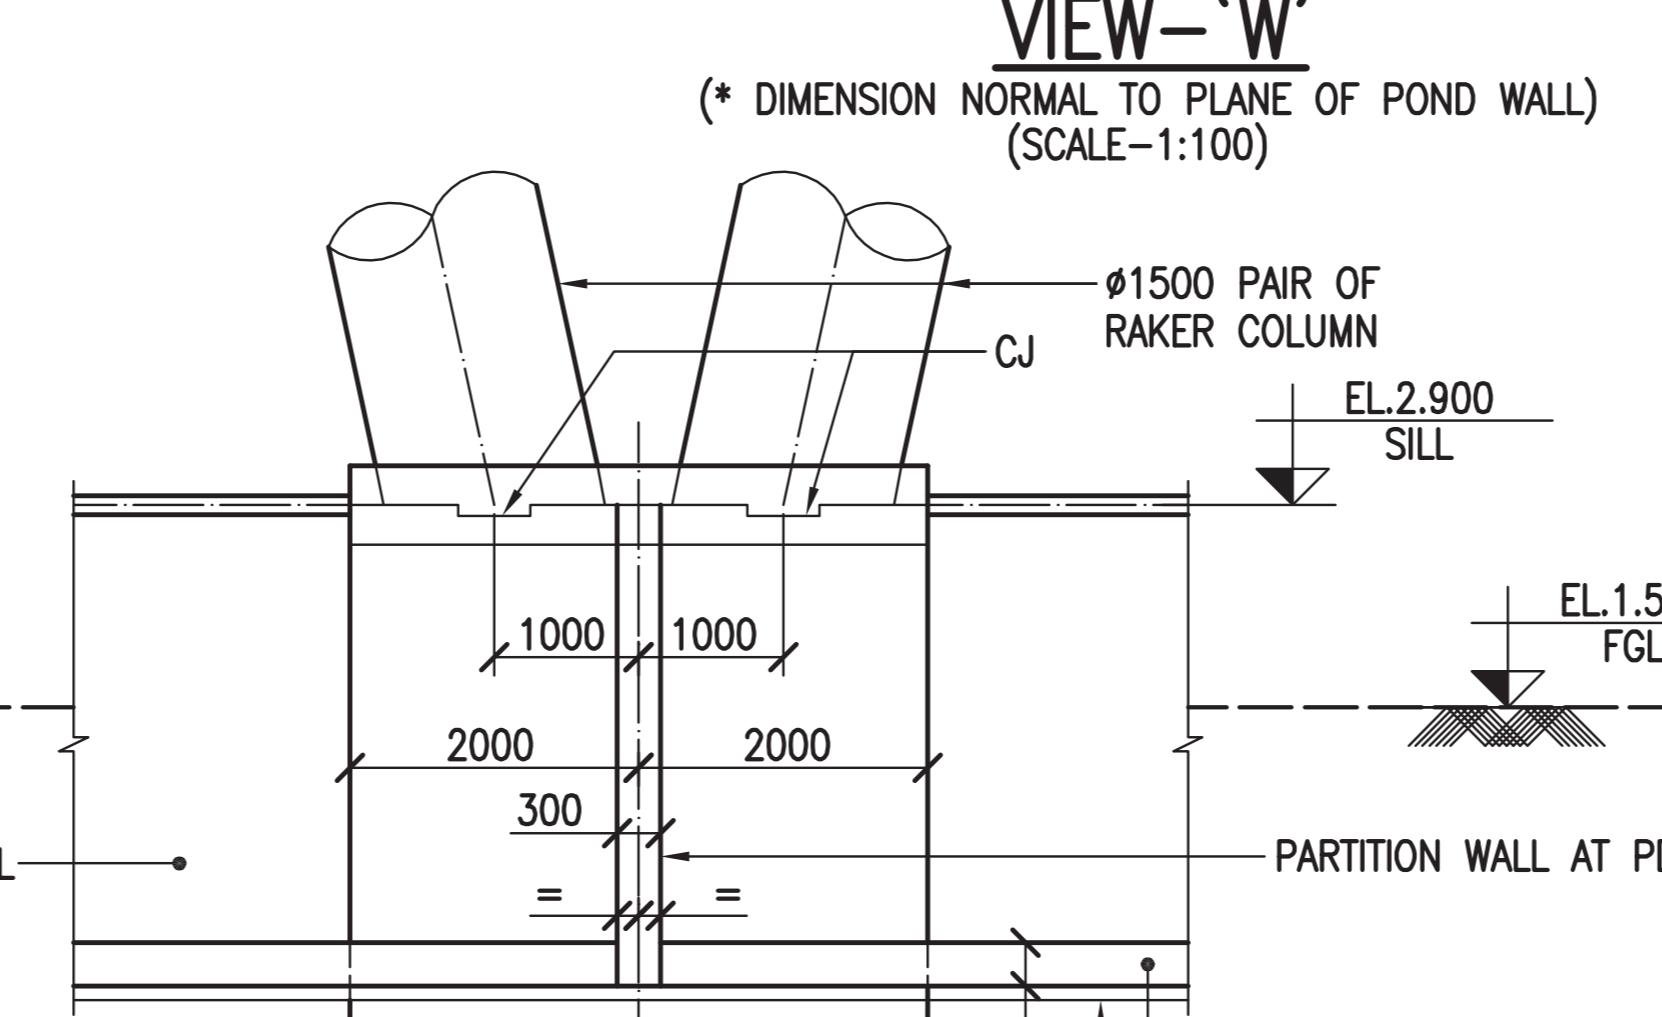
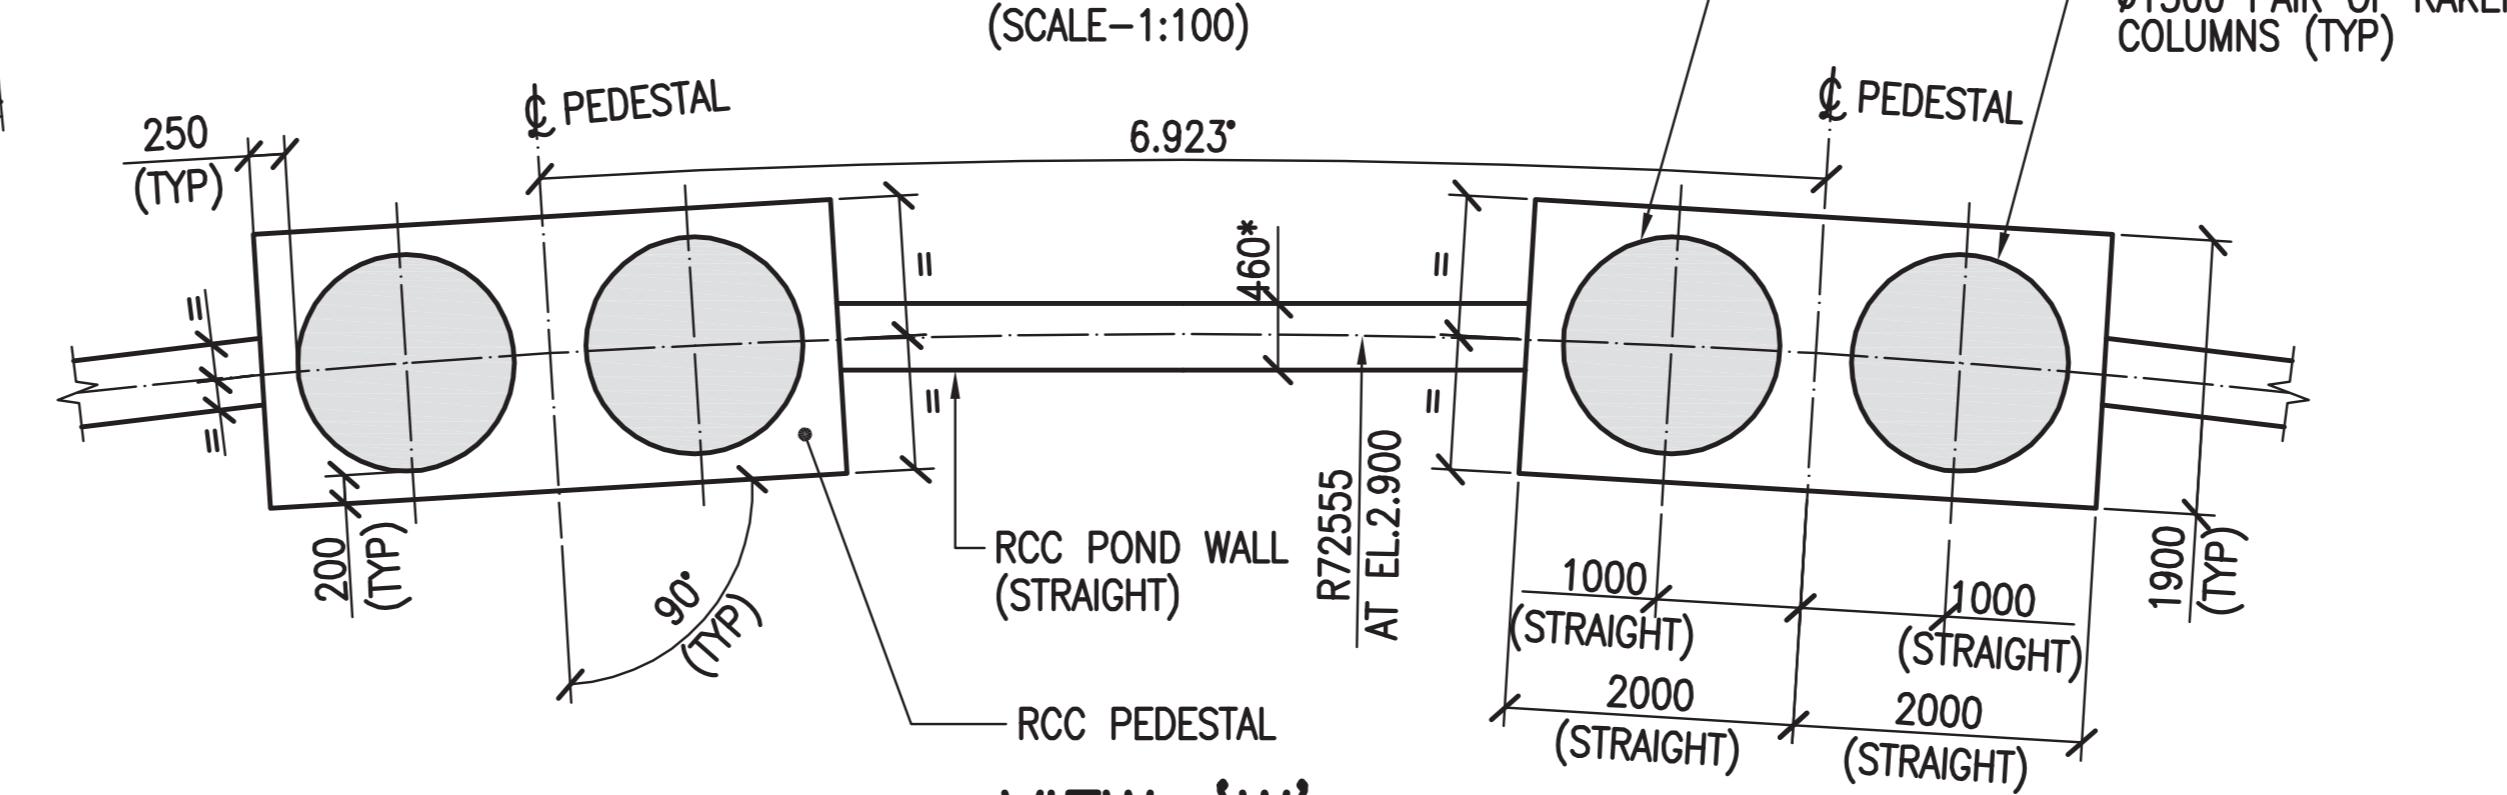
SCHEDULE OF QUANTITIES PER ONE NDCT

CONCRETE	CONCRETE GRADE	QUANTITIES (M ³)
P.C.C.	M10	600
FOOTING	M30	9470
PEDESTAL	M30	3550
POND WALL	M30	420




DETAILS OF CONSTRUCTION

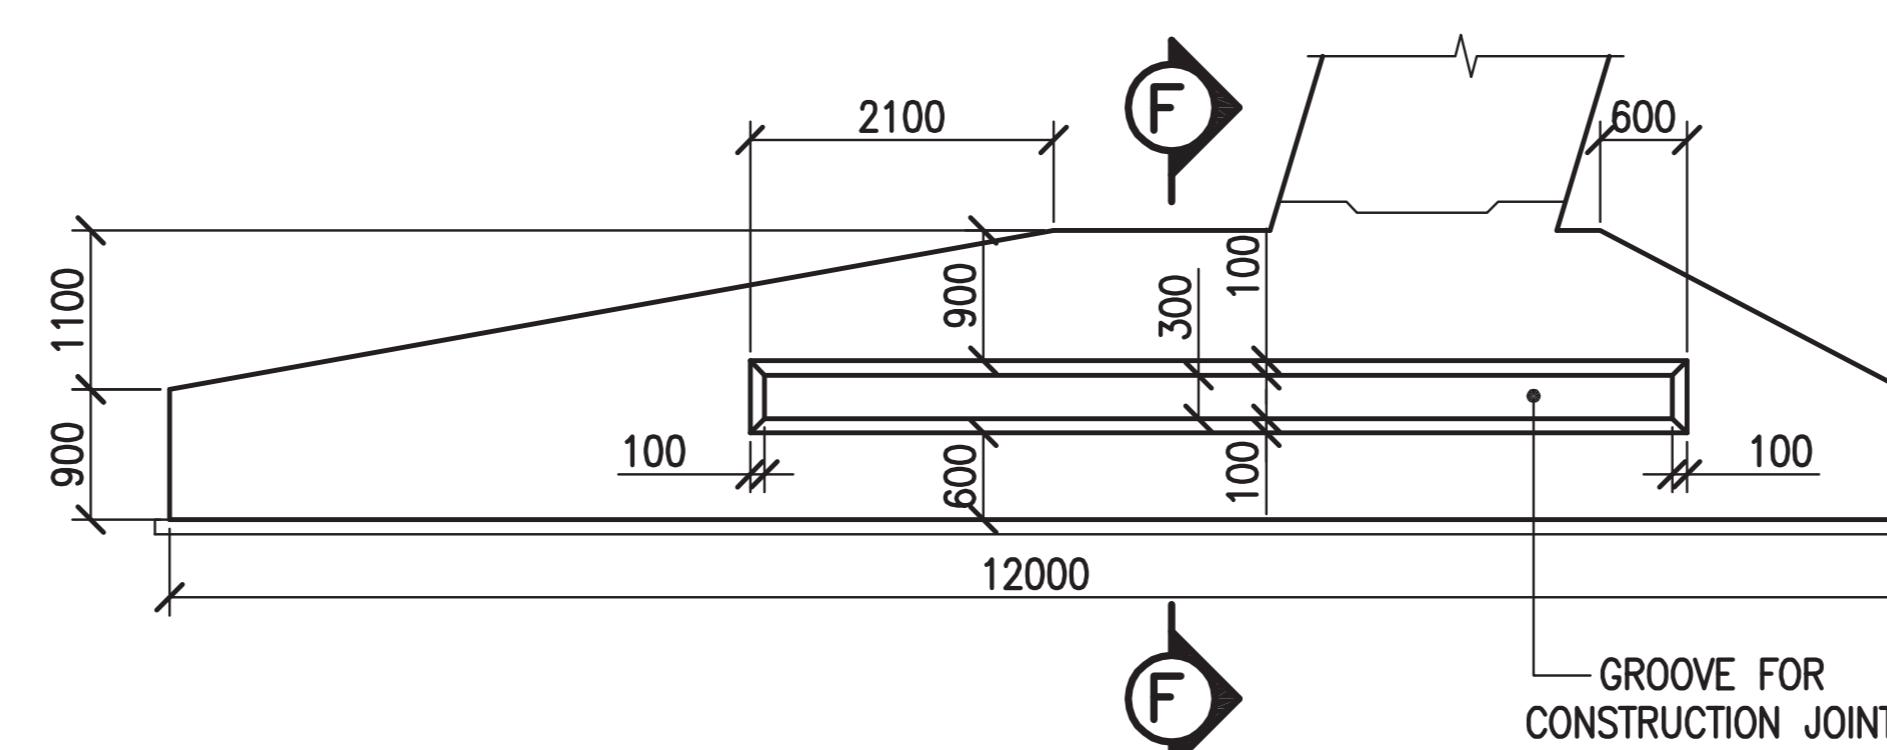
JOINTS IN FOOTING





DETAIL '5'

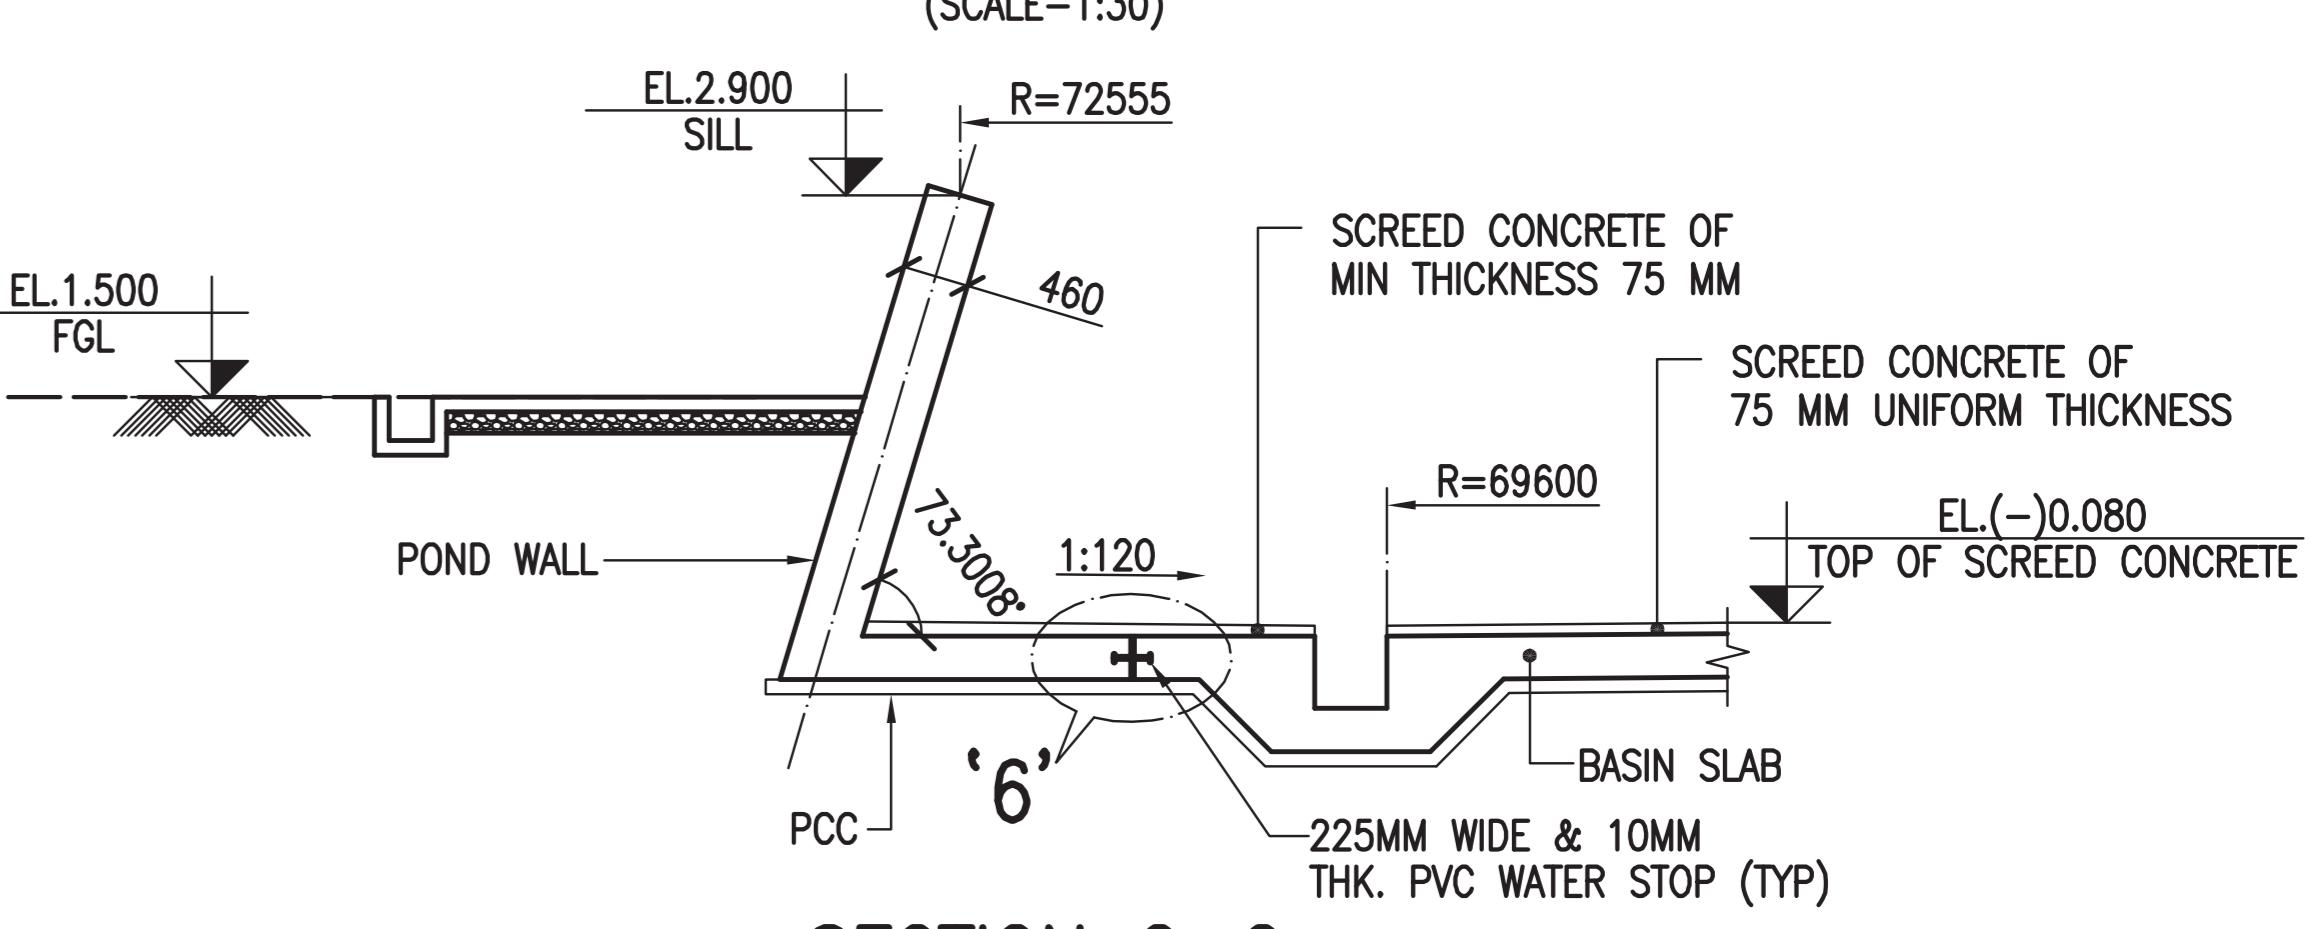

SECTION G-G

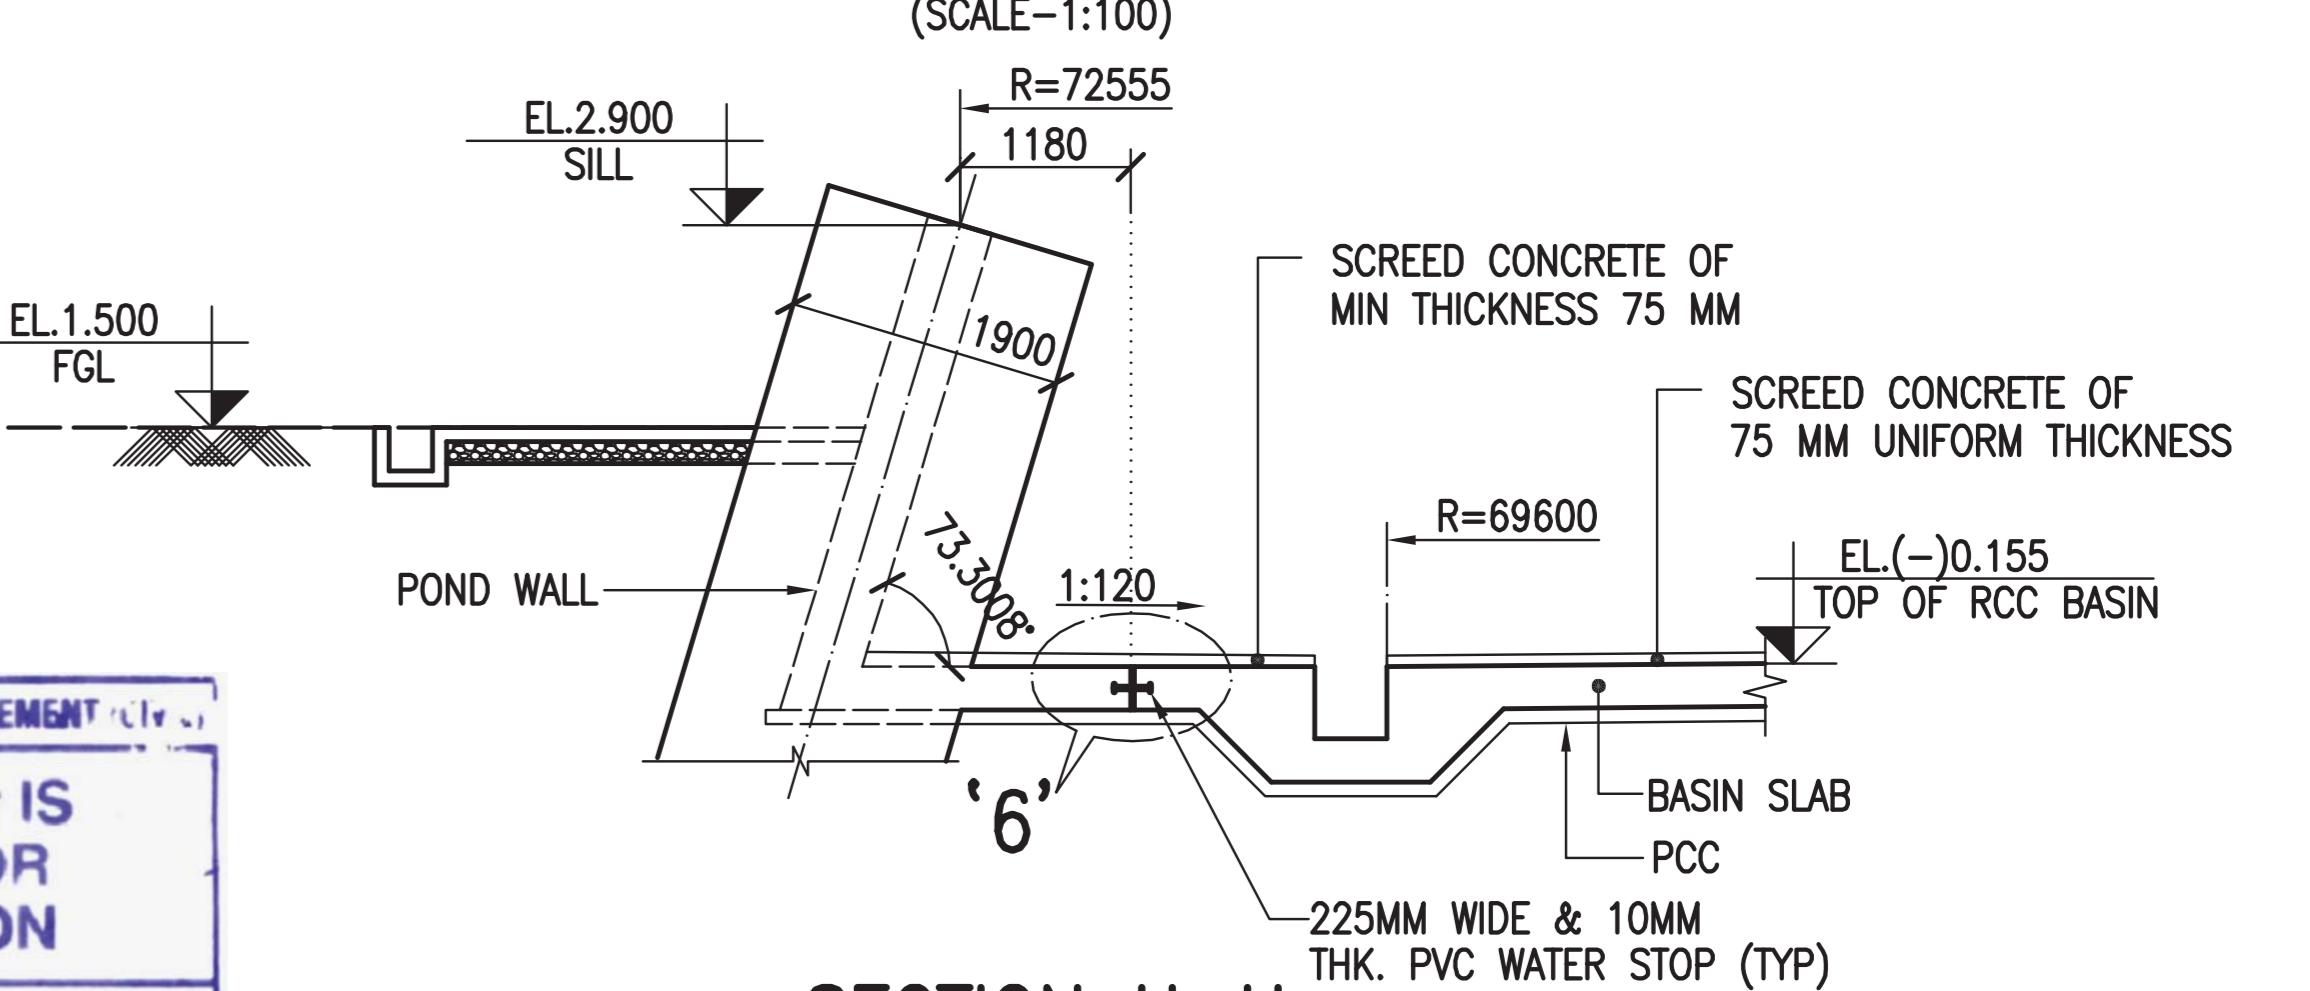

SECTION H-H

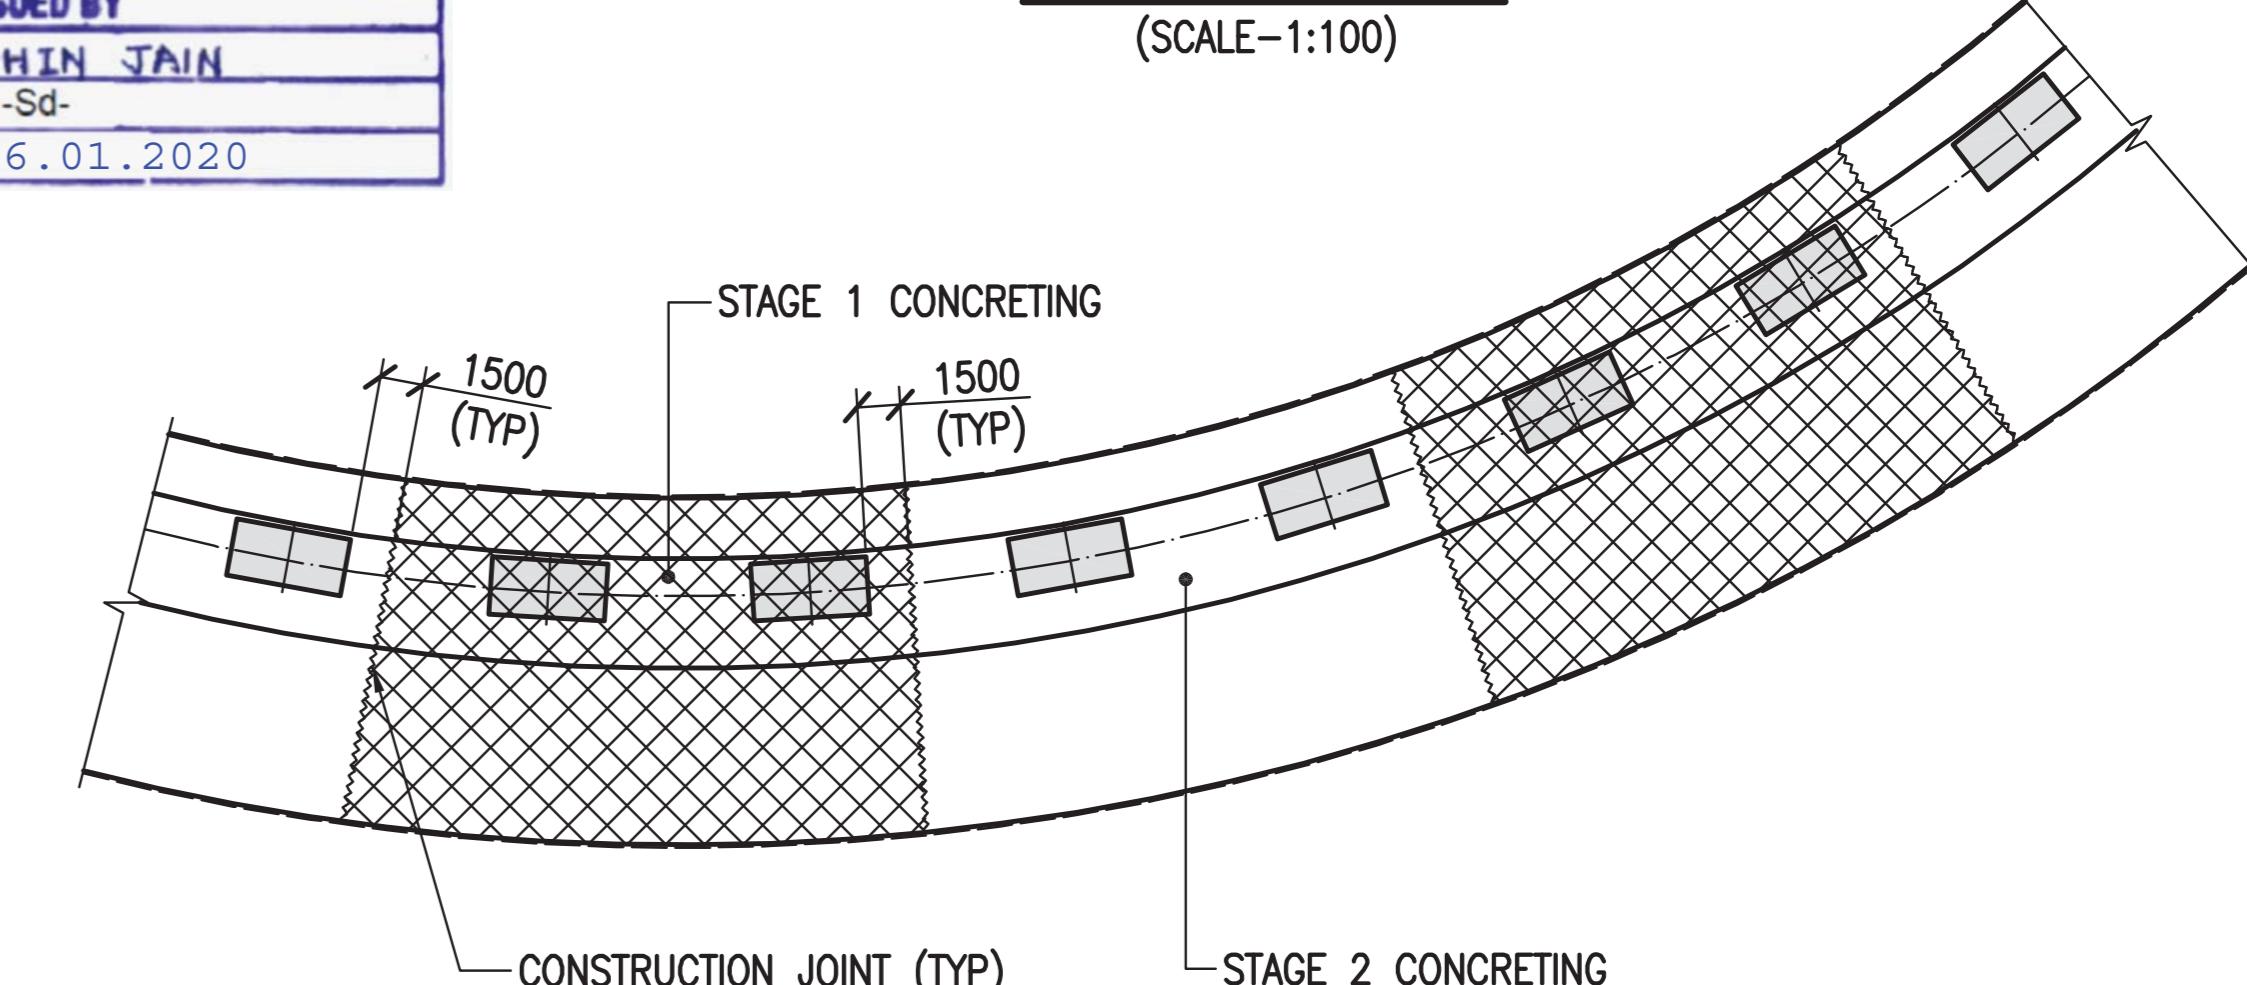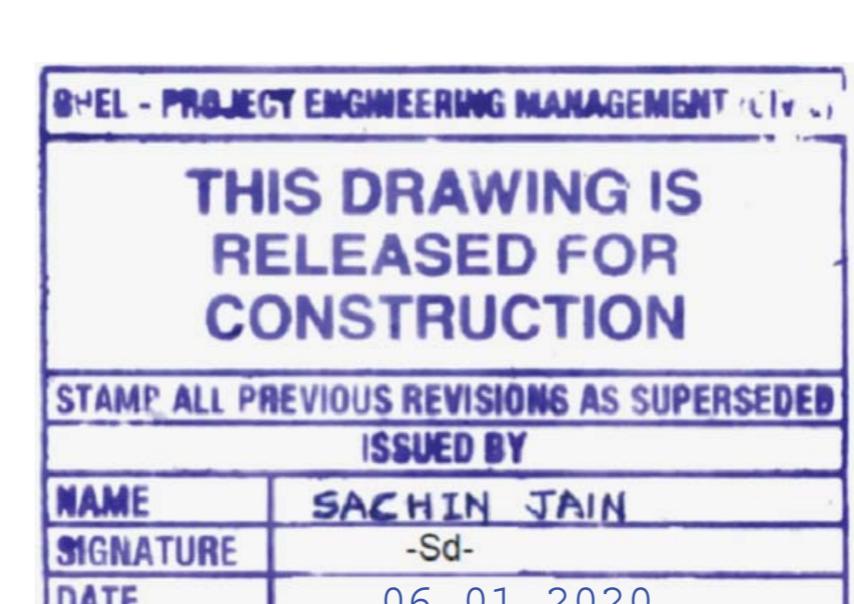

CONSTRUCTION JOINTS IN RING FOOTING

(SCALE-1:500)

