



# Bharat Heavy Electricals Limited

## Heavy Equipment Repair Plant

Tarna Shivpur Varanasi-221003

website: <https://herp.bhel.com>

Enquiry Number : **E-RC-304-24-0402-61-1** Date : **17/Oct/2024**

### Enquiry For Material :-

Sl No	Material Description	Material Code	Quantity	Unit
1	JOURNAL OPENING FRAME LINER-14 (HY-1118.14) AS PER DRG 26130402274/00 WITH MATL AS PER SPECN. AA19741/03	BA9114135361	30.0	NOS
2	JOURNAL OPENING FRAME LINER-4 (HY-1118.04) AS PER DRG NO 26130402275/01 WITH MATL AS PER SPECN. AA19741/03	BA9114135370	30.0	NOS
3	JOURNAL OPENING FRAME LINER-3 (HY-1118.03) AS PER DRG NO. 26130402276/01 WITH MATL AS PER SPECN. AA19741/03	BA9114135388	60.0	NOS
4	JOURNAL OPENING FRMAE LINER-15 (HY-1118.15) AS PER DRG NO 26130402287/01 WITH MATL AS PER SPECN. AA19741/03	BA9114135434	30.0	NOS
5	DEFLECTOR BLADE (HY-46.A.01) - NIHARD CASTING AS PER DRG. 26136200715/01 (ITEM NO.2) WITH MATL. AS PER SPECN. AA19741/03	RV1920100091	375.0	NOS
6	OUTLET PLATE LINER (HY-153.02) - NIHARD CASTING AS PER DRG. 26147600118/04 WITH MATL AS PER SPECN. AA19741/03	RV1920100199	200.0	NOS
7	DEFLECTOR BLADE (HY-21.01) - NIHARD CASTING AS PER DRG. 26137600706/01 WITH MATL AS PER SPECN. AA19741/03	RV1920100350	1250.0	NOS
8	DEFLECTOR BLADE (HY-308.01) - NIHARD CASTING AS PER DRG. 26130000551/04 WITH MATL AS PER SEPCN. AA19741/03	RV1920100423	625.0	NOS
9	JR.HEAD LINER-I (HY-204.01) NIHARD CASTING AS PER DRG. 26108000420/03 WITH MATL AS PER SPECN. AA19741/03	RV1920100458	125.0	NOS.
10	JR.HEAD LINER-II (HY-204.02) NIHARD CASTING AS PER DRG. 36108000390/03 WITH MATL AS PER SPECN. AA19741/03	RV1920100466	13.0	NOS.
11	JR.HEAD LINER-III (HY-204.03) NIHARD CASTING AS PER DRG. 36108000391/03 WITH MATL AS PER SPECN. AA19741/03	RV1920100474	13.0	NOS.
12	JR.HEAD LINER-IV (HY-204.04) NIHARD CASTING AS PER DRG. 36108000392/04 WITH MATL AS PER SPECN. AA19741/03	RV1920100482	13.0	NOS
13	JR.HEAD LINER-V (HY-204.05) NIHARD CASTING AS PER DRG. 36108000393/04 WITH MATL AS PER SPECN. AA19741/03	RV1920100490	13.0	NOS.
14	OUTLET PLATE LINER (HY-318.02) - NIHARD CASTING AS PER DRG. 26140000555/01 WITH MATL AS PER SPECN. AA19741/03	RV1920100546	375.0	NOS.
15	JR.HEAD LINER-I (HY-220.2.1.2) - NIHARD CASTING AS PER DRG. 36106200579/03 WITH MATL AS PER SPECN. AA19741/03	RV1920100626	63.0	NOS
16	JR.HEAD LINER-II (HY-220.2.1.3) - NIHARD CASTING AS PER DRG. 36106200580/04 WITH MATL AS PER SPECN. AA19741/03	RV1920100634	25.0	NOS
17	JR.HEAD LINER-III (HY-220.2.1.4) - NIHARD CASTING AS PER DRG. 36106200581/04 WITH MATL AS PER SPECN. AA19741/03	RV1920100642	25.0	NOS
18	JR.HEAD LINER-IV (HY-220.2.1.5) - NIHARD CASTING AS PER DRG. 36106200582/05 WITH MATL AS PER SPECN. AA19741/03	RV1920100650	25.0	NOS
19	JR.HEAD LINER-V (HY-220.2.1.6) - NIHARD CASTING AS PER DRG.NO.36106200583/05 WITH MATL AS PER SPECN. AA19741/03	RV1920100669	32.0	NOS
20	SEPERATOR TOP LINER (HY-187.A.03) - NIHARD CASTING AS PER DRG. 36138000375/03 WITH MATL. AS PER SPECN. AA19741/03	RV1920100806	125.0	NOS.
21	INNER CONE SPOUT SEG. (HY-47.11) NIHARD CASTING TO DRG NO 26136200714/03.A VAR-02 WITH MATL. AS PER SPECN. AA19741/03	RV1920100989	19.0	NOS.
22	JR.HEAD LINER-III (HY-312.B.04) - NIHARD CASTING AS PER DRG. 26100000748/03 WITH MATL AS PER SPECN. AA19741/03	RV1920101551	1000.0	NOS.
23	OUTLET PLATE LINER (HY-962.02) - NIHARD CASTING AS PER DRG. 26148802055/01 WITH MATL AS PER SPECN. AA19741/03	RV1920101667	63.0	NOS

24	JR.HEAD LINER-I (HY-312.B.02) - NIHARD CASTING AS PER DRG. 26100000747/04 WITH MATL AS PER SPECN. AA19741/03	RV1920101837	565.0	NOS
25	JR.HEAD LINER-II (HY-312.B.03) - NIHARD CASTING AS PER DRG. 26100000749/04 WITH MATL AS PER SPECN. AA19741/03	RV1920101845	625.0	NOS
26	JR. HEAD LINER (HY-901.08.01) - NIHARD CASTING AS PER DRG. 26108802057/02 WITH MATL AS PER SPECN. AA19741/03	RV1920101853	25.0	NOS
27	J.O.F. LINER-IX (HY-969.09) AS PER DRG. 36138802015/01 WITH MATL AS PER SPECN. AA19741/03	RV1920102019	13.0	NOS
28	MPO LINER AS PER DRG. 26140002467/01 WITH MATL. AS PER SPECN. AA19741/03	RV1920102027	25.0	NOS
29	DEFLECTOR BLADE (HY-1119.05) - NIHARD CASTING AS PER DRG 36130402337/00 WITH MATL AS PER SEPCN. AA19741/03	RV1920102078	250.0	NOS
30	INNER CONE SPOUT SEGMENT AS PER DRG. 26130402281 REV-00 WITH MATL. AS PER SPECN. AA19741/03	RV1920102139	63.0	NOS
31	SET OF JOURNAL HEAD LINERS (ITEMS FROM 02 TO 06) AS PER DRG 1610401189/01 WITH MATL AS PER DRG.	RV1920102183	98.0	SET
32	INNER CONE SPOUT SEG.(HY-322.03) - NIHARD CASTING AS PER DRG. 26130001184/02 WITH MATL AS PER SPECN. AA19741/03	RV1920200304	63.0	NOS.
33	OUTLET PLATE LINER (HY-217.62.02) NIHARD CASTING AS PER DRG. 26146200593/02 WITH MATL AS PER SPECN. AA19741/03	RV1920200347	38.0	NOS.
34	JR. HEAD LINER (HY-311.B.01) - NIHARD CASTING AS PER DRG.26100000409/02 WITH MATL. AS PER SPECN. AA19741/03	RV1920200410	13.0	NOS.
35	JR.HEAD LINER SET (HY-204.00) - NIHARD CASTING AS PER DRG. HY-204.00 WITH MATL AS PER SPECN. AA19741/03	RV1920200461	25.0	SET
36	SET OF JOURNAL HEAD LINERS (3 TYPES) - (04 NOS/SET) NIHARD CASTING AS PER DRG. HY-901.09.01.A WITH MATL AS PER SPECN. AA19741/03	RV1920200673	32.0	SET
37	J.O.F. LINER-I (HY-969.01) AS PER DRG. 26138802031/01 WITH MATL AS PER SPECN. AA19741/03	RV1920200827	25.0	NOS
38	J.O.F. LINER-III (HY-969.03) AS PER DRG. 36138802019/01 WITH MATL AS PER SPECN. AA19741/03	RV1920200843	32.0	NOS
39	J.O.F. LINER-IV (HY-969.04) AS PER DRG. 26138802033/01 WITH MATL AS PER SPECN. AA19741/03	RV1920200851	25.0	NOS
40	J.O.F. LINER-V (HY-969.05) AS PER DRG. 26138802034/01 WITH MATL AS PER SPECN. AA19741/03	RV1920200860*	25.0	NOS
41	J.O.F. LINER-IX (HY-969.09) AS PER DRG. 36138802015/01 WITH MATL AS PER SPECN. AA19741/03	RV1920200908	13.0	NOS
42	DEFLECTOR BLADE (HY-707.08.33) - NIHARD CASTING AS PER DRG. 26137000880/03 WITH MATL AS PER SPECN. AA19741/03	RV1920200983	25.0	NOS
43	J.O.F LINER-V (HY-1118.05) AS PER DRG NO 26130402272 AND SPEC AA19741/03	RV1920201017	25.0	NOS
44	J.O.F LINER-VI (HY-1118.06) AS PER DRG NO 16130401176 AND SPEC AA19741/03	RV1920201025	25.0	NOS
45	J.O.F LINER-VII (HY-1118.07) AS PER DRG NO 16130401175 AND SPEC AA19741/03	RV1920201033	25.0	NOS
46	J.O.F LINER-VIII (HY-1118.08) AS PER DRG NO 26130402279 Rev. 01 AND SPEC AA19741/03	RV1920201041	25.0	NOS
47	J.O.F LINER-X (HY-1118.10) AS PER DRG NO 26130402344 AND SPEC AA19741/03	RV1920201059	25.0	NOS
48	J.O.F LINER-XI (HY-1118.11) AS PER DRG NO 16130401182 AND SPEC AA19741/03	RV1920201067	25.0	NOS
49	J.O.F LINER-XII (HY-1118.12) AS PER DRG NO 16130401178 AND SPEC AA19741/03	RV1920201075	25.0	NOS
50	J.O.F LINER-XIII (HY-1118.13) AS PER DRG NO 16130401177 AND SPEC AA19741/03	RV1920201083	25.0	NOS

## Remarks

(A) SCOPE OF SUPPLY:-

1. THIS ENQUIRY HAS BEEN RAISED FOR ENTERING INTO FRAMEWORK AGREEMENT (VALUE WISE) WITH VENDORS FOR NIHARD CASTINGS. SEPARATE PO WILL BE GIVEN TIME TO TIME AS PER REQUIREMENT UNDER THIS RC. ITEM QUANTITY MENTIONED IN THE ENQUIRY IS TENTATIVE & IT MAY INCREASE OR DECREASE AS PER OUR FINAL REQUIREMENT.

2.THE % WEIGHTAGE FOR CALCULATING TOTAL COST OF INDIVIDUAL ITEM HAS BEEN ARRIVED CONSIDERING INDIVIDUAL ITEM'S CONTENT IN TOTAL ESTIMATED COST OF ALL THE ENQUIRY ITEMS. THE % WEIGHTAGE WILL BE AS PER ANNEXURE-IV.

3. VALUE WISE MEANS FA WILL DONE ON SINGLE SET BASIS FOR ALL THE 50 ITEMS WITH THEIR FULL QUANTITY AND NOT QUANTITY OF INDIVIDUAL ITEM.

4. RATE FOR INDIVIDUAL ITEM WILL BE ARRIVED AS PER PERCENTAGE WEIGHTAGE MENTIONED IN ANNEXURE- ATTACHED.

5. RATES OF ITEMS AGAINST FA WILL BE FIRM & VALID FOR ORDERING FOR A PERIOD OF ONE YEAR FROM THE DATE OF AGREEMENT. PRICE VARIATION CLAUSE (PVC) IS NOT ACCEPTABLE.

6. VENDOR HAS TO QUOTE FOR ALL THE 50 ITEMS OF TENDER ENQUIRY COMPULSORILY. IN CASE, ANY VENDOR QUOTES FOR PART ITEM, THEIR OFFER WILL NOT BE CONSIDERED FOR FURTHER EVALUATION.

7. L-1 VENDOR WILL BE DECIDED ON TOTAL COST ON SET BASIS.

8. RC QTY AGAINST EACH ITEM IS INDICATIVE ONLY. PO WILL BE PLACED BASED ON ACTUAL REQUIREMENT IRRESPECTIVE OF RC QUANTITY NOT EXCEEDING THE TOTAL RATE CONTRACT VALUE.

9. AFTER FINALIZATION OF RATE CONTRACT, PO QUANTITY WILL BE PLACED AS PER REQUIREMENT.

(B) SUPPLY CONDITION :

1. ITEM TO BE SUPPLIED AT BHEL HERP STORES.

2. PRE-DESPATCH INSPECTION WILL BE CARRIED OUT AS PER QUALITY PLAN RV/C&F/03 REV-02 AT PARTY'S WORKS BY BHEL REPRESENTATIVE.

(C) TECHNICAL DELIVERY CONDITION:

1. MATERIAL IS TO BE SUPPLIED AS PER SPECIFICATION AA19741/03.

2. DIMENSIONS AND TOLERANCES TO BE MAINTAINED AS PER DRG.

3. CASTING SHOULD BE FREE FROM ALL DEFECTS.

4. CASTING SHOULD BE PROPERLY FETTLED TO PRODUCE EVEN SURFACE.

5. HEAT TREATMENT CHART IS REQUIRED.

6. ALL TECHNICAL REQUIREMENTS OF THE DRAWING MUST BE FULLFILLED.

7. DIMENSION REPORT IS REQUIRED.

(D) TEST CERTIFICATE: REQUIRED FOR CHEMICAL & MECHANICAL PROPERTIES AND HARDNESS OF RAW MATL.

(E) GUARANTEE CERTIFICATE: REQUIRED FOR 24 MONTHS AGAINST ANY MANUFACTURING DEFECTS FROM THE DATE OF RECIPT AT BHEL HERP.

(F) PACKING INSTRUCTIONS : ITEM TO BE SUPPLIED IN PROPERLY PACKED CONDITIONS WOODEN BOX OF 1" THICK PLANK WITH 1.5"X4" BKTS. ONE LINER SHOULD BE PLACED OVER ANOTHER BY PLACING PAPER CUTOUT /HARD PAPER BOARD/STRAW APPROX. 10 MM THICK IN BETWEEN THEM DURING PACKING IN THE WOODEN BOX. ALL THE GAPS AT EVERY NOOKS OF THE WOODEN BOX MUST BE TIGHTLY PACKED BY USING THE AFORESAID MATERIALS IN SUCH A WAY THAT THERE SHALL NOT BE ANY PROBABILITY OF RELATIVE MOTION BETWEEN THE PACKED LINERS DURING TRANSIT.

(G) RATE CONTRACT VALIDITY: FOR 1 (ONE) YEAR FROM THE RC-PO DATE.

(H) SPECIAL REMARKS:

1. THE SPLITTING WILL BE DONE WITH RESPECT TO TOTAL VALUE OF ITEM.

2. BHEL WILL SPLIT THE TOTAL QUANTITY (VALUE WISE) FOR ENTERING INTO FRAMEWORK AGREEMENT BETWEEN THREE VENDORS IN RATIO OF 50:35:15. IF NONE OF THE OTHER BIDDERS ACCEPT THE L1 PRICE, THEN THE ENTIRE QUANTITY OF THE TENDER WOULD BE ORDERED TO THE ORIGINAL L1 PARTY ONLY.

3. IN NO CASE THE HIGHEST QUOTED BIDDER (H1) WILL BE GIVEN THE OPPORTUNITY OF THE QUANTITY SPLIT.

4. THE EQUATED L1 PRICE ON TOTAL COST BASIS TO BHEL WOULD BE COUNTER OFFERED TO THE NEXT HIGHER BIDDER IN ORDER OF THEIR RANKING AND THE VALUE SPLIT WOULD BE GIVEN TO THE BIDDER WHO ACCEPT THE EQUATED L1 PRICE ON THE BASIS OF THEIR RANKING IN THE PRICE BID.

5. AT ANY POINT OF TIME OR IF THE PERFORMANCE OF ANY VENDOR IS FOUND UNSATISFACTORY, THE ABOVE DISTRIBUTION RATIO MAY BE CANCELLED OR CHANGED BY BHEL AND ITEMS MAY BE PROCURED FROM PERFORMING VENDORS.

6. ITEM WISE MAXIMUM QTY IN EACH LOT (WHICH MAY BE REQUIRED IN A PARTICULAR ORDER) WILL BE AS MENTIONED IN ANNEXURE--RC-LOT-BA19/01. THERE WILL BE A GAP OF 01 MONTH BETWEEN TWO CONSECUTIVE LOTS.

7 .DELIVERY IS WITHIN 120 DAYS FROM DATE OF PO FOR FIRST LOT.

(I) REVERSE AUCTION:-

1. BHEL SHALL BE RESORTING TO REVERSE AUCTION (RA) (GUIDELINES AS AVAILABLE ON WWW.BHEL.COM FOR THIS TENDER. RA SHALL BE CONDUCTED AMONG ALL THE TECHNO COMMERCIALY QUALIFIED BIDDERS.

2. PRICE BIDS OF ALL TECHNO COMMERCIALY QUALIFIED BIDDERS SHALL BE OPENED AND SAME SHALL BE CONSIDERED AS INITIAL BIDS OF BIDDERS IN RA. IN CASE ANY BIDDER(S) DO(ES) NOT PARTICIPATE IN ONLINE REVERSE AUCTION, THEIR PRICE BID ALONG WITH APPLICABLE LOADING, IF ANY, SHALL BE CONSIDERED FOR RANKING.

(J) BEING AN OPEN TENDER VENDORS HAVE TO SUBMIT THE DULY FILLED AND SIGNED & STAMP COPY OF PQR ALONG WITH ALL RELATED DOCUMENTS.

(K) PERFORMANCE SECURITY :-

IF ANY INDIVIDUAL PO RELASED TO A SINGLE VENDOR FOR WHICH PO VALUE IS MORE THAN 02 CRORES THEN VENDOR HAS TO SUBMIT PBG 05% OF THE PO VALUE. (REFER CLAUSE 58 OF GTC FOR MODE OF SUBMISSION AND OTHER DETAIL).

(L) CLAUSE FOR INTEGRITY PACT (IP) SHALL BE AS PER ANNEXURE-1 & 2 ATTACHED. BIDDER SHALL SUBMIT THE ATTACHED ANNEXURE-1 FILLED, SIGNED AND STAMPED.

(M) ALL OTHER TERMS AND CONDITIONS SHALL BE AS PER ATTACHED GTC.



**ESTIMATION SHEET SUMMARY**

**ANNEXURE-IV**

S.NO	MAT.CODE	ITEM DESCRIPTION	QTY(NOS)	% WEIGHTAGE
1	RV1920102078	DEFLECTOR BLADE (HY-1119.05) - NIHARD CASTING AS PER DRG 36130402337/00 WITH MATL AS PER SEPCN. AA19741/03	250	2.80%
2	RV1920100350	DEFLECTOR BLADE (HY-21.01) - NIHARD CASTING AS PER DRG. 26137600706/01 WITH MATL AS PER SPECN. AA19741/03	1250	6.67%
3	RV1920100423	DEFLECTOR BLADE (HY-308.01) - NIHARD CASTING AS PER DRG. 26130000551/04 WITH MATL AS PER SEPCN. AA19741/03	625	5.38%
4	RV1920100091	DEFLECTOR BLADE (HY-46.A.01) - NIHARD CASTING AS PER DRG. 26136200715/01 (ITEM NO.2) WITH MATL. AS PER SPECN. AA19741/03	375	1.23%
5	RV1920200983	DEFLECTOR BLADE (HY-707.08.33) - NIHARD CASTING AS PER DRG. 26137000880/03 WITH MATL AS PER SPECN. AA19741/03	25	0.11%
6	RV1920100989	INNER CONE SPOUT SEG. (HY-47.11) NIHARD CASTING TO DRG NO 26136200714/03.A VAR-02 WITH MATL. AS PER SPECN. AA19741/03	19	0.35%
7	RV1920200304	INNER CONE SPOUT SEG.(HY-322.03) - NIHARD CASTING AS PER DRG. 26130001184/02 WITH MATL AS PER SPECN. AA19741/03	63	1.72%
8	RV1920102139	INNER CONE SPOUT SEGMENT AS PER DRG. 26130402281 REV-00 WITH MATL. AS PER SPECN. AA19741/03	63	2.32%
9	RV1920200843	J.O.F. LINER-III (HY-969.03) AS PER DRG. 36138802019/01 WITH MATL AS PER SPECN. AA19741/03	32	0.59%
10	RV1920200908	J.O.F. LINER-IX (HY-969.09) AS PER DRG. 36138802015/01 WITH MATL AS PER SPECN. AA19741/03	13	0.14%
11	RV1920102019	JOURNAL HEAD LINER AS PER DRG. 26100402265/00 WITH MATL. AS PER SPECN. AA19741/03	13	0.53%
12	RV1920200410	JR. HEAD LINER (HY-311.B.01) - NIHARD CASTING AS PER DRG.26100000409/02 WITH MATL. AS PER SPECN. AA19741/03	13	0.37%
13	RV1920101853	JR. HEAD LINER (HY-901.08.01) - NIHARD CASTING AS PER DRG. 26108802057/02 WITH MATL AS PER SPECN. AA19741/03	25	0.47%
14	RV1920200461	JR.HEAD LINER SET (HY-204.00) - NIHARD CASTING AS PER DRG. HY-204.00 WITH MATL AS PER SPECN. AA19741/03	25	1.00%
15	RV1920100458	JR.HEAD LINER-I (HY-204.01) NIHARD CASTING AS PER DRG. 26108000420/03 WITH MATL AS PER SPECN. AA19741/03	125	0.56%
16	RV1920101837	JR.HEAD LINER-I (HY-312.B.02) - NIHARD CASTING AS PER DRG. 26100000747/04 WITH MATL AS PER SPECN. AA19741/03	565	9.68%
17	RV1920100466	JR.HEAD LINER-II (HY-204.02) NIHARD CASTING AS PER DRG. 36108000390/03 WITH MATL AS PER SPECN. AA19741/03	13	0.06%

18	RV1920101845	JR.HEAD LINER-II (HY-312.B.03) - NIHARD CASTING AS PER DRG. 26100000749/04 WITH MATL AS PER SPECN. AA19741/03	625	10.76%
19	RV1920100474	JR.HEAD LINER-III (HY-204.03) NIHARD CASTING AS PER DRG. 36108000391/03 WITH MATL AS PER SPECN. AA19741/03	13	0.06%
20	RV1920101551	JR.HEAD LINER-III (HY-312.B.04) - NIHARD CASTING AS PER DRG. 26100000748/03 WITH MATL AS PER SPECN. AA19741/03	1000	16.02%
21	RV1920100482	JR.HEAD LINER-IV (HY-204.04) NIHARD CASTING AS PER DRG. 36108000392/04 WITH MATL AS PER SPECN. AA19741/03	13	0.08%
22	RV1920100490	JR.HEAD LINER-V (HY-204.05) NIHARD CASTING AS PER DRG. 36108000393/04 WITH MATL AS PER SPECN. AA19741/03	13	0.08%
23	RV1920200347	OUTLET PLATE LINER (HY-217.62.02) NIHARD CASTING AS PER DRG. 26146200593/02 WITH MATL AS PER SPECN. AA19741/03	38	0.30%
24	RV1920100199	OUTLET PLATE LINER (HY-153.02) - NIHARD CASTING AS PER DRG. 26147600118/04 WITH MATL AS PER SPECN. AA19741/03	200	2.58%
25	RV1920100546	OUTLET PLATE LINER (HY-318.02) - NIHARD CASTING AS PER DRG. 26140000555/01 WITH MATL AS PER SPECN. AA19741/03	375	9.92%
26	RV1920101667	OUTLET PLATE LINER (HY-962.02) - NIHARD CASTING AS PER DRG. 26148802055/01 WITH MATL AS PER SPECN. AA19741/03	63	1.34%
27	RV1920100806	SEPERATOR TOP LINER (HY-187.A.03) - NIHARD CASTING AS PER DRG. 36138000375/03 WITH MATL. AS PER SPECN. AA19741/03	125	2.70%
28	RV1920200673	SET OF JOURNAL HEAD LINERS (3 TYPES) - (04 NOS/SET) NIHARD CASTING AS PER DRG. HY-901.09.01.A WITH MATL AS PER SPECN. AA19741/03	32	1.40%
29	RV1920102183	SET OF JOURNAL HEAD LINERS (ITEMS FROM 02 TO 06) AS PER DRG 1610401189/01 WITH MATL AS PER DRG.	98	11.87%
30	BA9114135361	JOURNAL OPENING FRAME LINER-14 (HY-1118.14) AS PER DRG 26130402274/00 WITH MATL AS PER SPECN. AA19741/03	30	0.53%
31	BA9114135370	JOURNAL OPENING FRAME LINER-4 (HY-1118.04) AS PER DRG NO 26130402275/01 WITH MATL AS PER SPECN. AA19741/03	30	0.53%
32	BA9114135388	JOURNAL OPENING FRAME LINER-3 (HY-1118.03) AS PER DRG NO. 26130402276/01 WITH MATL AS PER SPECN. AA19741/03	60	1.08%
33	BA9114135434	JOURNAL OPENING FRMAE LINER-15 (HY-1118.15) AS PER DRG NO 26130402287/01 WITH MATL AS PER SPECN. AA19741/03	30	0.54%
34	RV1920100626	JR.HEAD LINER-I (HY-220.2.1.2) - NIHARD CASTING AS PER DRG. 36106200579/03 WITH MATL AS PER SPECN. AA19741/03	63	0.27%
35	RV1920100669	JR.HEAD LINER-V (HY-220.2.1.6) - NIHARD CASTING AS PER DRG.NO.36106200583/05 WITH MATL AS PER SPECN. AA19741/03	32	0.13%




36	RV1920100634	JR.HEAD LINER-II (HY-220.2.1.3) - NIHARD CASTING AS PER DRG. 36106200580/04 WITH MATL AS PER SPECN. AA19741/03	25	0.11%
37	RV1920100642	JR.HEAD LINER-III (HY-220.2.1.4) - NIHARD CASTING AS PER DRG. 36106200581/04 WITH MATL AS PER SPECN. AA19741/03	25	0.11%
38	RV1920100650	JR.HEAD LINER-IV (HY-220.2.1.5) - NIHARD CASTING AS PER DRG. 36106200582/05 WITH MATL AS PER SPECN. AA19741/03	25	0.11%
39	RV1920200860*	J.O.F. LINER-V (HY-969.05) AS PER DRG. 26138802034/01 WITH MATL AS PER SPECN. AA19741/03	25	0.22%
40	RV1920200851	J.O.F. LINER-IV (HY-969.04) AS PER DRG. 26138802033/01 WITH MATL AS PER SPECN. AA19741/03	25	0.24%
41	RV1920200827	J.O.F. LINER-I (HY-969.01) AS PER DRG. 26138802031/01 WITH MATL AS PER SPECN. AA19741/03	25	0.39%
42	RV1920102027	MPO LINER AS PER DRG. 26140002467/01 WITH MATL. AS PER SPECN. AA19741/03	25	0.75%
43	RV1920201025	J.O.F LINER-VI (HY-1118.06) AS PER DRG NO 16130401176 AND SPEC AA19741	25	0.47%
44	RV1920201033	J.O.F LINER-VII (HY-1118.07) AS PER DRG NO 16130401175 AND SPEC AA19741	25	0.47%
45	RV1920201041	J.O.F LINER-VIII (HY-1118.08) AS PER DRG NO 26130402279/01 AND SPEC AA19741	25	0.34%
46	RV1920201017	J.O.F LINER-V (HY-1118.05) AS PER DRG NO 26130402272 AND SPEC AA19741	25	0.49%
47	RV1920201059	J.O.F LINER-X (HY-1118.10) AS PER DRG NO 26130402344 AND SPEC AA19741	25	0.49%
48	RV1920201067	J.O.F LINER-XI (HY-1118.11) AS PER DRG NO 16130401182 AND SPEC AA19741	25	0.43%
49	RV1920201075	J.O.F LINER-XII (HY-1118.12) AS PER DRG NO 16130401178 AND SPEC AA19741	25	0.60%
50	RV1920201083	J.O.F LINER-XIII (HY-1118.13) AS PER DRG NO 16130401177 AND SPEC AA19741	25	0.60%
<b>TOTAL</b>			<b>6709</b>	

**ANNEXURE--RC-LOT-BA19/01**

S.NO	MAT.CODE	ITEM DESCRIPTION	RC QTY	MAX LOT
1	RV1920102078	DEFLECTOR BLADE (HY-1119.05) - NIHARD CASTING AS PER DRG 36130402337/00 WITH MATL AS PER SEPCN. AA19741/03	250	50
2	RV1920100350	DEFLECTOR BLADE (HY-21.01) - NIHARD CASTING AS PER DRG. 26137600706/01 WITH MATL AS PER SPECN. AA19741/03	1250	500
3	RV1920100423	DEFLECTOR BLADE (HY-308.01) - NIHARD CASTING AS PER DRG. 26130000551/04 WITH MATL AS PER SEPCN. AA19741/03	625	200
4	RV1920100091	DEFLECTOR BLADE (HY-46.A.01) - NIHARD CASTING AS PER DRG. 26136200715/01 (ITEM NO.2) WITH MATL. AS PER SPECN. AA19741/03	375	150
5	RV1920200983	DEFLECTOR BLADE (HY-707.08.33) - NIHARD CASTING AS PER DRG. 26137000880/03 WITH MATL AS PER SPECN. AA19741/03	25	20
6	RV1920100989	INNER CONE SPOUT SEG. (HY-47.11) NIHARD CASTING TO DRG NO 26136200714/03.A VAR-02 WITH MATL. AS PER SPECN. AA19741/03	19	15
7	RV1920200304	INNER CONE SPOUT SEG.(HY-322.03) - NIHARD CASTING AS PER DRG. 26130001184/02 WITH MATL AS PER SPECN. AA19741/03	63	50
8	RV1920102139	INNER CONE SPOUT SEGMENT AS PER DRG. 26130402281 REV-00 WITH MATL. AS PER SPECN. AA19741/03	63	25
9	RV1920200843	J.O.F. LINER-III (HY-969.03) AS PER DRG. 36138802019/01 WITH MATL AS PER SPECN. AA19741/03	32	25
10	RV1920200908	J.O.F. LINER-IX (HY-969.09) AS PER DRG. 36138802015/01 WITH MATL AS PER SPECN. AA19741/03	13	10
11	RV1920102019	JOURNAL HEAD LINER AS PER DRG. 26100402265/00 WITH MATL. AS PER SPECN. AA19741/03	13	10
12	RV1920200410	JR. HEAD LINER (HY-311.B.01) - NIHARD CASTING AS PER DRG.26100000409/02 WITH MATL. AS PER SPECN. AA19741/03	13	10
13	RV1920101853	JR. HEAD LINER (HY-901.08.01) - NIHARD CASTING AS PER DRG. 26108802057/02 WITH MATL AS PER SPECN. AA19741/03	25	20
14	RV1920200461	JR.HEAD LINER SET (HY-204.00) - NIHARD CASTING AS PER DRG. HY-204.00 WITH MATL AS PER SPECN. AA19741/03	25	20
15	RV1920100458	JR.HEAD LINER-I (HY-204.01) NIHARD CASTING AS PER DRG. 26108000420/03 WITH MATL AS PER SPECN. AA19741/03	125	50
16	RV1920101837	JR.HEAD LINER-I (HY-312.B.02) - NIHARD CASTING AS PER DRG. 26100000747/04 WITH MATL AS PER SPECN. AA19741/03	565	100
17	RV1920100466	JR.HEAD LINER-II (HY-204.02) NIHARD CASTING AS PER DRG. 36108000390/03 WITH MATL AS PER SPECN. AA19741/03	13	10

18	RV1920101845	JR.HEAD LINER-II (HY-312.B.03) - NIHARD CASTING AS PER DRG. 26100000749/04 WITH MATL AS PER SPECN. AA19741/03	625	100
19	RV1920100474	JR.HEAD LINER-III (HY-204.03) NIHARD CASTING AS PER DRG. 36108000391/03 WITH MATL AS PER SPECN. AA19741/03	13	10
20	RV1920101551	JR.HEAD LINER-III (HY-312.B.04) - NIHARD CASTING AS PER DRG. 26100000748/03 WITH MATL AS PER SPECN. AA19741/03	1000	200
21	RV1920100482	JR.HEAD LINER-IV (HY-204.04) NIHARD CASTING AS PER DRG. 36108000392/04 WITH MATL AS PER SPECN. AA19741/03	13	10
22	RV1920100490	JR.HEAD LINER-V (HY-204.05) NIHARD CASTING AS PER DRG. 36108000393/04 WITH MATL AS PER SPECN. AA19741/03	13	10
23	RV1920200347	OUTLET PLATE LINER (HY-217.62.02) NIHARD CASTING AS PER DRG. 26146200593/02 WITH MATL AS PER SPECN. AA19741/03	38	30
24	RV1920100199	OUTLET PLATE LINER (HY-153.02) - NIHARD CASTING AS PER DRG. 26147600118/04 WITH MATL AS PER SPECN. AA19741/03	200	50
25	RV1920100546	OUTLET PLATE LINER (HY-318.02) - NIHARD CASTING AS PER DRG. 26140000555/01 WITH MATL AS PER SPECN. AA19741/03	375	50
26	RV1920101667	OUTLET PLATE LINER (HY-962.02) - NIHARD CASTING AS PER DRG. 26148802055/01 WITH MATL AS PER SPECN. AA19741/03	63	25
27	RV1920100806	SEPERATOR TOP LINER (HY-187.A.03) - NIHARD CASTING AS PER DRG. 36138000375/03 WITH MATL. AS PER SPECN. AA19741/03	125	50
28	RV1920200673	SET OF JOURNAL HEAD LINERS (3 TYPES) - (04 NOS/SET) NIHARD CASTING AS PER DRG. HY-901.09.01.A WITH MATL AS PER SPECN. AA19741/03	32	25
29	RV1920102183	SET OF JOURNAL HEAD LINERS (ITEMS FROM 02 TO 06) AS PER DRG 1610401189/01 WITH MATL AS PER DRG.	98	25
30	BA9114135361	JOURNAL OPENING FRAME LINER-14 (HY-1118.14) AS PER DRG 26130402274/00 WITH MATL AS PER SPECN. AA19741/03	30	24
31	BA9114135370	JOURNAL OPENING FRAME LINER-4 (HY-1118.04) AS PER DRG NO 26130402275/01 WITH MATL AS PER SPECN. AA19741/03	30	24
32	BA9114135388	JOURNAL OPENING FRAME LINER-3 (HY-1118.03) AS PER DRG NO. 26130402276/01 WITH MATL AS PER SPECN. AA19741/03	60	25
33	BA9114135434	JOURNAL OPENING FRMAE LINER-15 (HY-1118.15) AS PER DRG NO 26130402287/01 WITH MATL AS PER SPECN. AA19741/03	30	24
34	RV1920100626	JR.HEAD LINER-I (HY-220.2.1.2) - NIHARD CASTING AS PER DRG. 36106200579/03 WITH MATL AS PER SPECN. AA19741/03	63	50
35	RV1920100669	JR.HEAD LINER-V (HY-220.2.1.6) - NIHARD CASTING AS PER DRG.NO.36106200583/05 WITH MATL AS PER SPECN. AA19741/03	32	25

36	RV1920100634	JR.HEAD LINER-II (HY-220.2.1.3) - NIHARD CASTING AS PER DRG. 36106200580/04 WITH MATL AS PER SPECN. AA19741/03	25	20
37	RV1920100642	JR.HEAD LINER-III (HY-220.2.1.4) - NIHARD CASTING AS PER DRG. 36106200581/04 WITH MATL AS PER SPECN. AA19741/03	25	20
38	RV1920100650	JR.HEAD LINER-IV (HY-220.2.1.5) - NIHARD CASTING AS PER DRG. 36106200582/05 WITH MATL AS PER SPECN. AA19741/03	25	20
39	RV1920200860*	J.O.F. LINER-V (HY-969.05) AS PER DRG. 26138802034/01 WITH MATL AS PER SPECN. AA19741/03	25	20
40	RV1920200851	J.O.F. LINER-IV (HY-969.04) AS PER DRG. 26138802033/01 WITH MATL AS PER SPECN. AA19741/03	25	20
41	RV1920200827	J.O.F. LINER-I (HY-969.01) AS PER DRG. 26138802031/01 WITH MATL AS PER SPECN. AA19741/03	25	20
42	RV1920102027	MPO LINER AS PER DRG. 26140002467/01 WITH MATL. AS PER SPECN. AA19741/03	25	20
43	RV1920201025	J.O.F LINER-VI (HY-1118.06) AS PER DRG NO 16130401176 AND SPEC AA19741	25	20
44	RV1920201033	J.O.F LINER-VII (HY-1118.07) AS PER DRG NO 16130401175 AND SPEC AA19741	25	20
45	RV1920201041	J.O.F LINER-VIII (HY-1118.08) AS PER DRG NO 26130402279/01 AND SPEC AA19741	25	20
46	RV1920201017	J.O.F LINER-V (HY-1118.05) AS PER DRG NO 26130402272 AND SPEC AA19741	25	20
47	RV1920201059	J.O.F LINER-X (HY-1118.10) AS PER DRG NO 26130402344 AND SPEC AA19741	25	20
48	RV1920201067	J.O.F LINER-XI (HY-1118.11) AS PER DRG NO 16130401182 AND SPEC AA19741	25	20
49	RV1920201075	J.O.F LINER-XII (HY-1118.12) AS PER DRG NO 16130401178 AND SPEC AA19741	25	20
50	RV1920201083	J.O.F LINER-XIII (HY-1118.13) AS PER DRG NO 16130401177 AND SPEC AA19741	25	20
<b>Total</b>			<b>6709</b>	

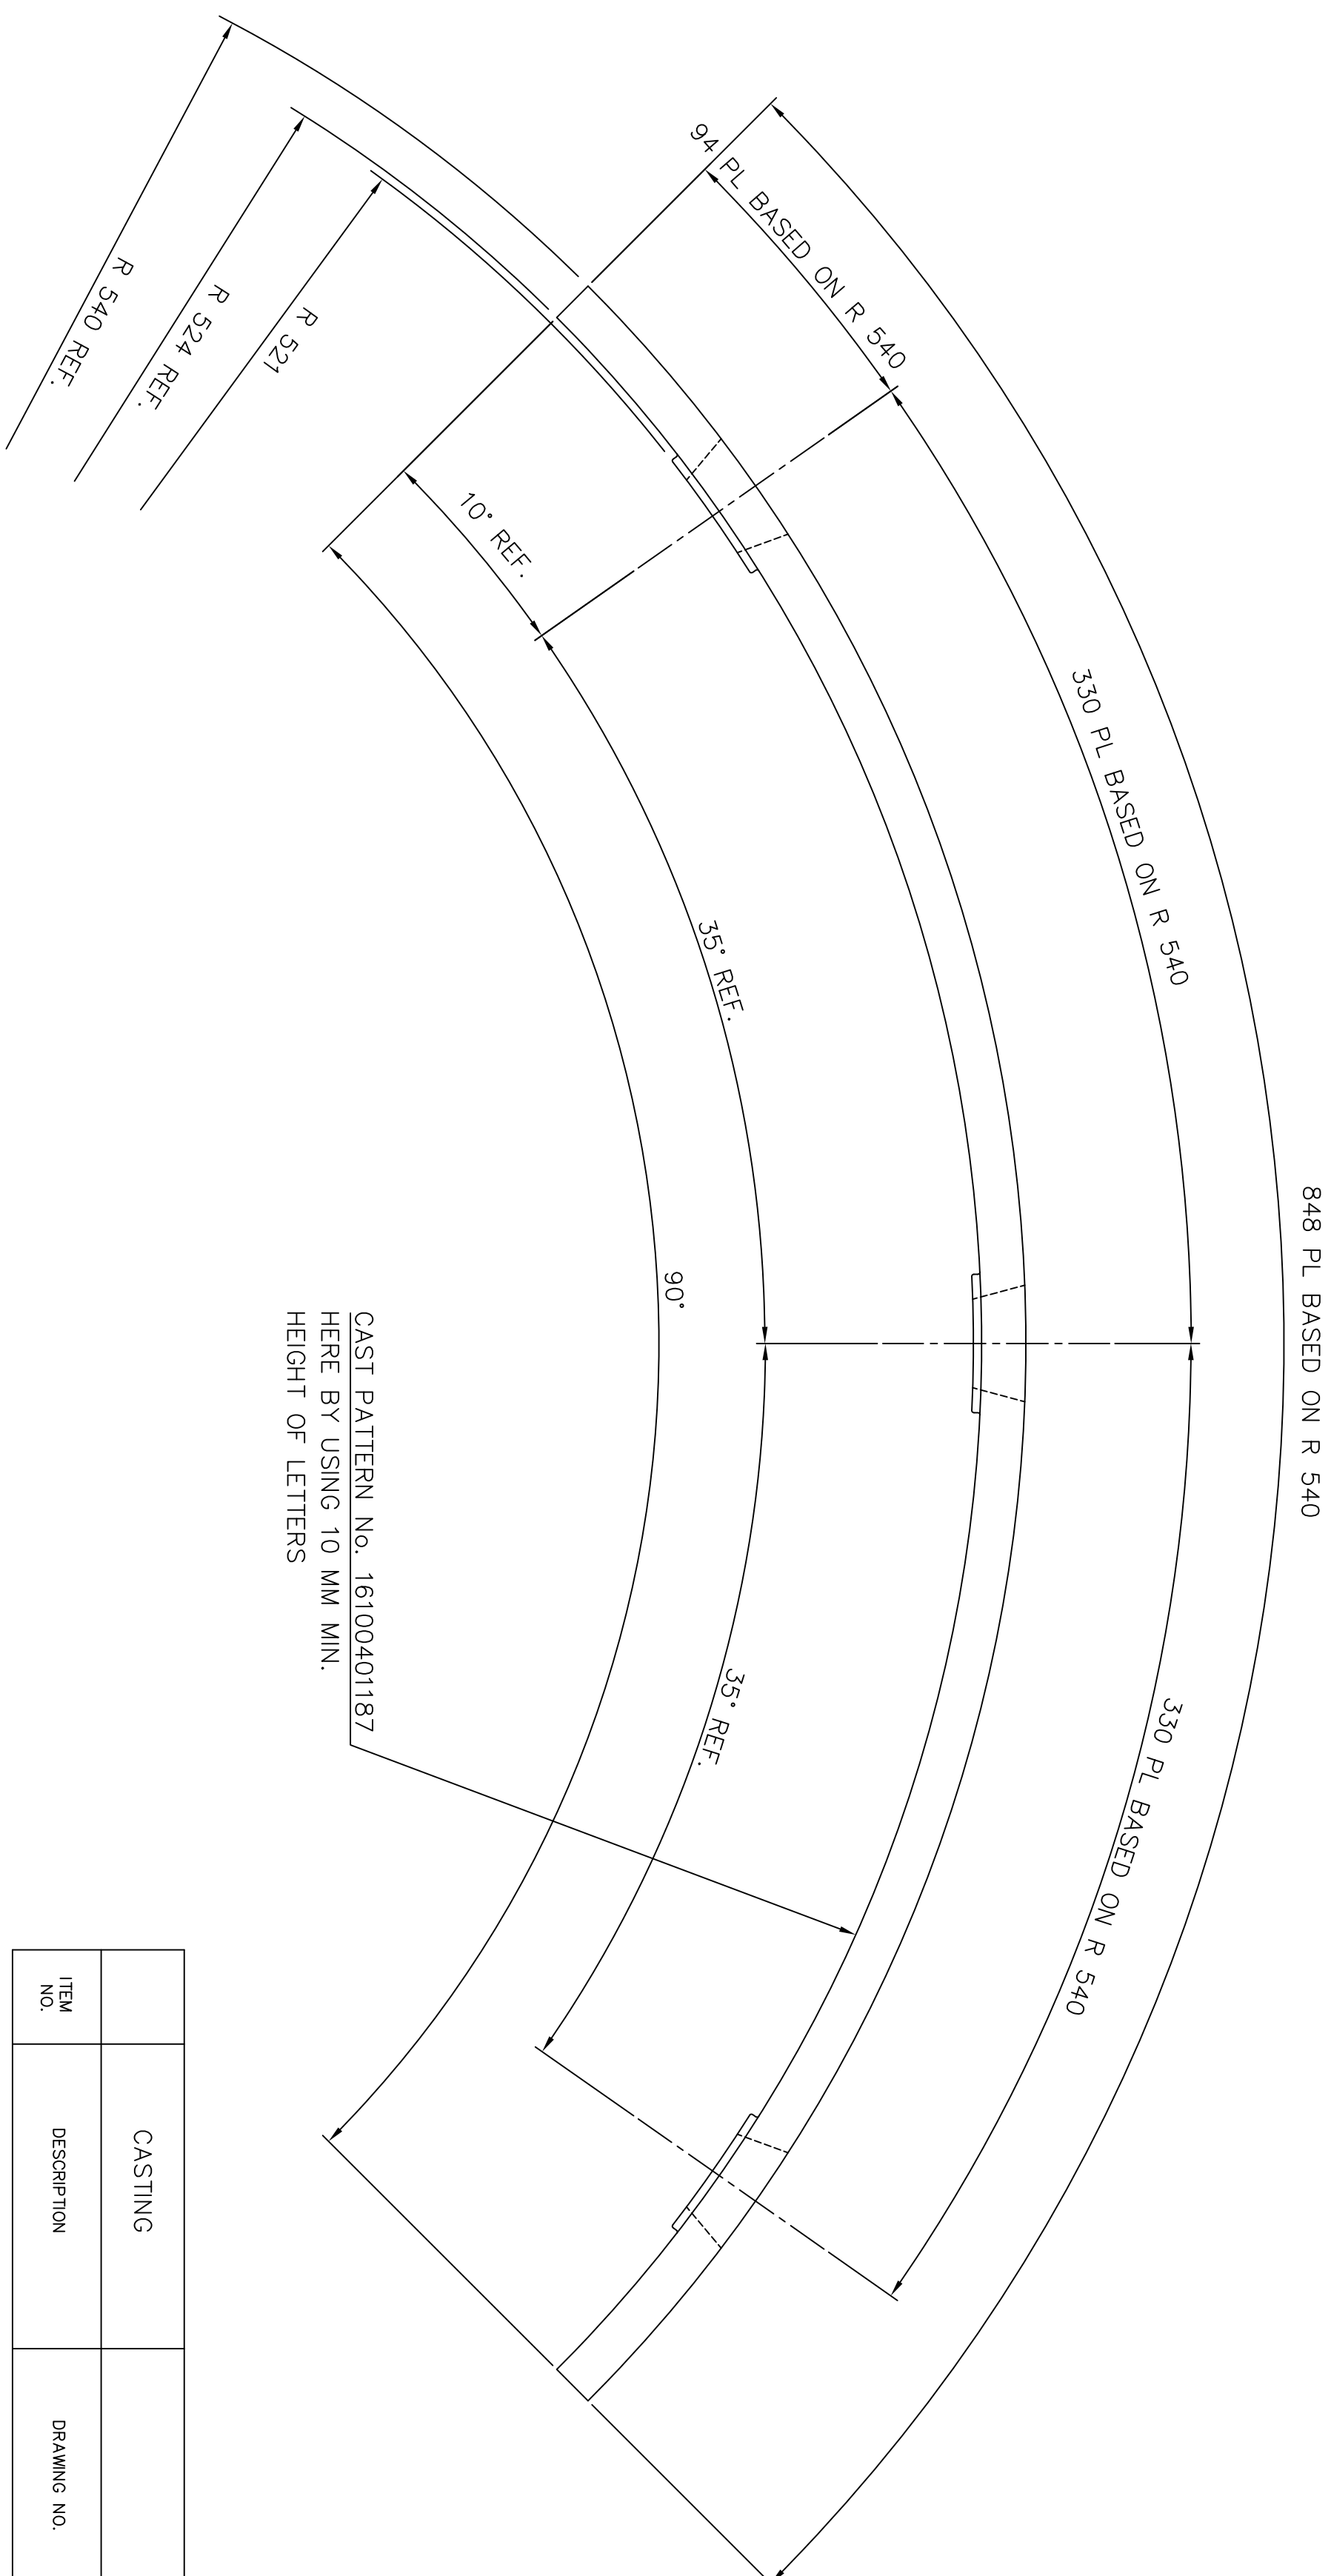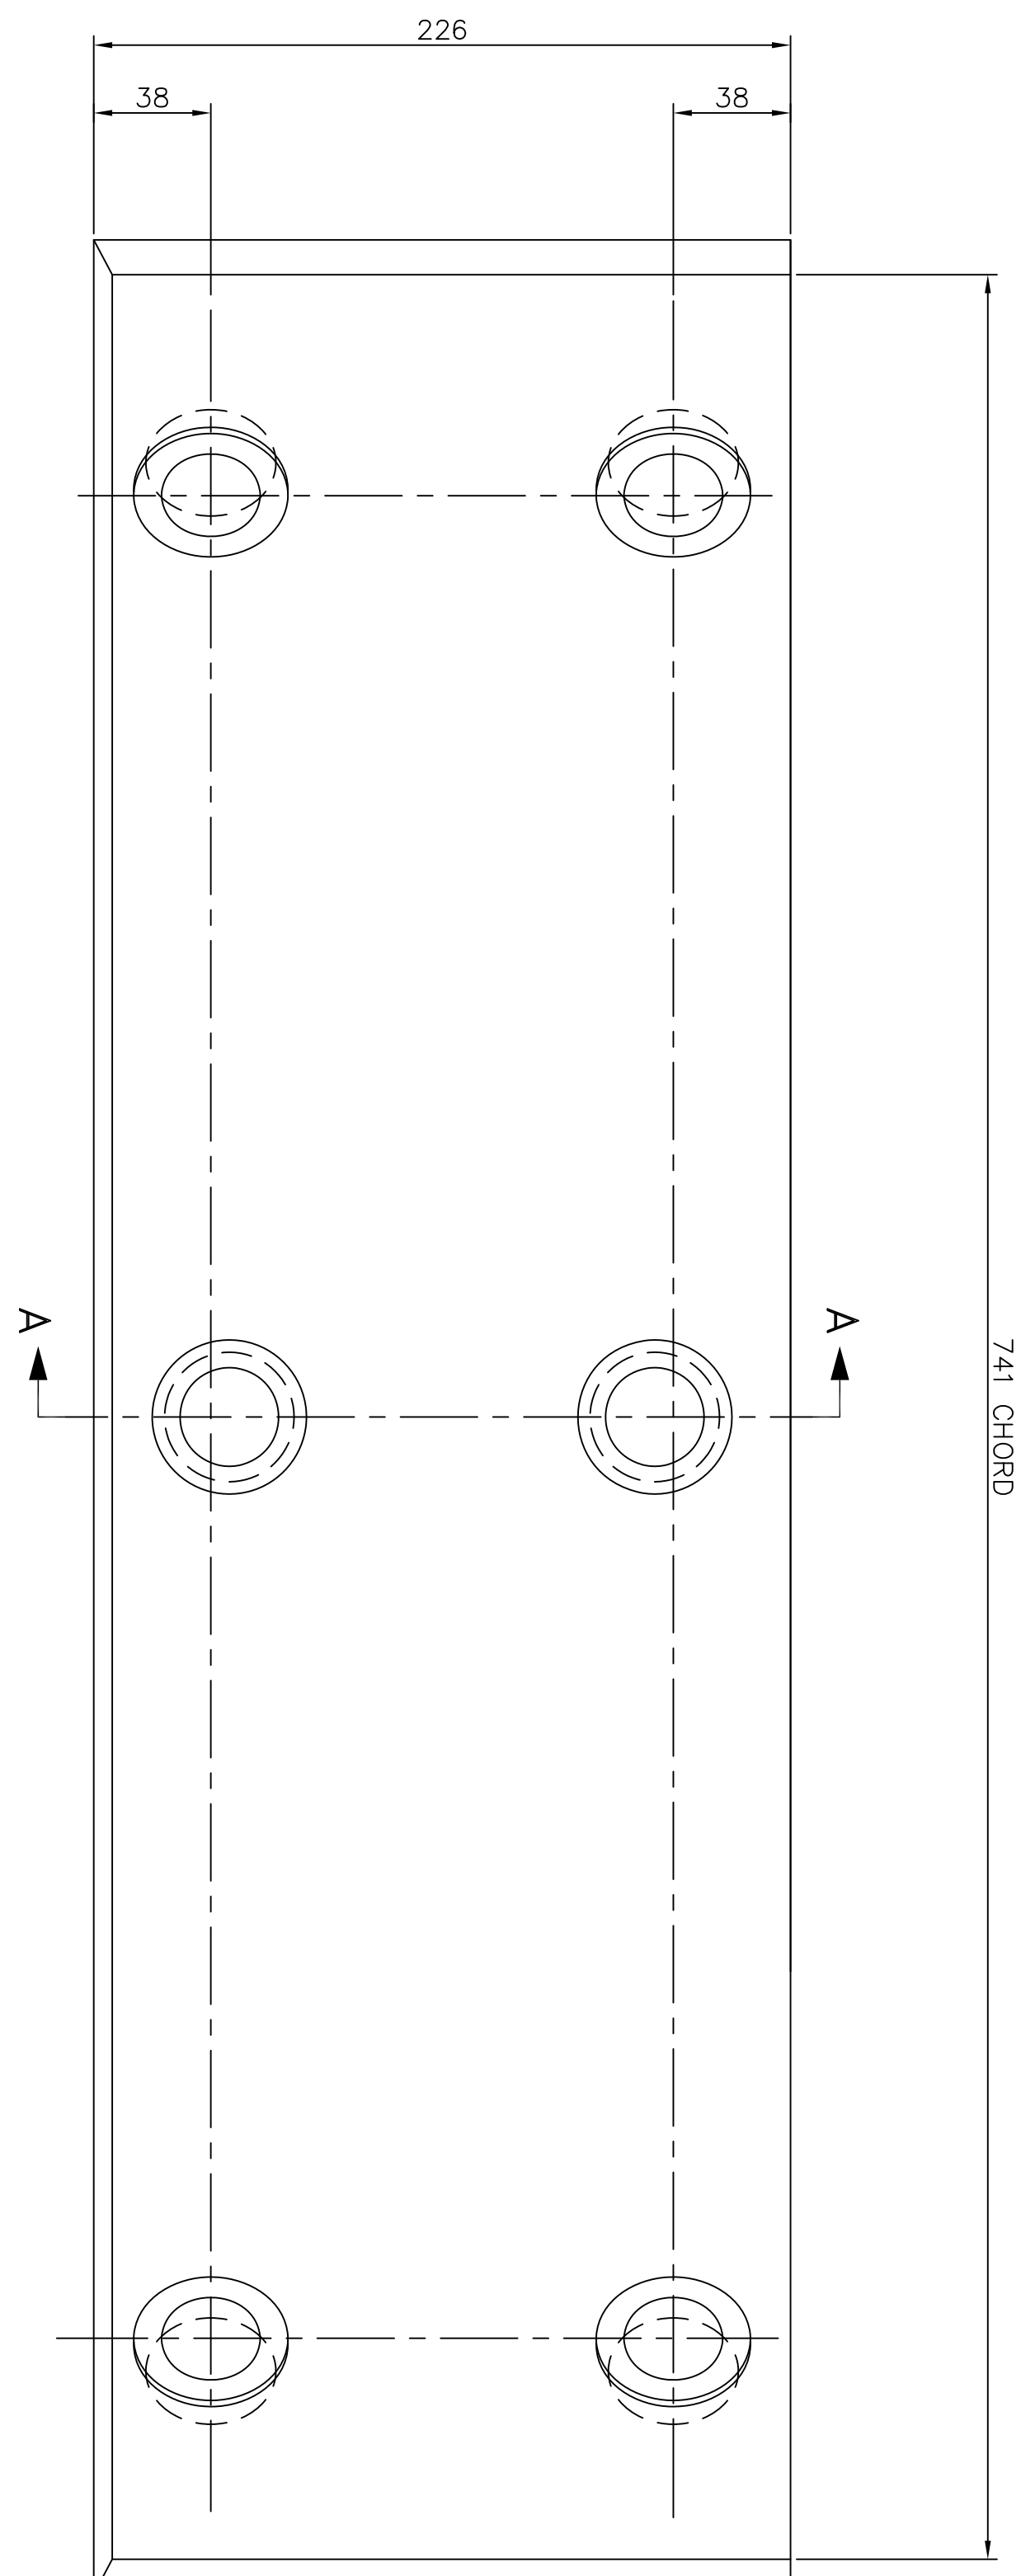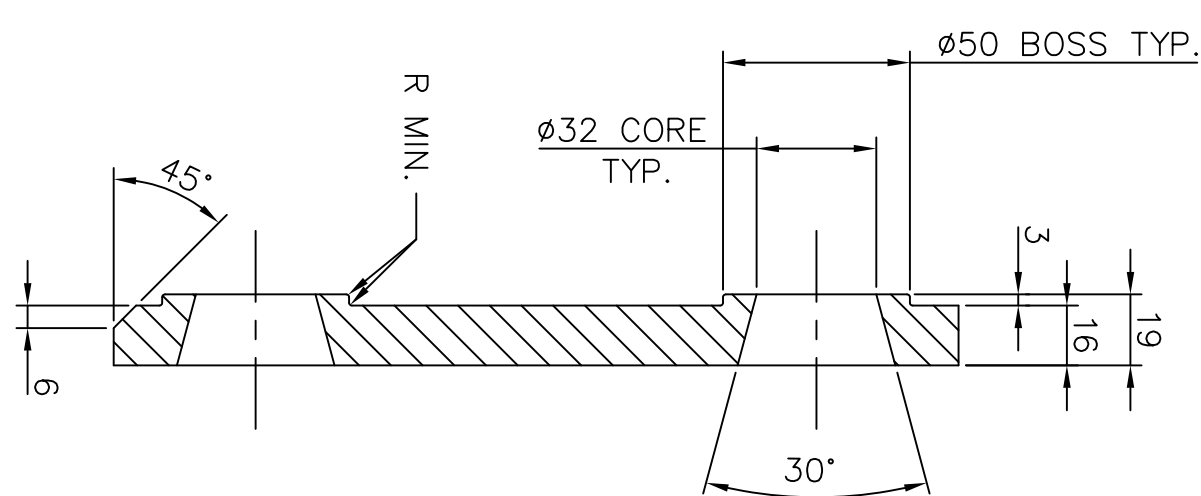

ITEM NO.	DESCRIPTION	DRAWING NO.	VAR. NO.	RAW MATERIAL, SIZE OR CASTING DRG. NO. OR FORGING DRG. NO.	QUANTITY	
					NET WT.	GROSS WT.
CASTING					BA9114135183	24.00
					AA 19741	

THE FOLLOWING CONDITIONS APPLY EXCEPT OTHERWISE STATED.

1. REF. TO HY0230261 FOR UNSPECIFIED TOLERANCES.

2. CHAMFER M/OD. SHARP EDGES 1.2 TO 1.0 AT 45°.

1103 BOWL MILL

NAME	SIGN.	DATE	NO. OF VRS.
DRN. C.C.S		12.06.99	
CHD. E.M.A		12.06.99	
APPL. K.M.RAO		12.06.99	


DRAWING

BHEIL

**BARHAT HEAVY ELECTRICALS LIMITED**

**HYDERABAD**



TYPE OF PRODUCT					
NAME OF CUSTOMER/PROJECT					
<b>1103 BOWL MILL</b>					
NAME	SIGN.	DATE	NO OF WRK.		
DIN C.C.S		12.06.99			
CHD. E.M.A		12.06.99			
APPLIK M.RAO		12.06.99			

DEPT. PULL V	INTOL DIMS OR S.M./F	SCALE	WEIGHT (KG)	REF. TO ASSY DRG.	ITEM NO.	NO OF REV.
CODE 446		1:2	2.0.00	01-004-01189 (0-10-00987/0)		
TITLE				DRAWING NO.		
JOURNAL HEAD LINER				1-61-004-01187		
SHEET NO. 01		NO OF SHEETS		01		






INVENTORY NO	SIGN. AND DATE	REF. DRG. NO. (D-110-00967/0)	COMPUTER FILE NAME 16101187.DWG
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TYPE OF WELD	LENGTH OF WELD IN M	W.P.S
6D	0.1M	WE:006



NOTE:-  
01. BREAK ALL SHARP EDGES AND CORNERS  
UNLESS OTHERWISE NOTED.

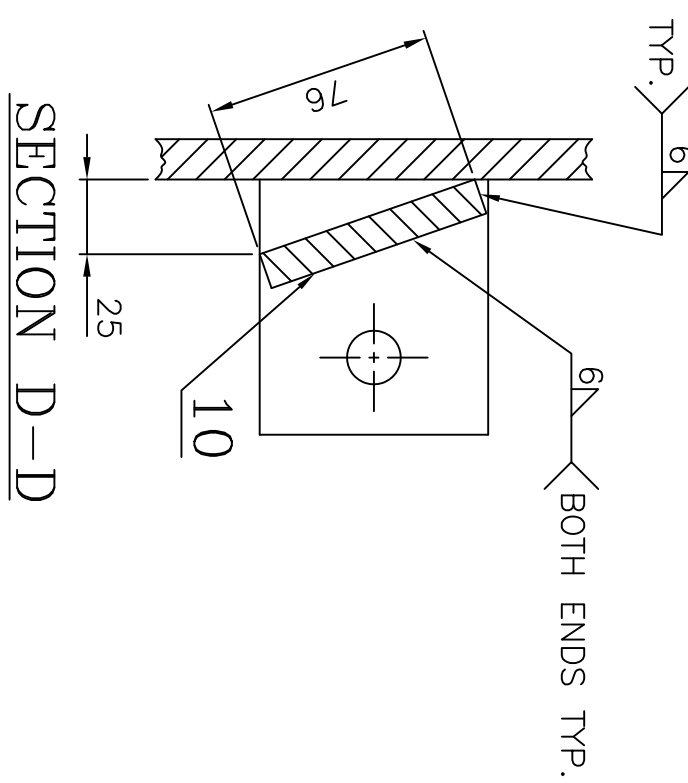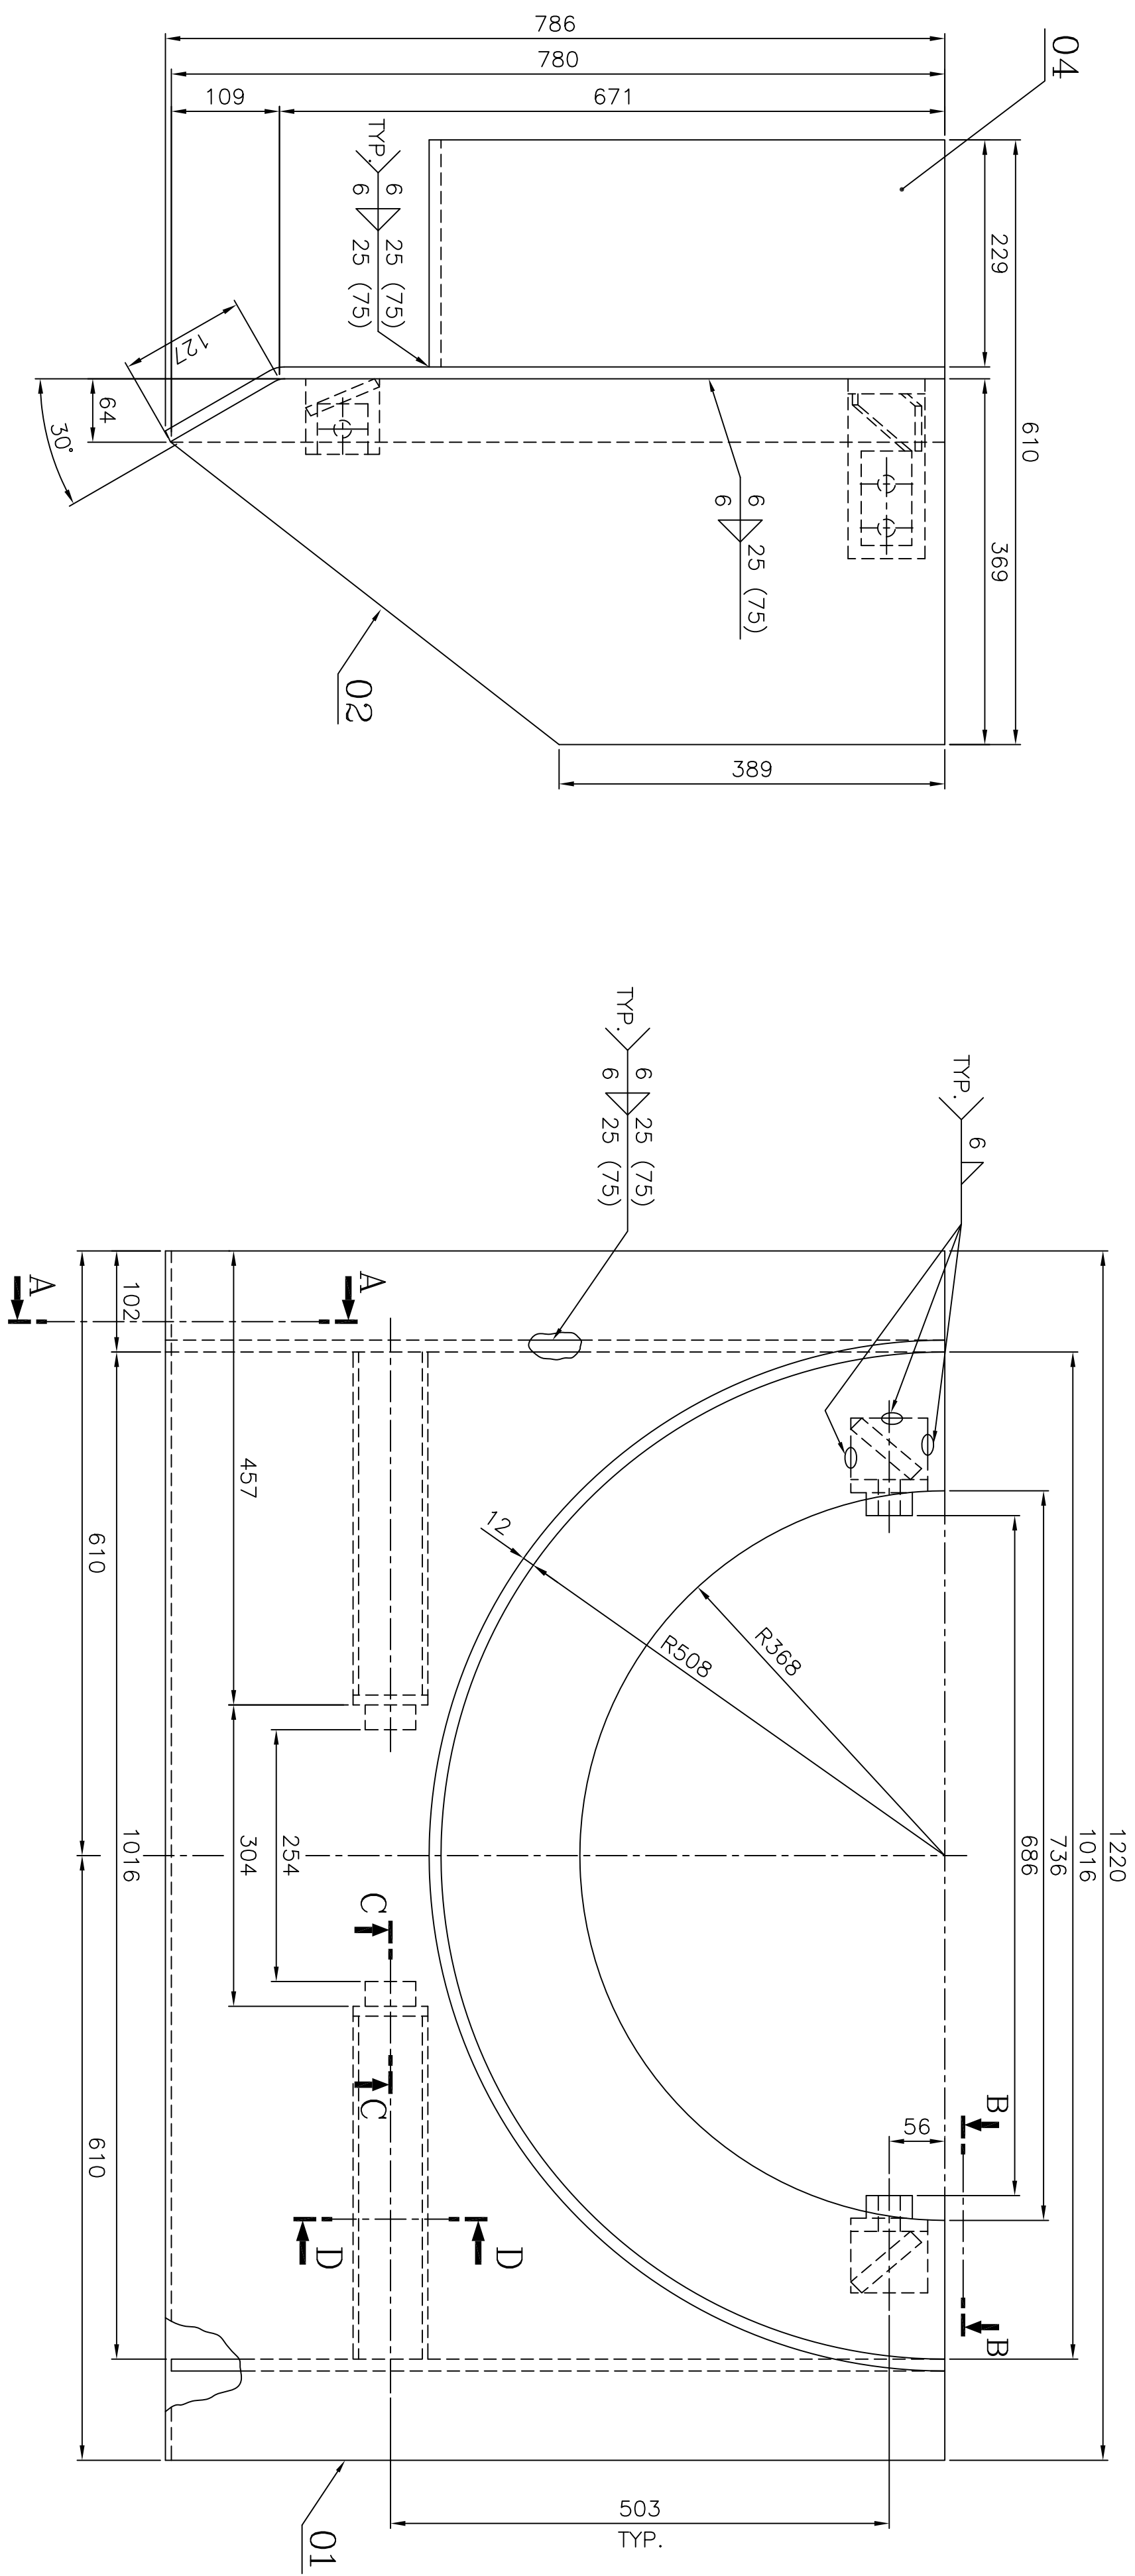[illegible]

THE FOLLOWING CONDITIONS APPLY EXCEPT OTHERWISE STATED.

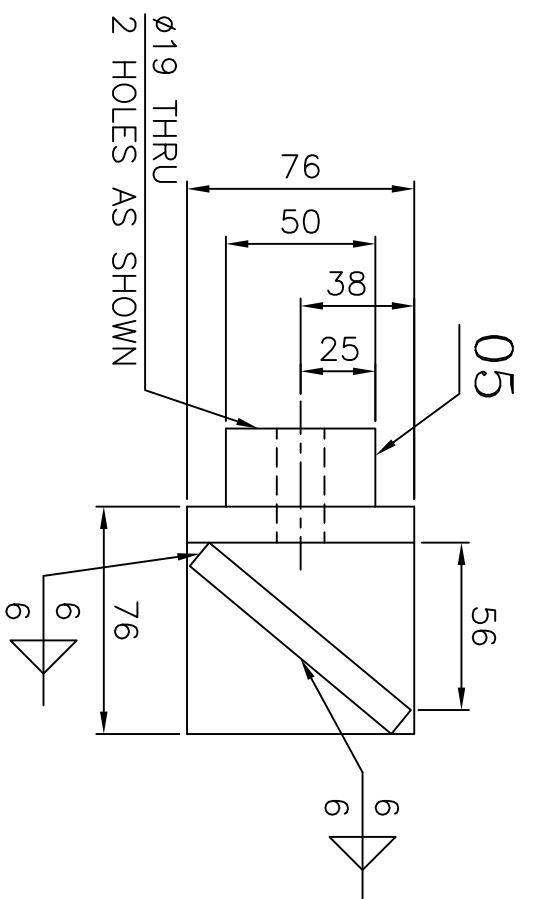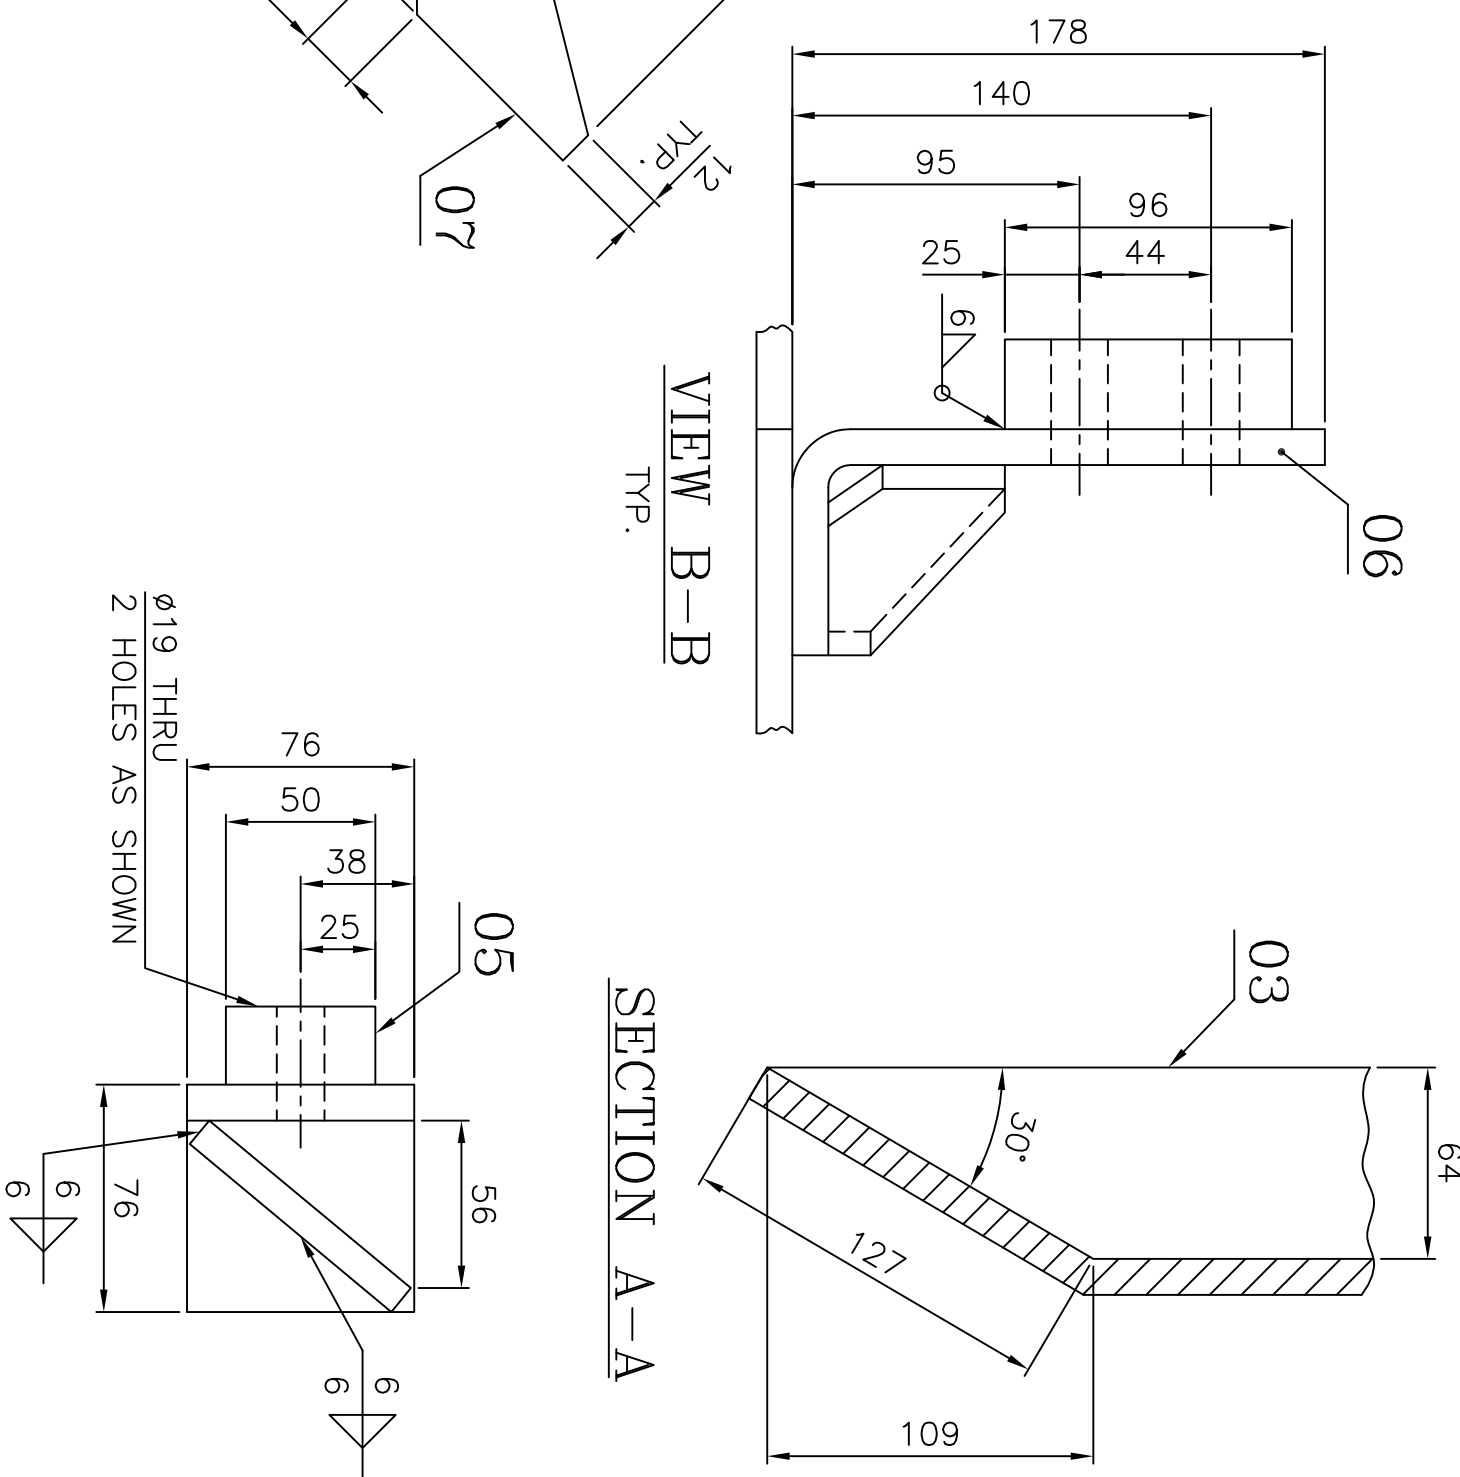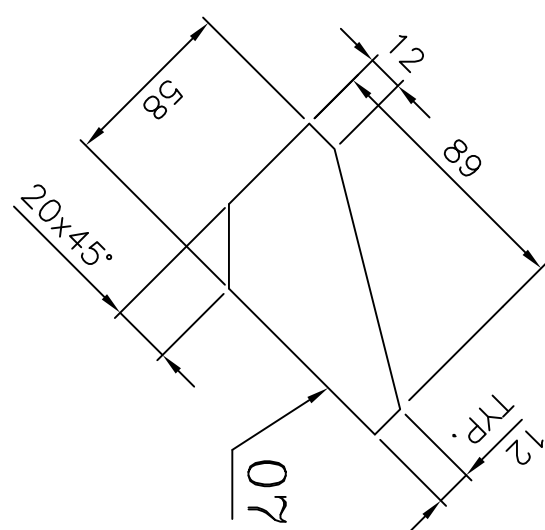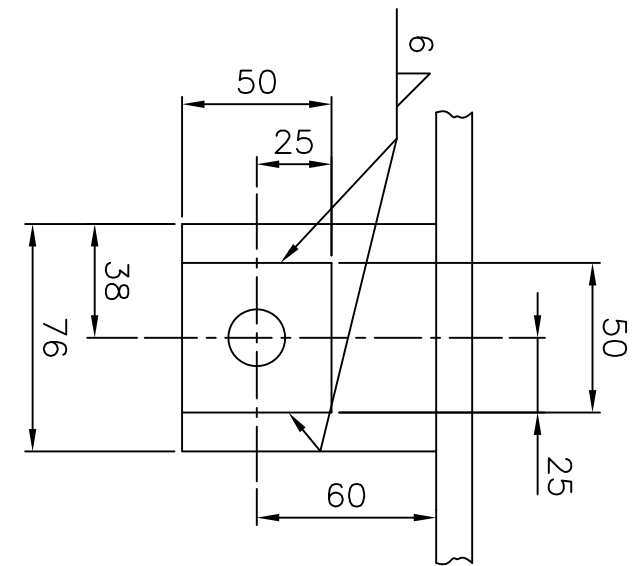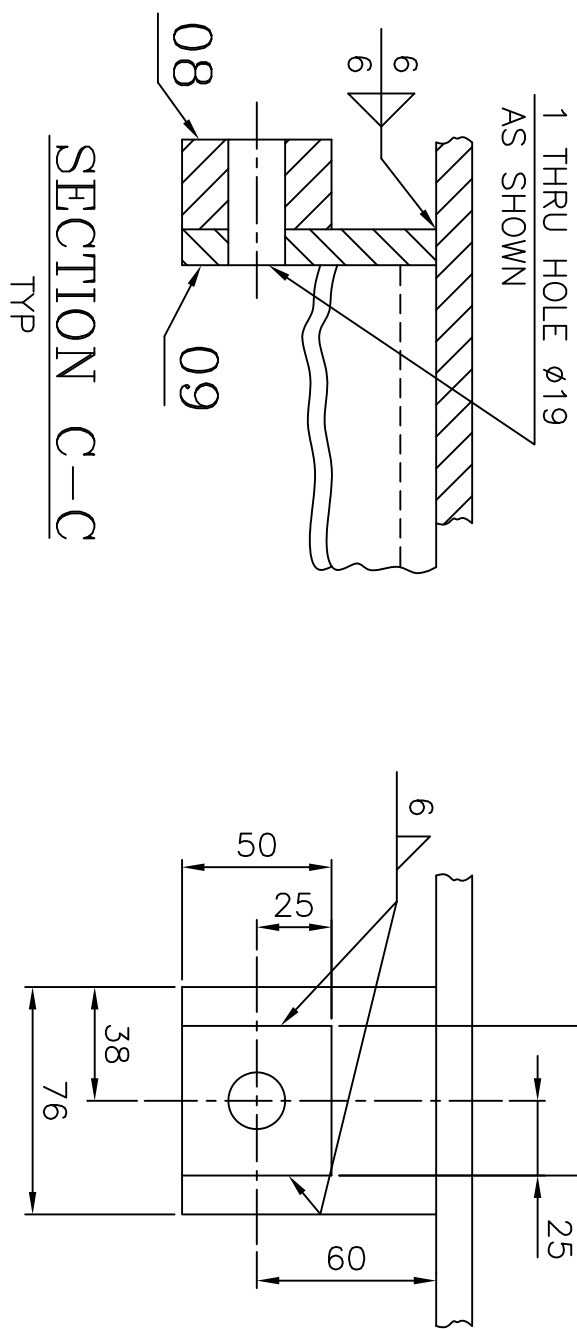1. REF. TO HY0230261 FOR UNSPECIFIED TOLERANCES.

2. CHAMFER M/CD. SHARP EDGES 1.2 TO 1.0  
AT 45°

3. INTERNAL M/CD. CORNER RADII 1 TO 1.5 TIMES THE THICKNESS OF THE DRG.
4. THE SURFACE ROUGHNESS WHERE-EVER SHOWN SHALL BE TAKEN FROM THE SURFACE ROUGHNESS SHOWN OUTSIDE THE BACK SLASH GIVEN ON THE TOP MOST RIGHT CORNER OF THE DRG.

[illegible]

INVENTORY NO	SIGN. AND DATE	REF. DRG. NO.	COMPUTER FILE NAME								
		1-61-004-01189	16101188.DWG								

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
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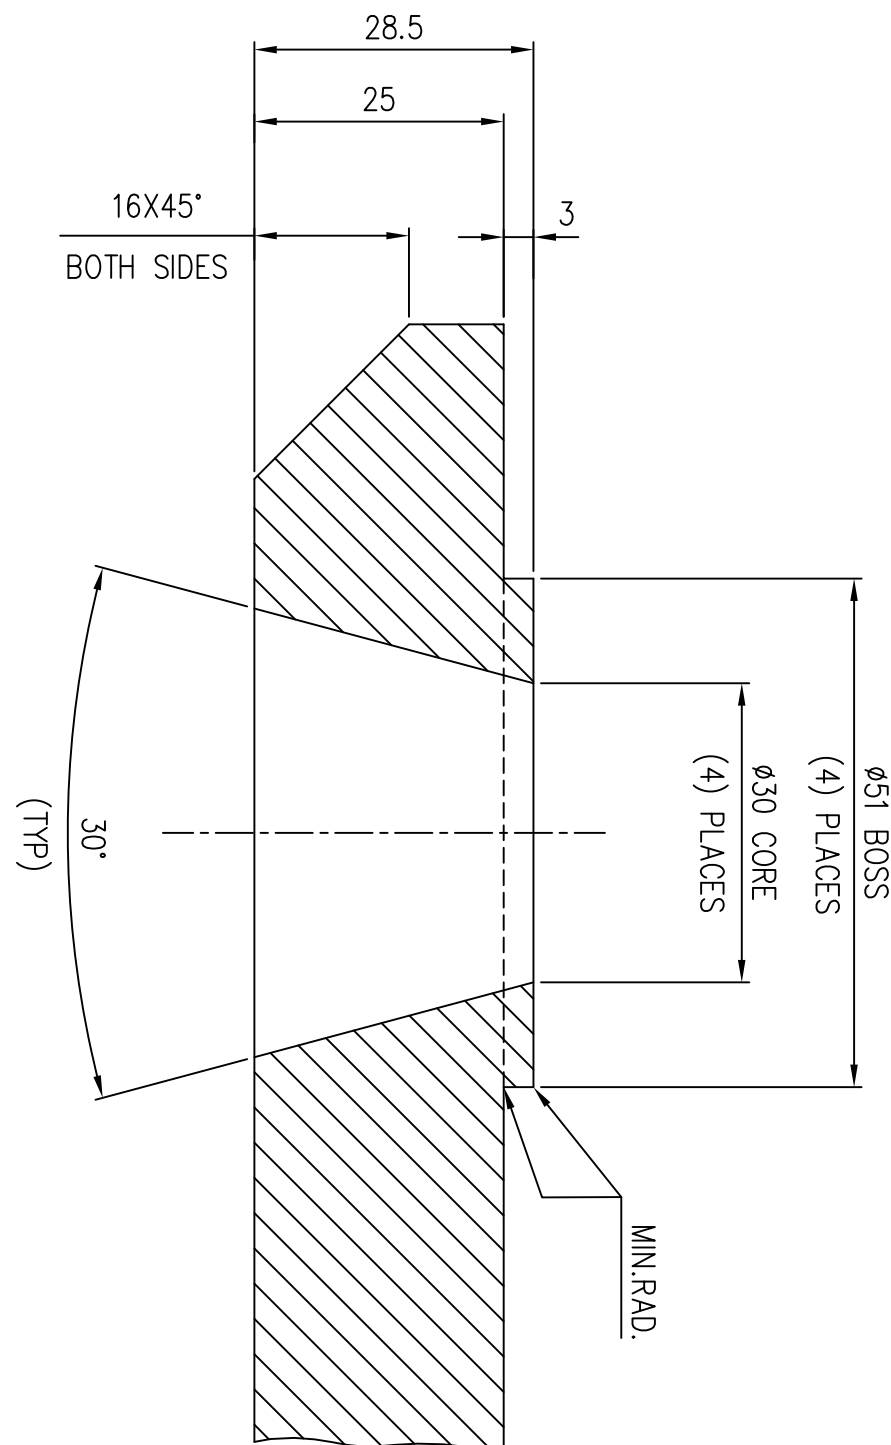
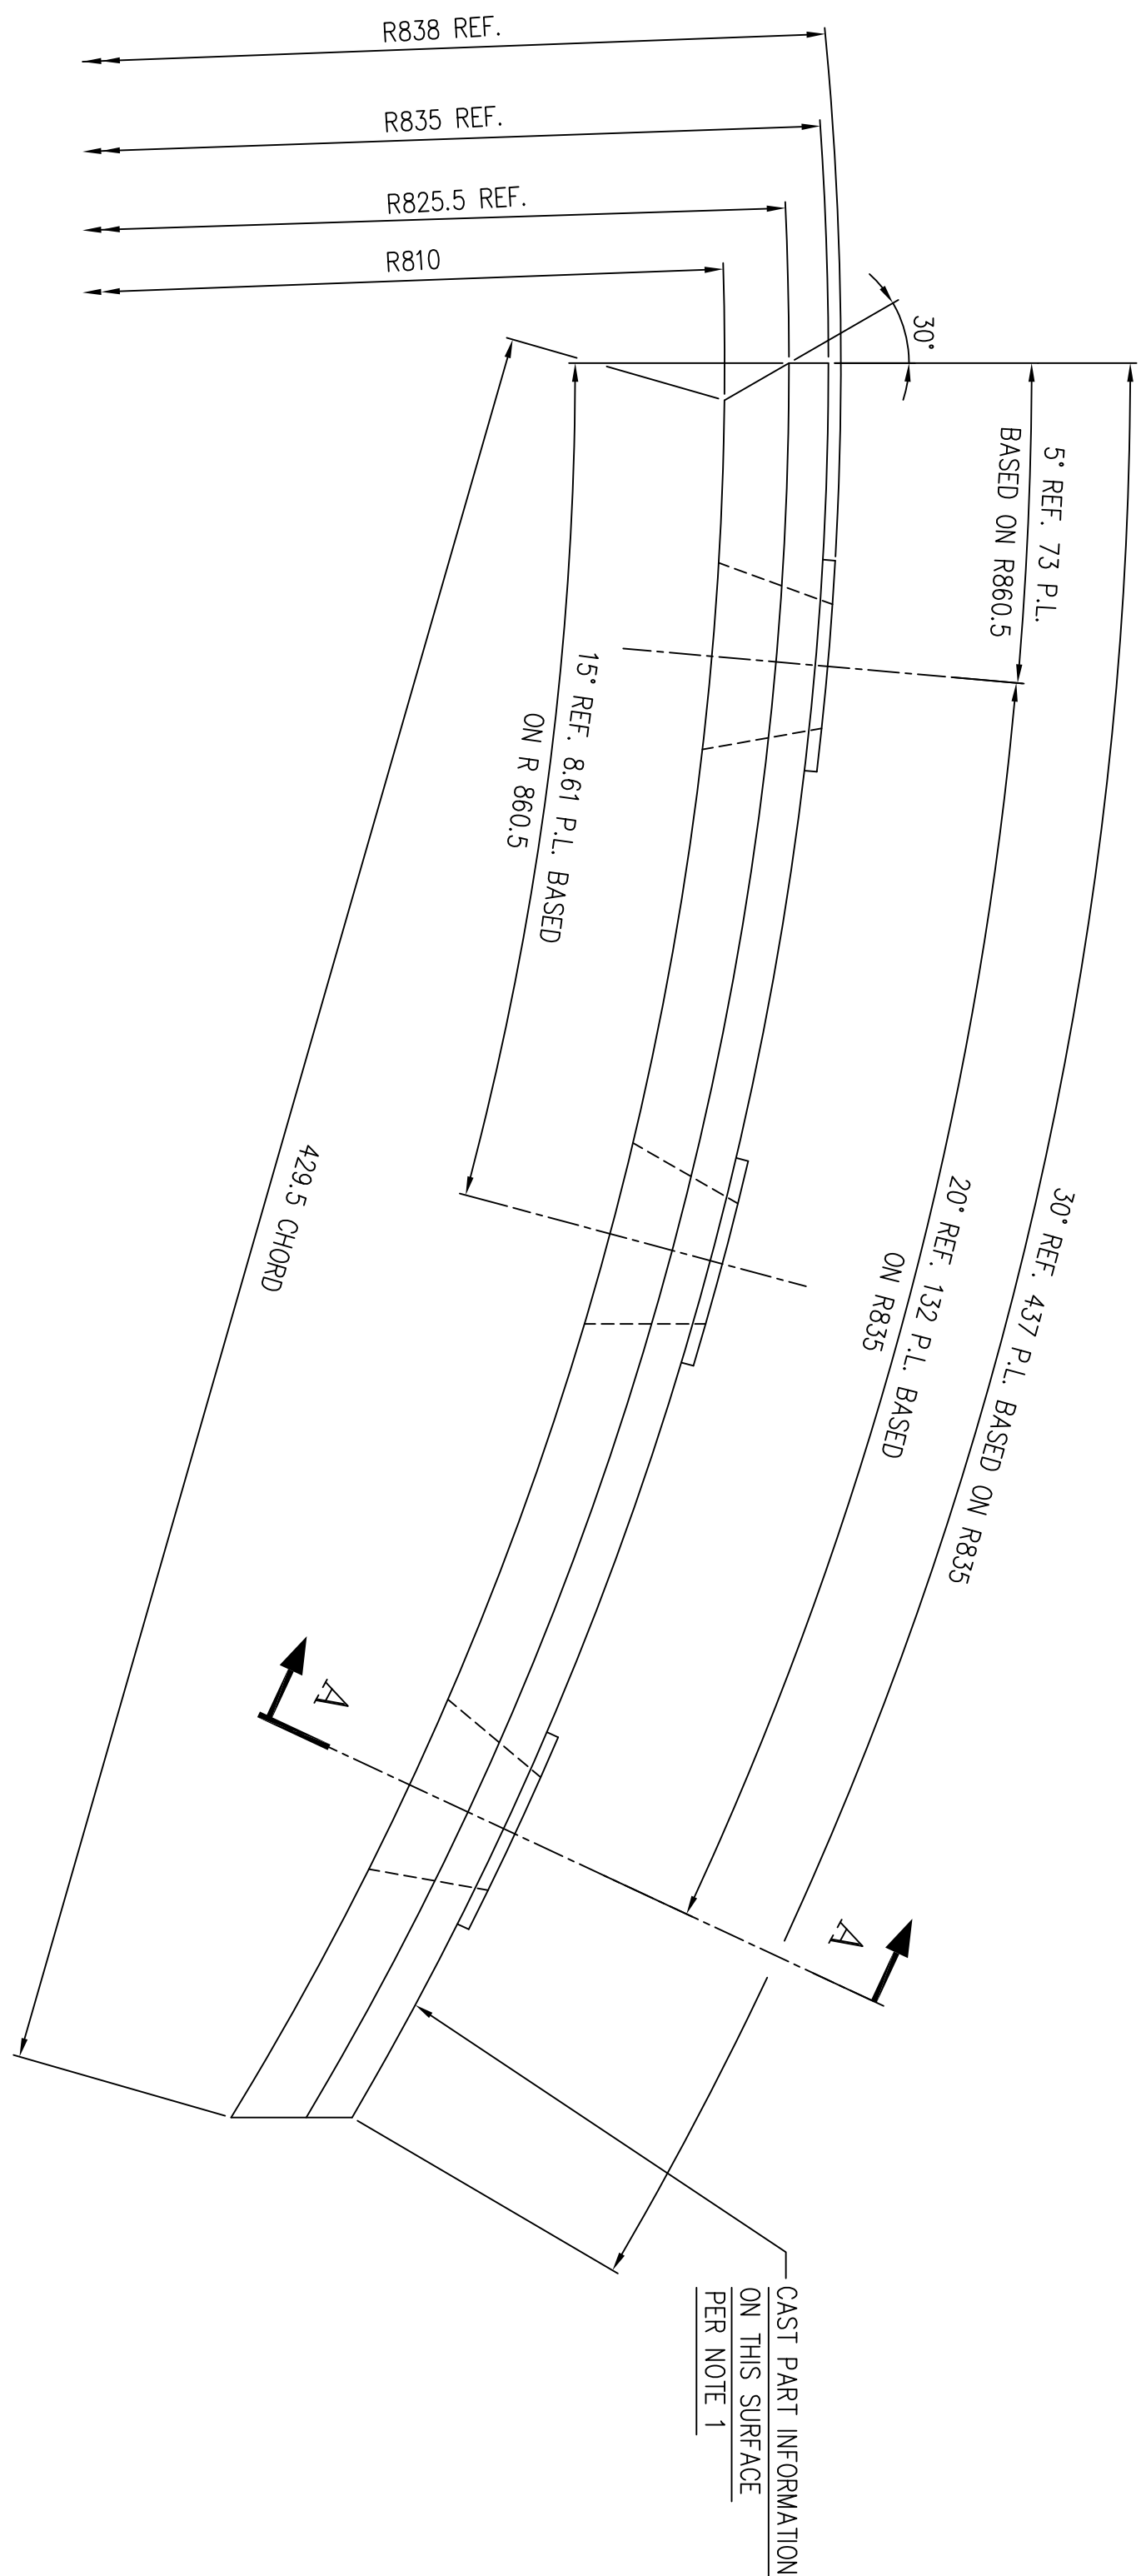


- | ITEM NO. | DESCRIPTION          | DRAWING NO.    | VAR. NO. | RAW MATERIAL SIZE OR CASTING DRG. NO. OR TIRING DRG. NO. | MATERIAL CODE MATERIAL SPECN | NET WT.  | GROSS WT. |
|----------|----------------------|----------------|----------|--|------------------------------|----------|-----------|
|          |                      |                |          |  |                              | QUANTITY |           |
| 07       | WELD PLUG            | 4-61-162-00749 |          |  |                              | 0.13     |           |
| 06       | JOURNAL HD. LINER    | 2-61-004-02259 |          |  |                              | 26.700   | 36        |
| 05       | JOURNAL HD. LINER    | 2-61-004-02258 |          |  |                              | 16.200   | 1         |
| 04       | JOURNAL HD. LINER    | 1-61-004-01187 |          |  |                              | 24.00    | 2         |
| 03       | JOURNAL HEAD LINER   | 2-61-004-02267 |          |  |                              | 17.200   | 2         |
| 02       | JOURNAL HEAD LINER   | 2-61-004-02268 |          |  |                              | 17.200   | 1         |
| 01       | JOUR-HD-LINER SUPPRT | 1-61-004-01188 |          |  |                              | 143.480  | 1         |
|          |                      |                |          |  |                              |          |           |
|          |                      |                |          |  |                              |          |           |


REV. DATE	CHD/APPD.	REV. DATE	ALTERED CHD/APPD.	REV. DATE	ALTERED CHD/APPD.	REV. DATE	ALTERED CHD/APPD.
				01 09.06.99			
				DRAWING RETIRARIN IN AUTO-CAD			

<p>THE FOLLOWING CONDITIONS APPLY EXCEPT OTHERWISE STATED:</p> <p>1. REF. TO HY92061 FOR UNSPECIFIED TOLERANCES.</p> <p>2. CHAMFER M/C/D. SHARP EDGES 1:2 TO 1:0 AT 45°.</p> <p>3. INTERNAL M/C/D. CORNER RADI 1 TO 0.7</p> <p>4. THE SURFACE ROUGHNESS WHERE-EVER NOT SHOWN SHALL BE TAKEN FROM THE BACK SLASH GIVEN BUT THE TYPE MOST RIGHT CORNER OF THE DRG.</p>									
<p>TYPE OF PRODUCT</p> <p>NAME OF CUSTOMER/PROJECT</p>									
<p>1103 XRP BOWL MILL</p>									
<p>SHRIRAT HEAVY ELECTRICALS LIMITED</p> <p>HYDERABAD</p>									
									
DEPT.	UNIT, DIMS, GR	SCALE	WEIGHT (KG)	REF. TO ASSY. DRG.	ITEM NO.	DATE	SIGN.	NAME	DRN. C/C'S
P.U.V	Φ/π/γ	N.T.S	290.00	0-61-004-0570	1	09/06/99			09/06/99
446									
<p>TITLE</p> <p>JOURNAL HEAD LINER</p> <p>ASSEMBLY</p>									
<p>CAD CODE</p> <p>DRAWING NO.</p> <p>1-61-004-01189</p>									
<p>SHEET NO. 01</p> <p>NO OF SHEETS 01</p>									
<p>REV.</p> <p>05</p>									

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## SECTION 'B-B'





## SECTION 'B-B'

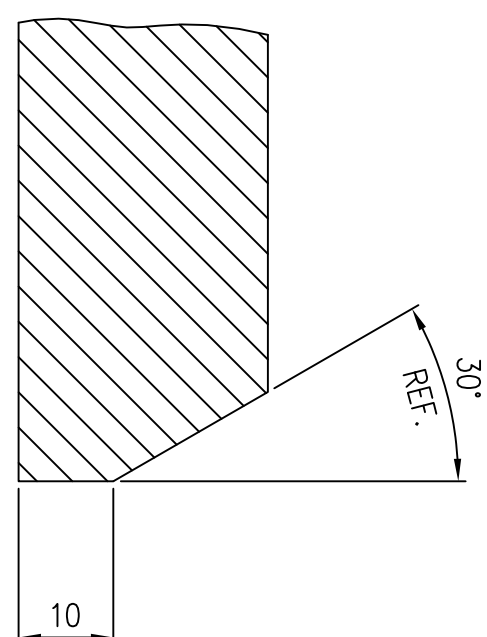
NOTE:—

1. FOOLOWING INFORMATION TO BE CAST INTO PAR USING 3MAX. HEIGHT IF RAISED LETTERS USED.  
C.E. 110-00806 (W/CURRENT DWG. REV.N2)  
CROWN 700 PAT. PENDING.


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SECTION A-A

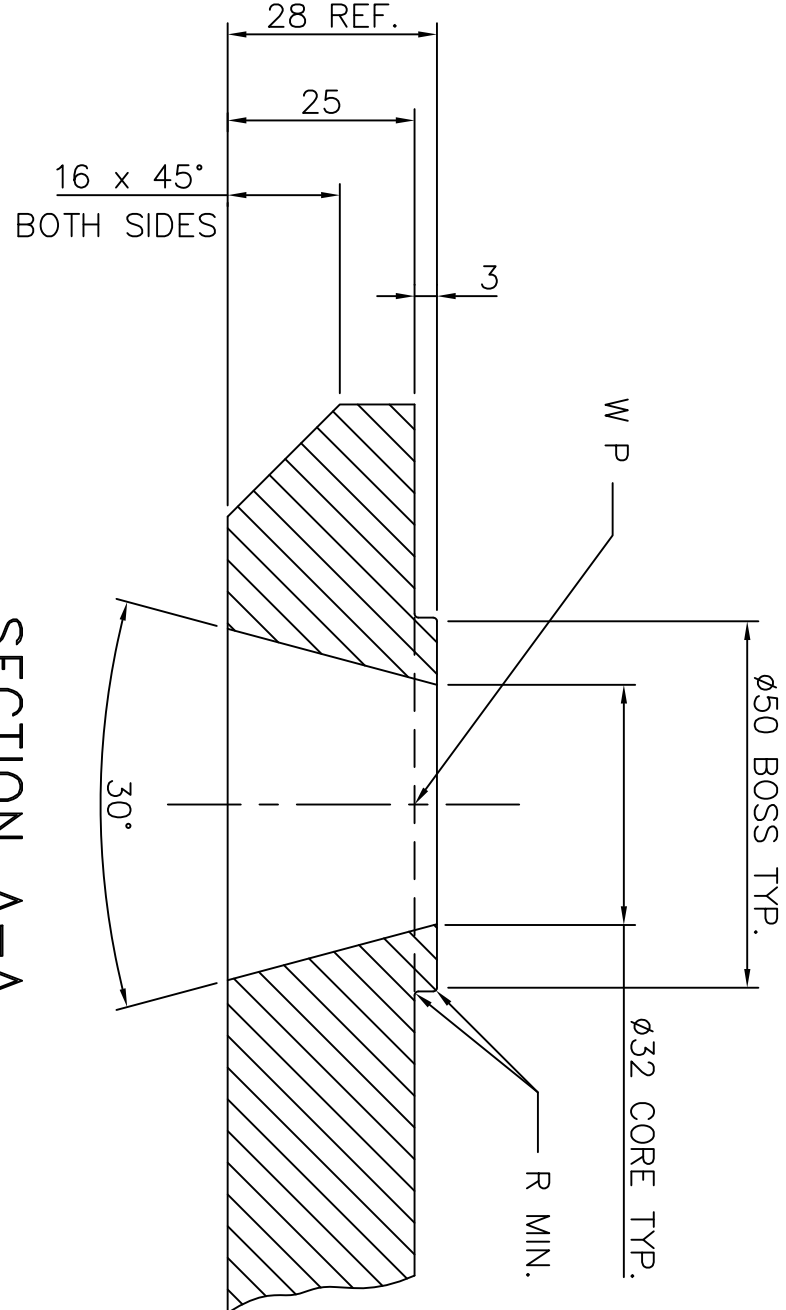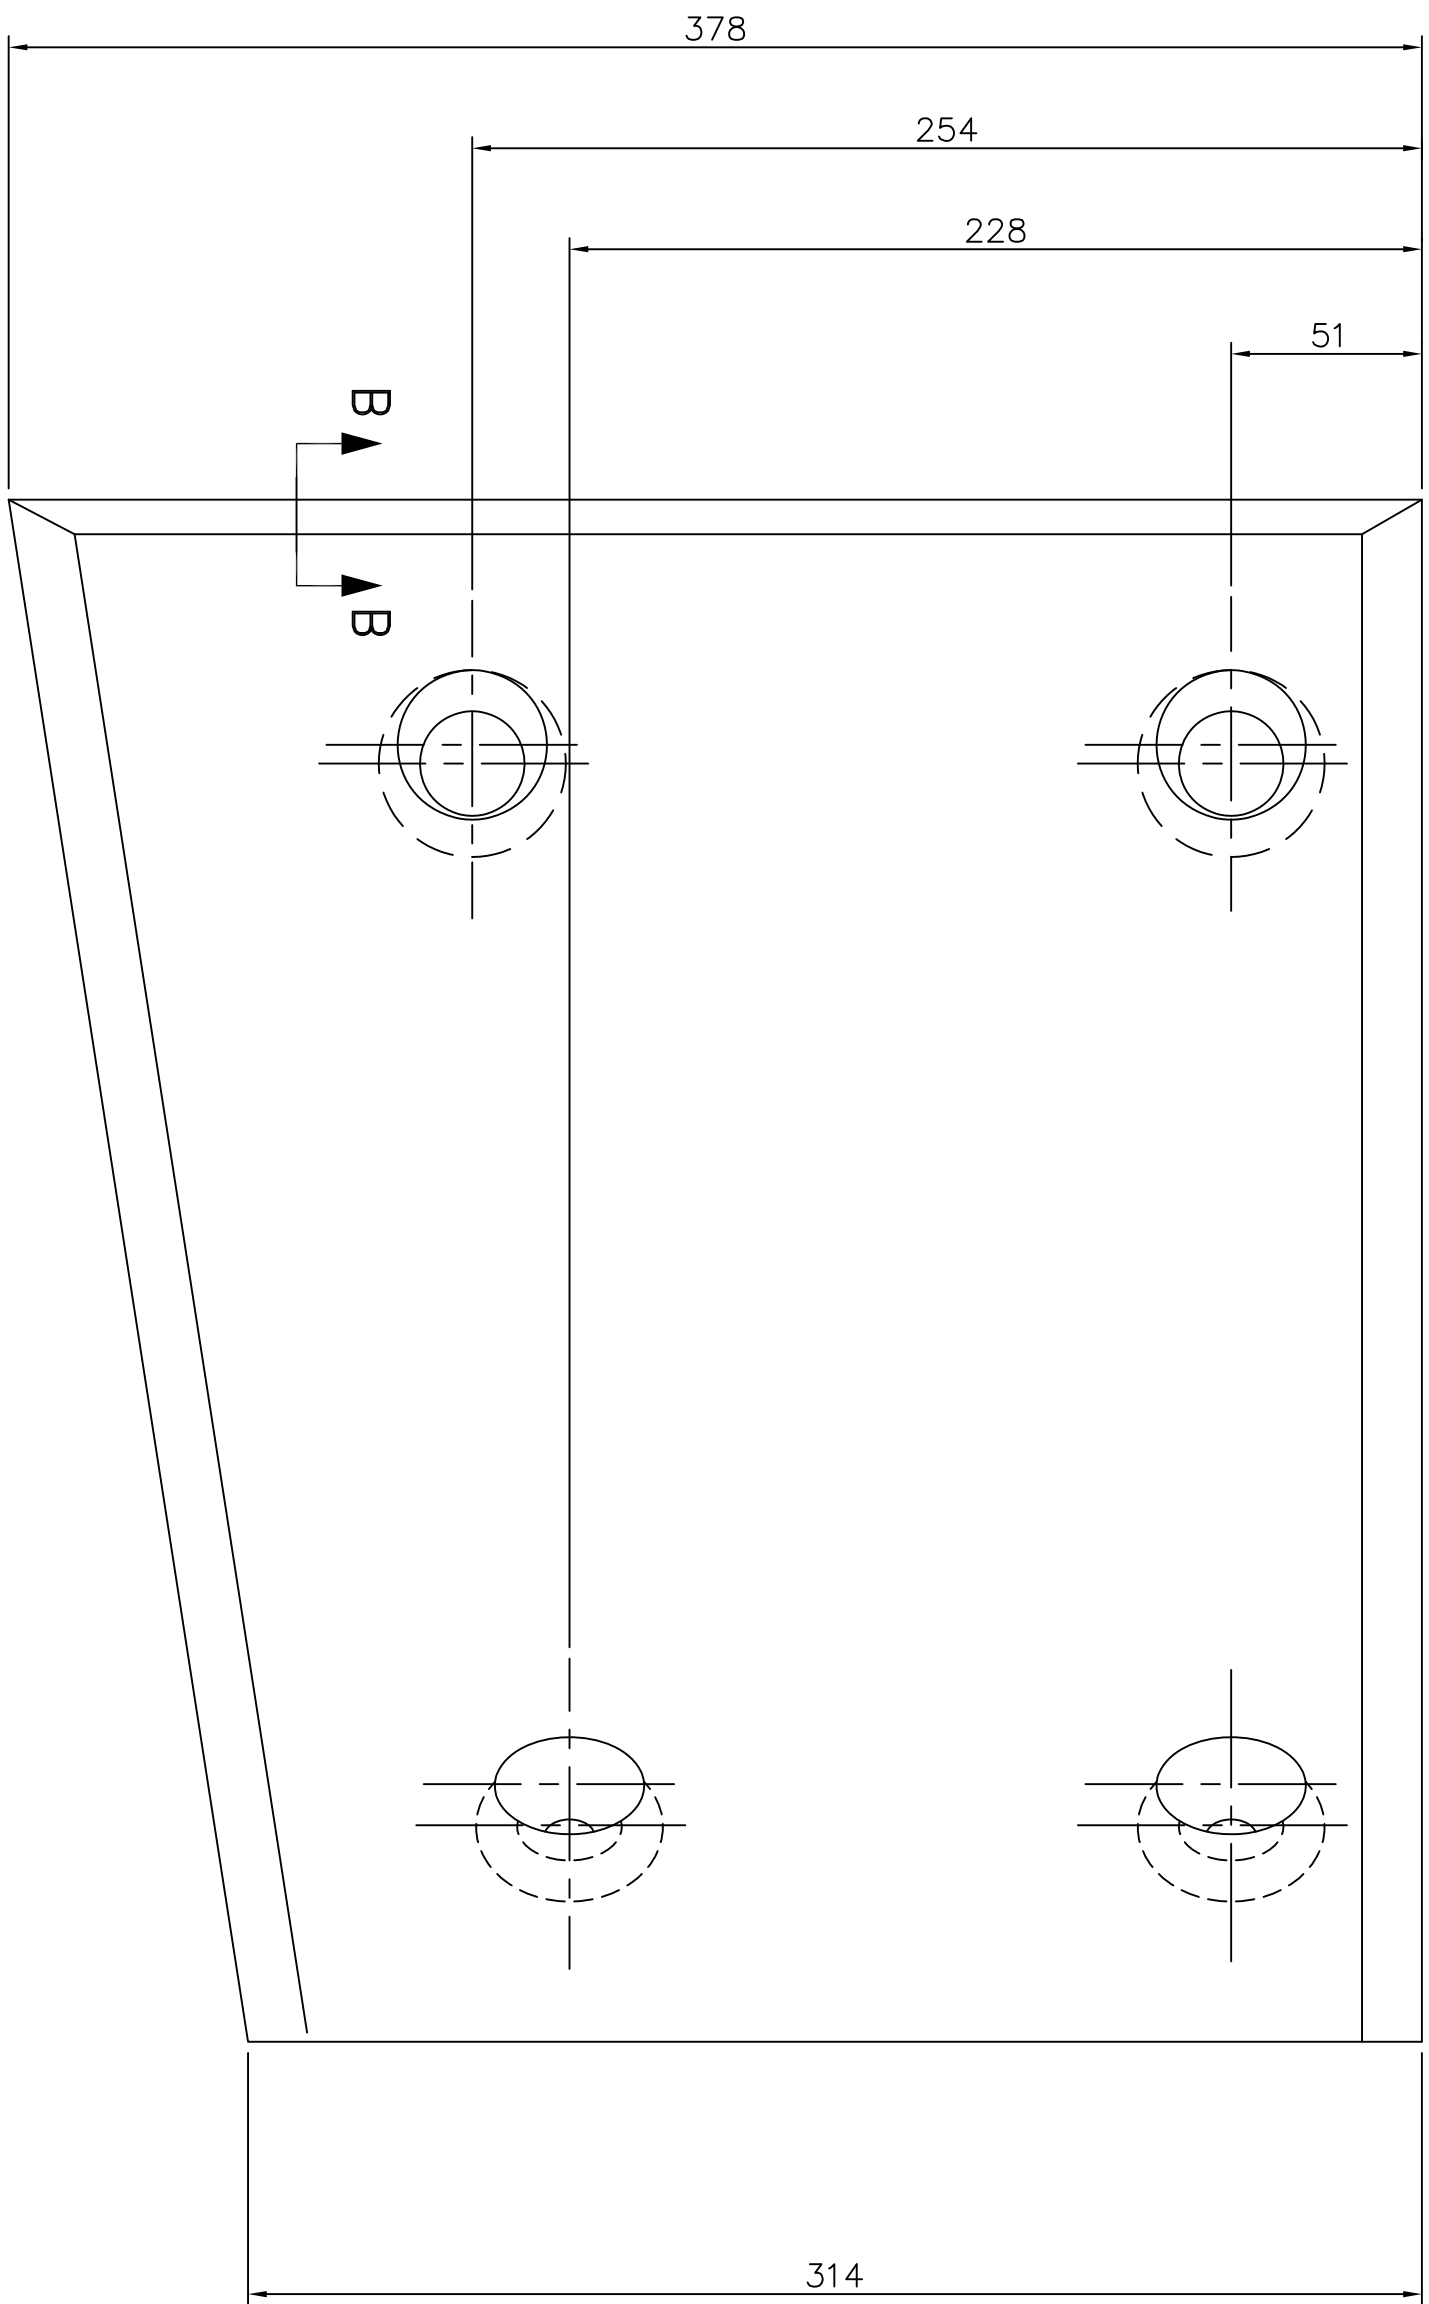

SECTION B-B

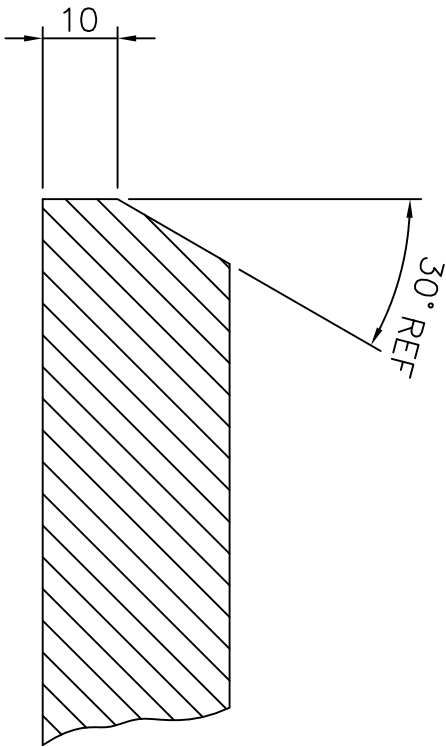

ITEM NO.	DESCRIPTION	DRAWING NO.	VAR. NO.	RAW MATERIAL SIZE OR CASTING DRG. NO. OR FORGING DRG. NO.	MATERIAL CODE	NET WT.	GROSS WT.
	CASTING				BA9114135248	22.00	
					AA 19741		

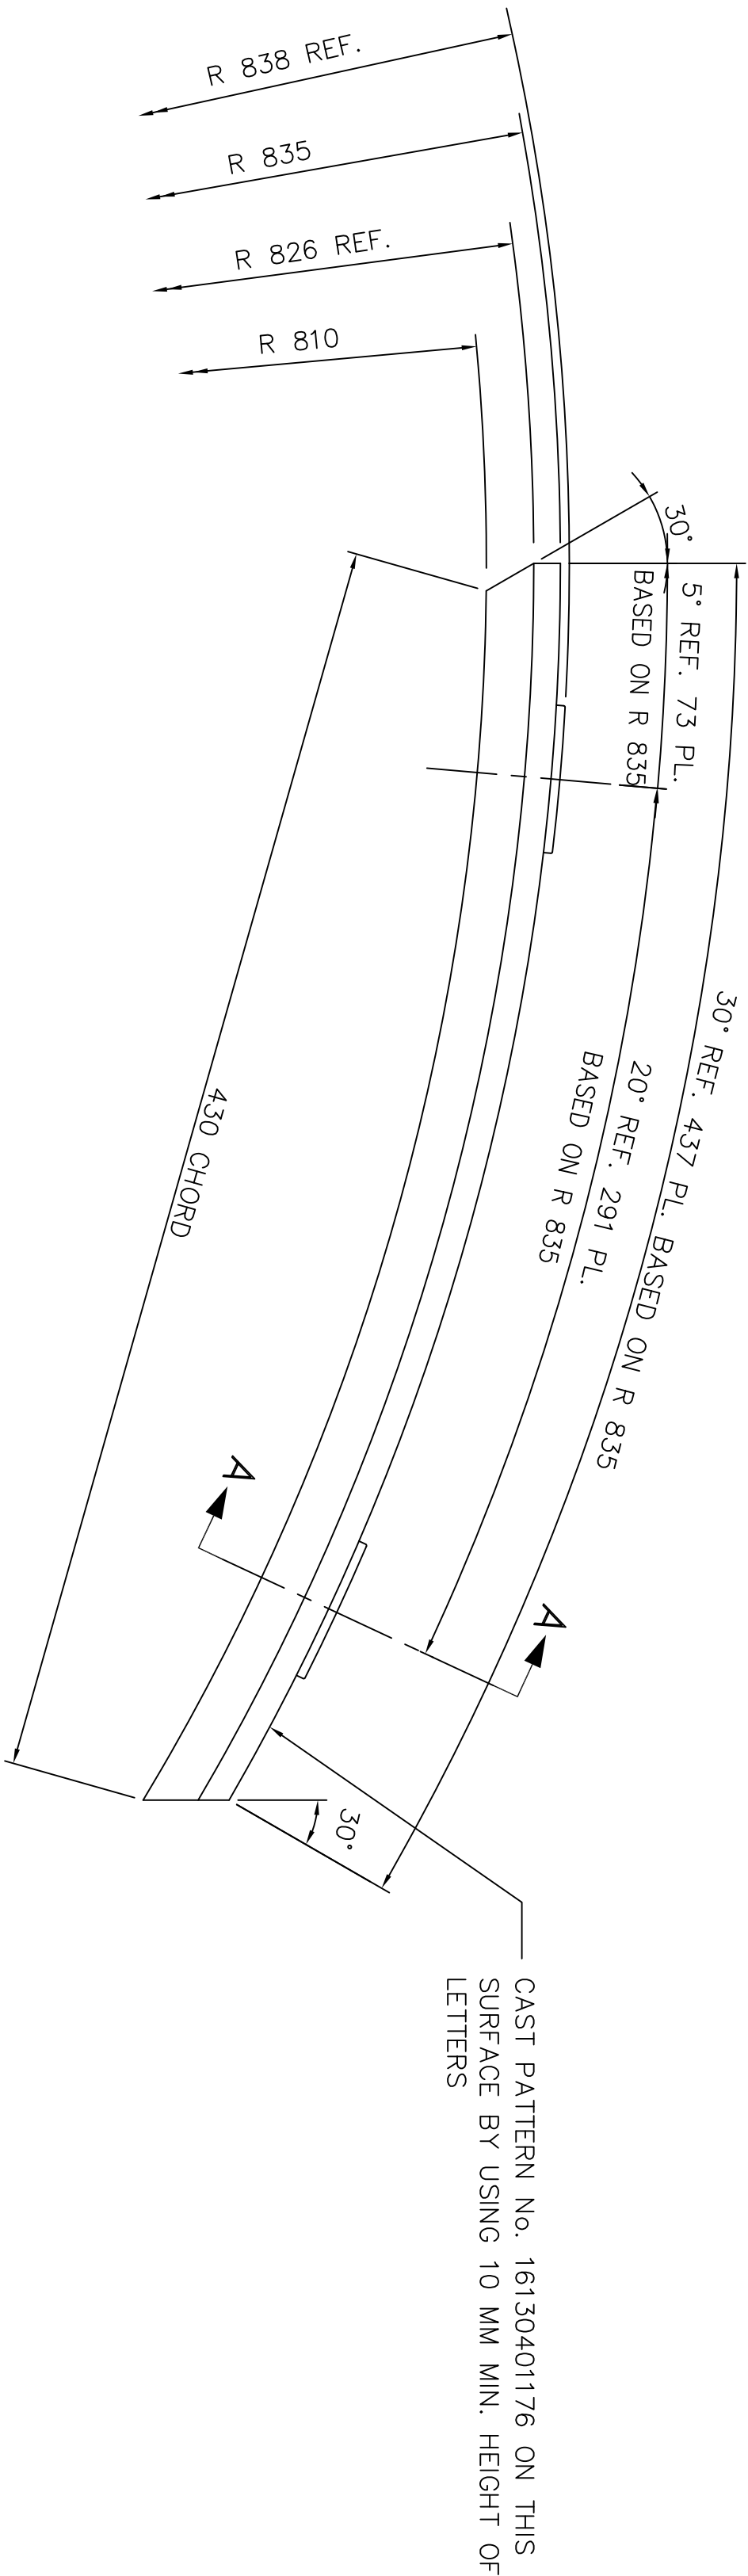THE FOLLOWING CONDITIONS APPLY EXCEPT OTHERWISE STATED.

- REF. TO HY0230281 FOR UNSPECIFIED TOLERANCES.
- CHAMFER M/C/D. SHARP EDGES 1.2 TO 1.0 AT 45°.
- INTERNAL M/C/D. CORNER RADII 1 TO 0.7
- THE SURFACE ROUGHNESS WHERE-EVER NOT SHOWN SHALL BE TAKEN FROM THE SURFACE ROUGHNESS SHOWN OUT SIDE THE BACK SLASH GIVEN OR THE TOP MOST RIGHT CORNER OF THE DRG.

TYPE OF PRODUCT				1103 XRP BOWL MILL			
NAME OF CUSTOMER/PROJECT							
BHARAT HEAVY ELECTRICALS LIMITED HYDERABAD							
DEPT. : PULV PULV							
UNIT. LMS. OR 6 M/7							
SCALE 1:2							
WEIGHT (KG) 22.00							
REF. TO ASSY DRG. (D-110-00808/1)							
DRA. NO. C.C.S.							
D. NO. N.D.SAMUEL							
APPD. S.GHATGE							
DATE 17.6.99							
ITEM NO. 17.6.99							
NO. OF ITEMS							
REV. 01							

J O F LINER

DRAWING NO.  
1-61-304-01176


SHEET NO. 01

NO OF SHEETS 01


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INVENTORY NO	SIGN. AND DATE	REF. DRG. NO.	COMPUTER FILE NAME
		(D-110-00808/1)	16101176.DWG




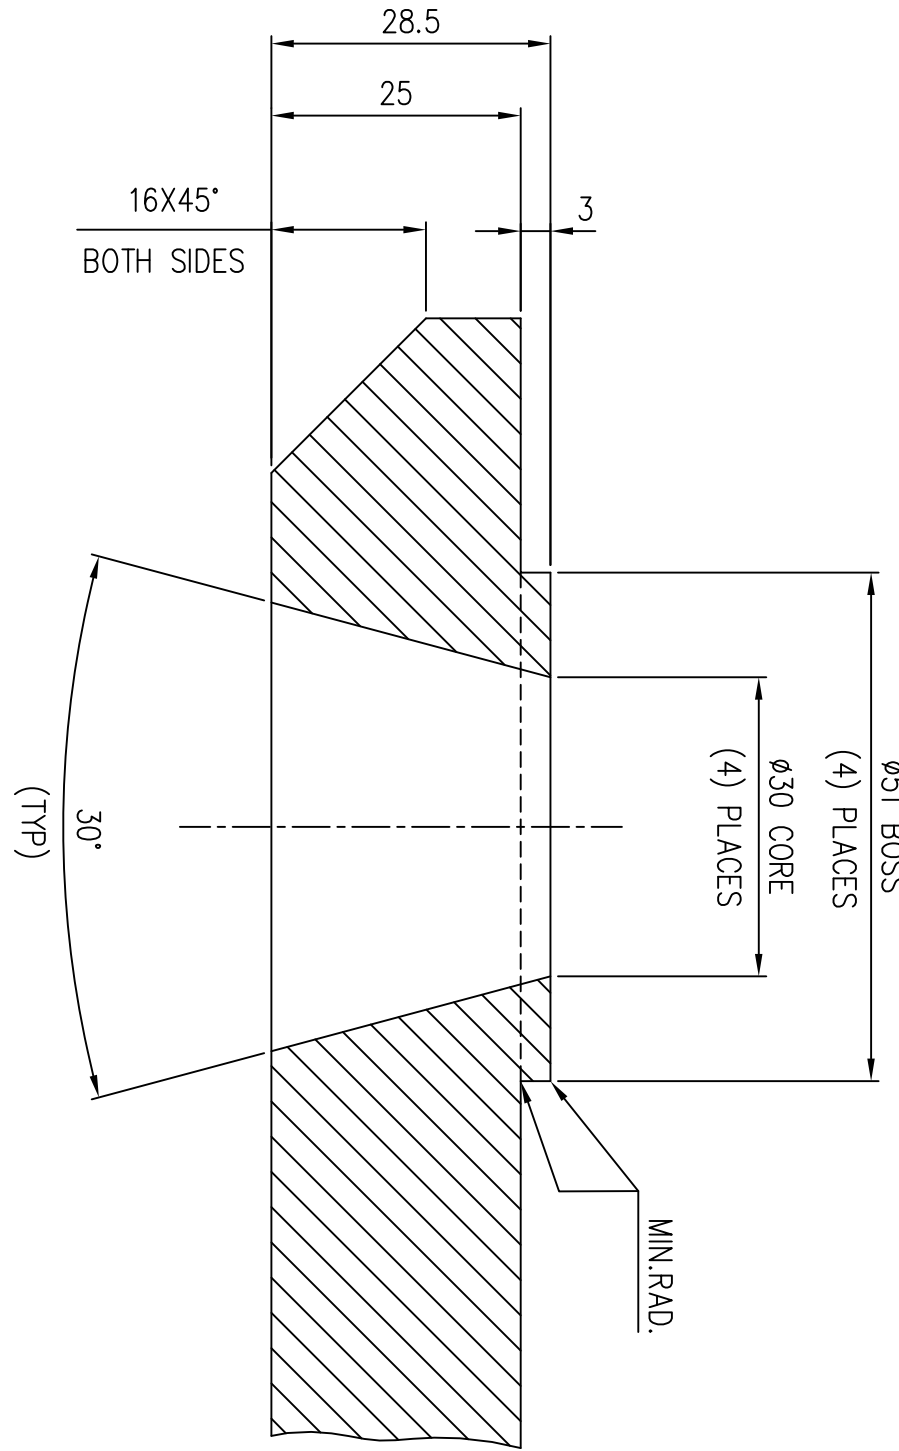

(TYP)

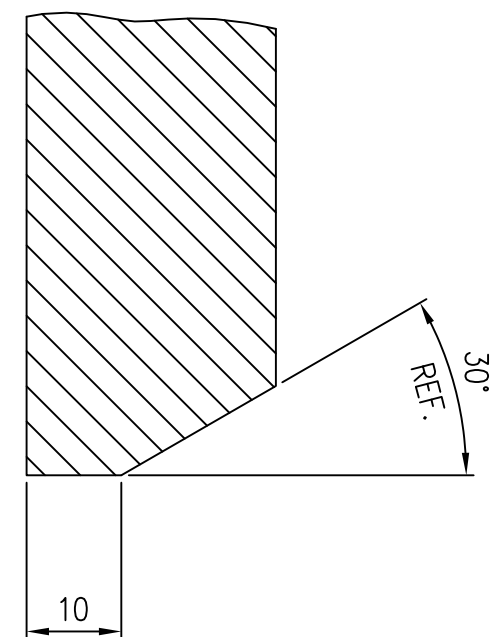

## SECTION 'B-B'

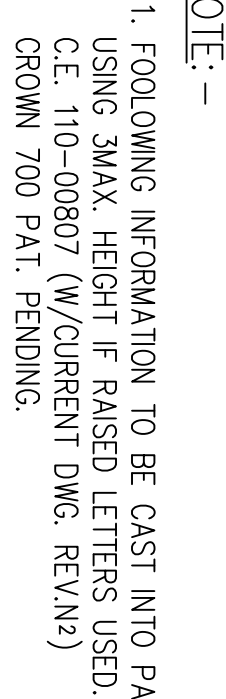

1. FOLLOWING INFORMATION TO BE CAST INTO PA  
USING 3MAX. HEIGHT IF RAISED LETTERS USED.  
C.E. 110-00807 (W/CURRENT DWG. REV.N2)  
CROWN 700 PAT. PENDING.

82.110-403-19-1

DRG. NO. 39

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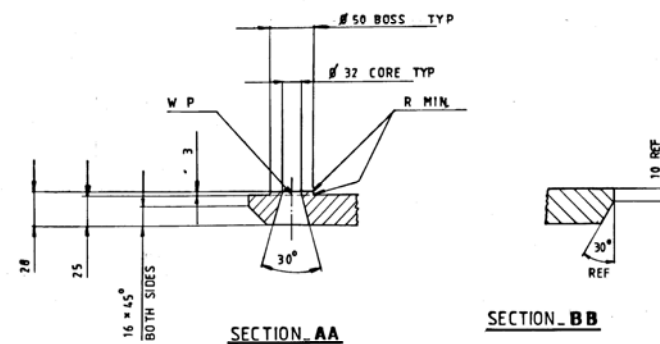
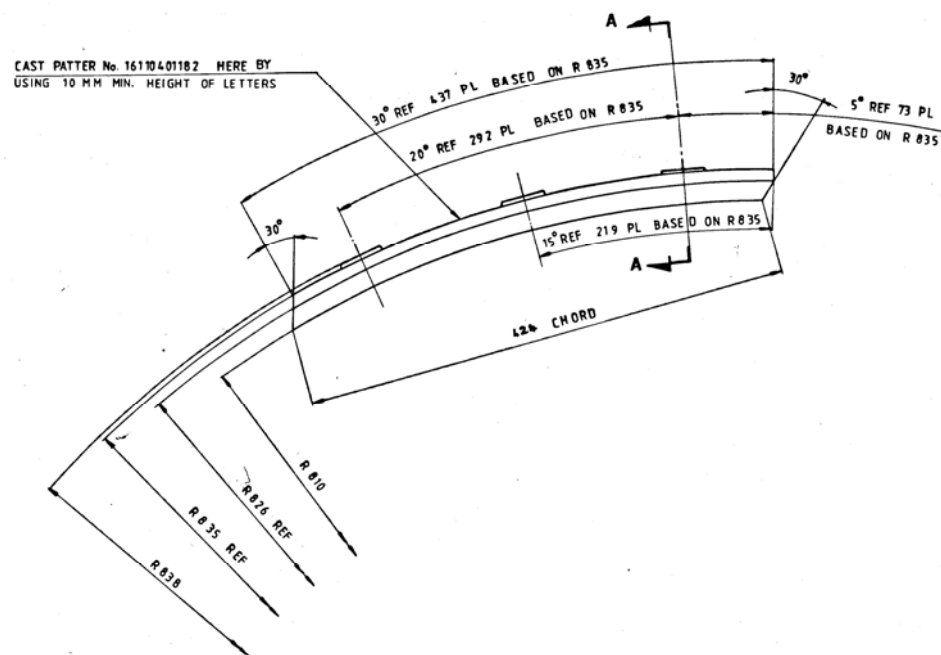
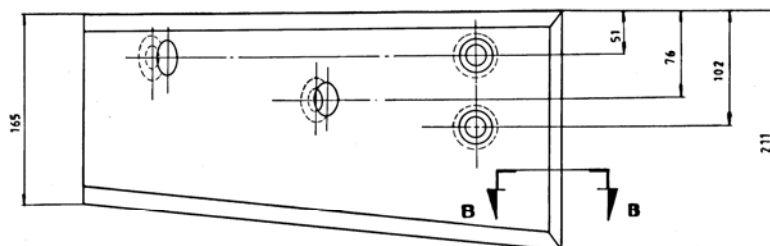
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DRG. NO. 1-61-104-01182







REFER PLANT STANDARD  
HY 0230261 FOR  
UNSPECIFIED TOLERANCES

				CASTING				PAPER NO. PA1914-35256		20.00	
								AA 19741			
VAR. OR		REMARKS		ITEM NO.		DESCRIPTION		DRAWING NO.		UNIT WT.	
CARD TYPE 3				CARD TYPE 2				CARD TYPE 1			
ADDITIONAL INFORMATION						TYPE OF PRODUCT OR NAME OF CUSTOMER/PROJECT					
STATUS OF DRAWING						CHANDRAPUR 500 MW 1043 RP					
DISTRIBUTION OF PRINTS											
REV						BHARAT HEAVY ELECTRICALS LTD.					
DATE						HYDERABAD					
ALTERED CHECKED						DIB. B H R CHD. N D S APPO. SBL RA O					
ZONE						HYDRA D.110.. 00823 / 1					
TITLE						DRAWING NO. 1.61.304_01182					
JOE LINER						CARD CODE 1.61.304_01182					

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2-61-000-00409

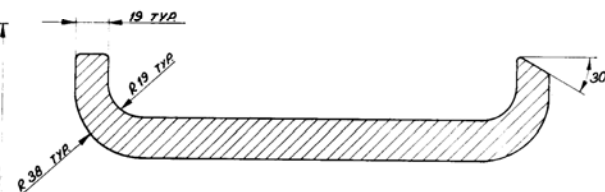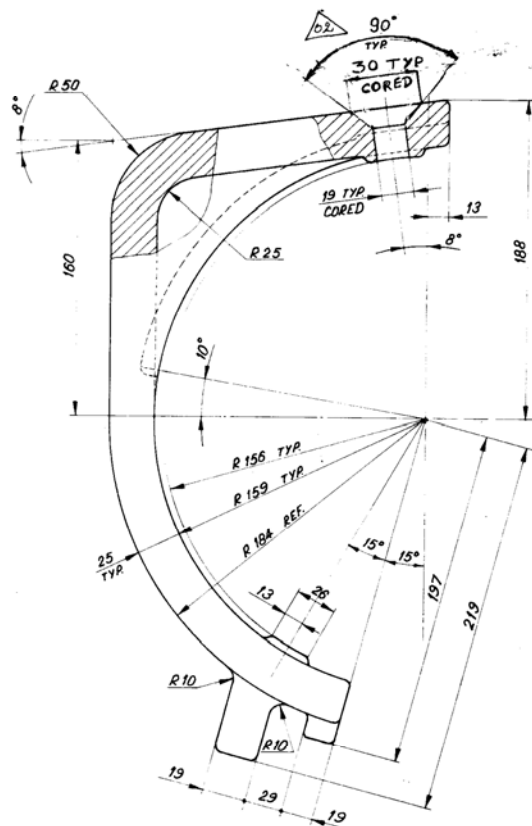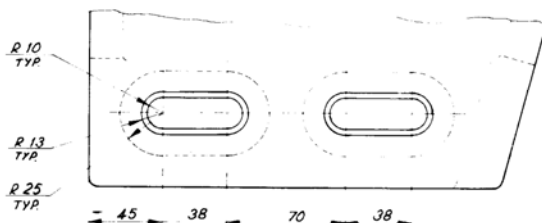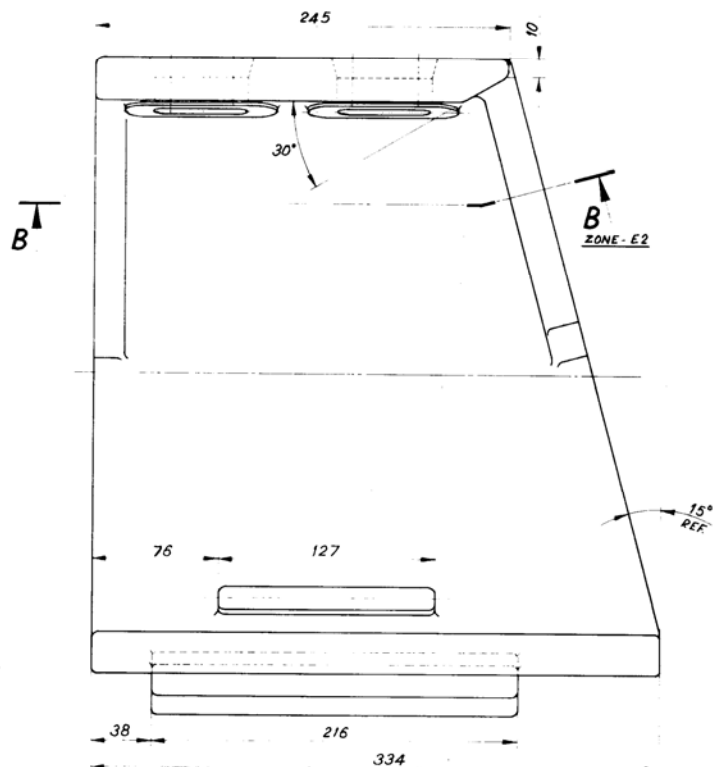

## SECTION - BB

ZONE - E6

## NOTES :-

1. UNLESS OTHERWISE NOTED,

(A) ALL INSIDE CORNER FILLETS TO BE R 6.

(B) ALL OUTSIDE CORNER RADII TO BE R 3.

2. CORED HOLES ARE TO BE CLEANED AND FREE FROM FIN, SAND ETC  
 3. DIMENSIONS & LOCATIONS OF THE CAST CORED HOLES ARE TO BE ENSURED WITH A TEMPLATE

GENERAL DIMENSIONS, LIMITS & TOLERANCES AS PER PS. 8: 020229

ALLOY CASTING

BA9114133407  
AA19741

34.00

TYPE OF PRODUCT  
OR NAME OF  
CUSTOMER PROJECT

1003 XRP BOWL MILL



Bharat Heavy Electricals Ltd.,  
BOILER PLANT UNIT  
TIRUCHIRAPALLI-620 014

DATE 18.12.89  
BY S. SELVARAJU  
CHKD R. SHANMUGAM  
APPD. [Signature]

APPD. [Signature]  
DATE 18-12-89  
CORED HOLE TAPER  
ANGLE WAS 30°  
DIM 30 WAS 25  
B-1  
C-3  
AA19741 WAS COMB ALLOY  
NOTES 2 & 3 ADDED

DEPT. POLY. ENGRG. CODE 363  
GRADE OF MATERIAL C  
N.T.S.  
34.00  
C. 101-00966/01  
2-61-000-00409  
JOURNAL HEAD LINER  
2-61-000-00409


THE INFORMATION ON THIS DOCUMENT IS THE PROPERTY OF BHARAT HEAVY ELECTRICALS LIMITED. IT MUST NOT BE USED DIRECTLY OR INDIRECTLY IN ANY WAY DETRIMENTAL TO THE INTEREST OF THE COMPANY.

COMP. FILE NAME: 26100747.DWG REF.DRG.NO. INVENTORY NO.


FIRST ANGLE PROJECTION

(ALL DIMENSIONS ARE IN mm)

DRG.NO. 2-61-000-00747

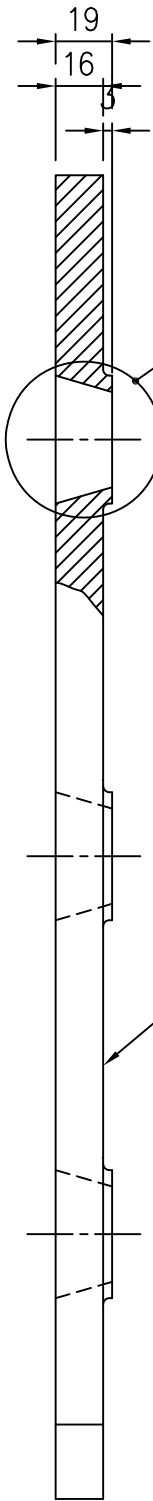

CAST PART NO.  
ON THIS SURFACE  
PER NOTE NO.1

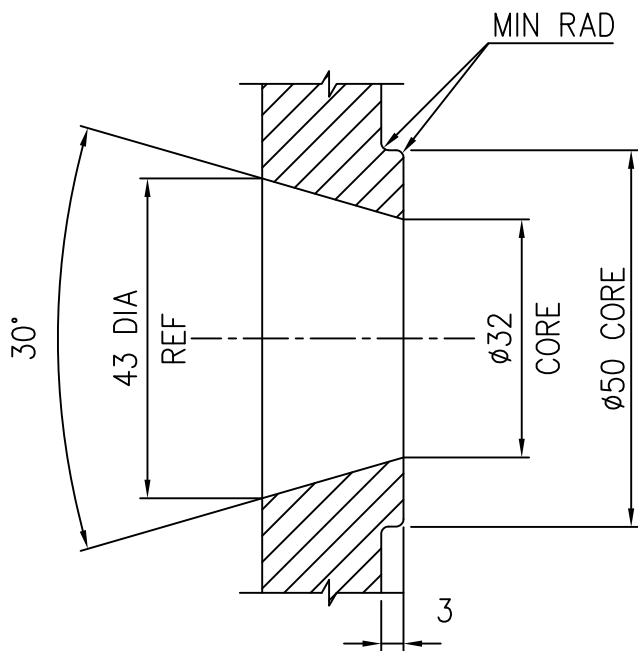

DETAIL - A  
(TYP - 4 PLACES)


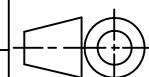
NOTES:

- FOLLOWING INFO TO BE CAST INTO PART USING 10 MIN. LETTER SIZE.  
"2-61-000-00747".
- CORED HOLES ARE TO BE CLEANED AND FREE FROM FINS, SAND ETC
- DIMENSIONS AND LOCATIONS OF CORED HOLES ARE TO BE ENSURED  
WITH A TEMPLATE.

ITEM NO	DESCRIPTION	DRAWING NO.	VAR. NO.	RAW MATERIAL SIZE OR CASTING DRG.NO. OR FORGING DRG.NO.	MATERIAL CODE	NET WT.	GROSS WT.
					MATERIAL SPECN.	QUANTITY	

THE FOLLOWING CONDITIONS APPLY  
EXCEPT OTHERWISE STATED...



- REF.TO HY0230261 FOR UNSPECIFIED TOLERANCES.
- CHAMFER M/CD SHARP EDGES  
1.2 TO 1.0 AT 45°.
- INTERNAL M/CD CORNER RADII  
1 TO 0.7.
- THE SURFACE ROUGHNESS WHEREVER NOT SHOWN  
SHALL BE TAKEN FROM THE SURFACE ROUGHNESS  
SHOWN OUT SIDE BACK SLASHES GIVEN AT THE  
TOP MOST RIGHT CORNER OF THE DRG.

TYPE OF PRODUCT OR NAME OF CUSTOMER/PROJECT					1003 XRP BOWL MILL				
<div></div> <div>BHARAT HEAVY ELECTRICALS LTD. HYDERABAD</div>						NAME	SIGN.	DATE	NO.OF VAR.
					DRN.	N.D.S	<i>Wag</i>	15.4.99.	
					CHD.	S.G	<i>LG</i>	15.4.99	
					APPD.	K.M.RAO	<i>KG</i>	15.4.99	
DEPT. PULV ENGG			SCALE	WEIGHT(Kg)	REF. TO ASSY DRG.		ITEM NO.	NO.OF ITEMS	
CODE 446			NTS	20.00	NA		NA	NA	
TITLE JOURNAL HEAD LINER					DRAWING NO. 2-61-000-00747			REV. 04	
					SHEET NO.		NO OF SHEETS		



INVENTORY NO.	REF.DRG.NO.	COMP. FILE NAME
		26100748.DWG

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SECTION A-A

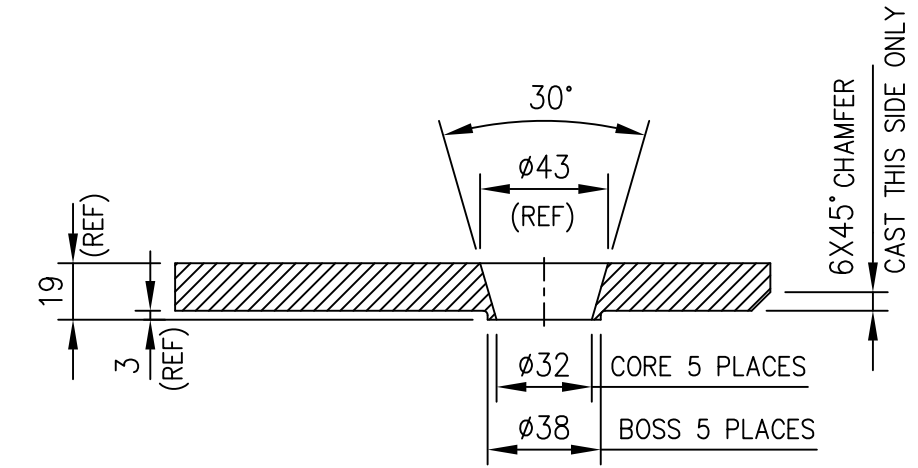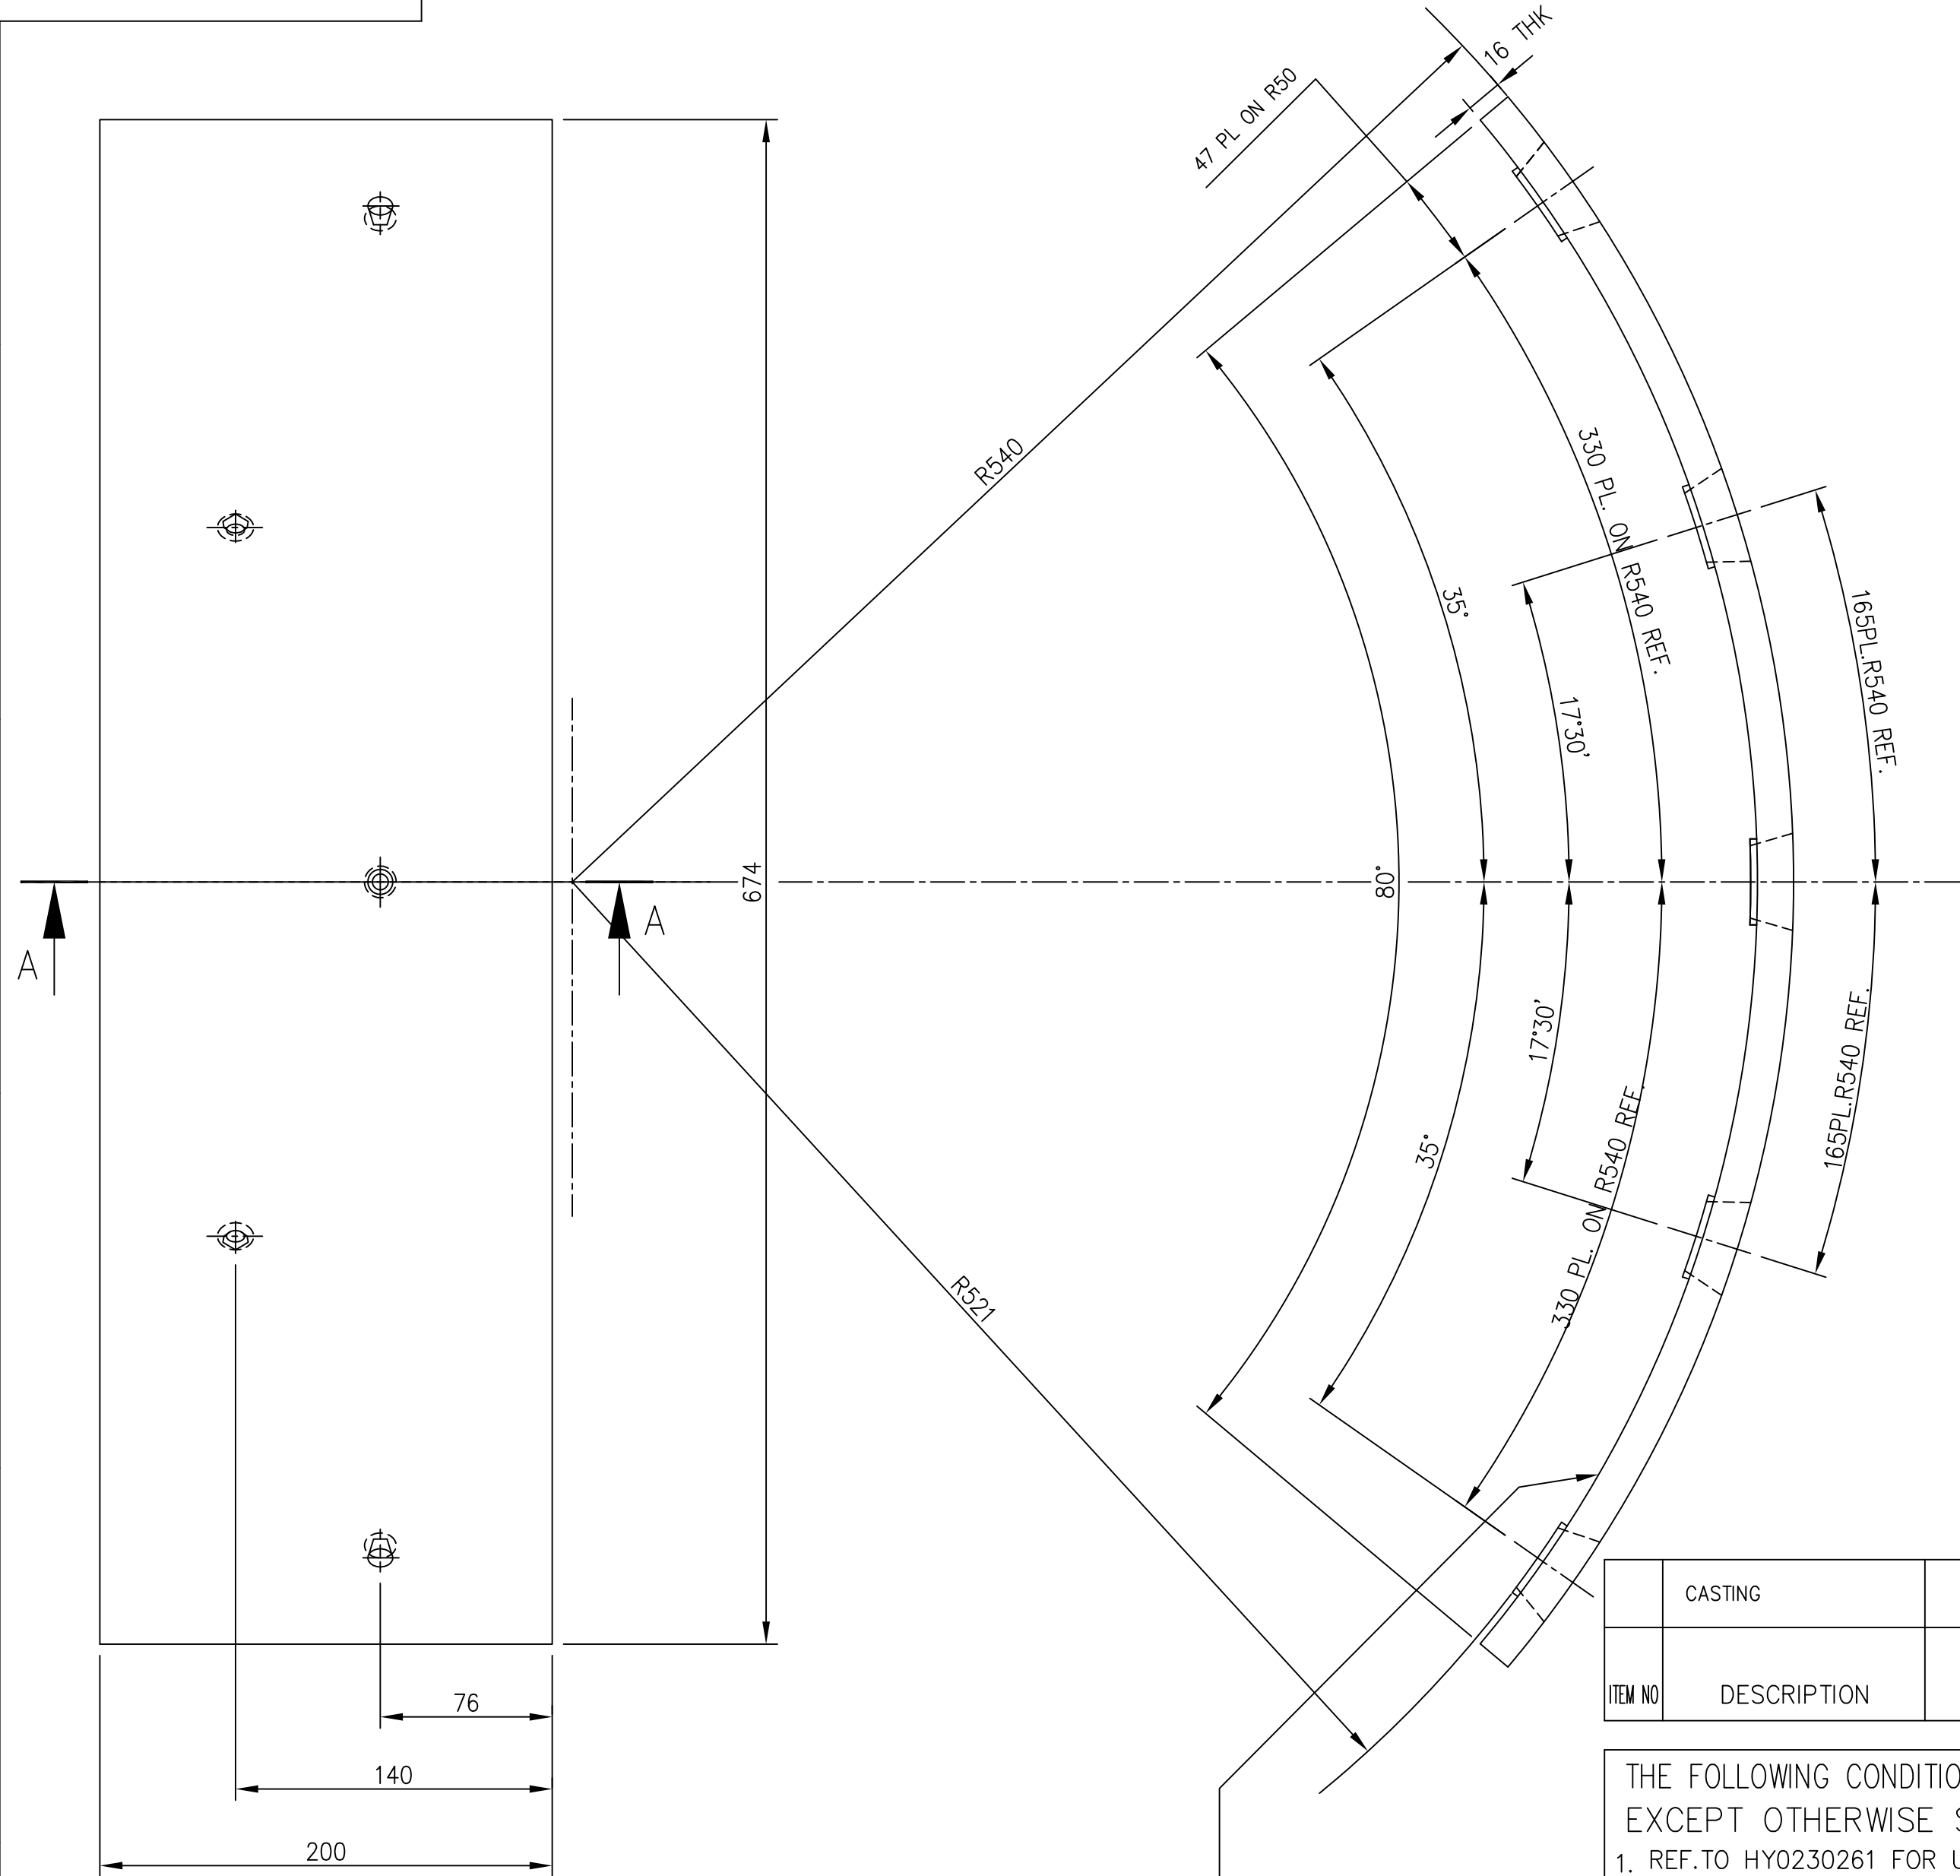


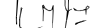
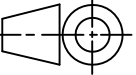
NOTES:

1. FOLLOWING INFO TO BE CAST INTO PART USING 10 MIN. LETTER SIZE.  
"2-61-000-00748".
2. CORED HOLES ARE TO BE CLEANED AND FREE FROM FINS, SAND ETC
3. DIMENSIONS AND LOCATIONS OF THE CORED HOLES ARE TO BE ENSURED  
WITH A TEMPLATE.

	CASTING				BA9114134217	18.620	
					AA19741		
ITEM NO	DESCRIPTION	DRAWING NO.	VAR. NO.	RAW MATERIAL SIZE OR CASTING DRG.NO. OR FORGING DRG.NO.	MATERIAL CODE	NET WT.	GROSS WT.
					MATERIAL SPECN.	QUANTITY	

THE FOLLOWING CONDITIONS APPLY  
EXCEPT OTHERWISE STATED...

1. REF.TO HY0230261 FOR UNSPECIFIED TOLERANCES.
2. CHAMFER M/CD SHARP EDGES 1.2 TO 1.0 AT 45°.
3. INTERNAL M/CD CORNER RADII 1 TO 0.7.
4. THE SURFACE ROUGHNESS WHEREVER NOT SHOWN SHALL BE TAKEN FROM THE SURFACE ROUGHNESS SHOWN OUT SIDE BACK SLASHES GIVEN AT THE TOP MOST RIGHT CORNER OF THE DRG.

TYPE OF PRODUCT OR NAME OF CUSTOMER/PROJECT				1003 XRP BOWL MILL				
	BHARAT HEAVY ELECTRICALS LTD. HYDERABAD				NAME	SIGN.	DATE	NO.OF VAR.
				DRN.	N.D.S		15.4.99	
				CHD.	S.G		15.4.99	
				APPD.	K.M.RAO		15.4.99	
DEPT. PULV. ENGG.		SCALE 1:2.5	WEIGHT(Kg) 18.62	REF. TO ASSY DRG. C-101-01445/0 CE PART NO 101-01445			ITEM NO.	NO.OF ITEMS
CODE 446								
TITLE JOURNAL HEAD LINER				DRAWING NO. 2-61-000-00748				REV. 03
				SHEET NO. 1		NO OF SHEETS 1		

COMP. FILE NAME: 26100749.DWG | THE INFORMATION ON THIS DOCUMENT IS THE PROPERTY OF BHARAT HEAVY ELECTRICALS LIMITED. IT MUST NOT BE USED DIRECTLY OR INDIRECTLY IN ANY WAY DETRIMENTAL TO THE INTEREST OF THE COMPANY.

REF.DRG.NO. INVENTORY NO.

FIRST ANGLE PROJECTION

(ALL DIMENSIONS ARE IN mm)

DRG.NO. 2-61-000-00749

2

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4


5

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WP



TOLERANCES UNLESS OTHERWISE NOTED.

CASTING ±1.6

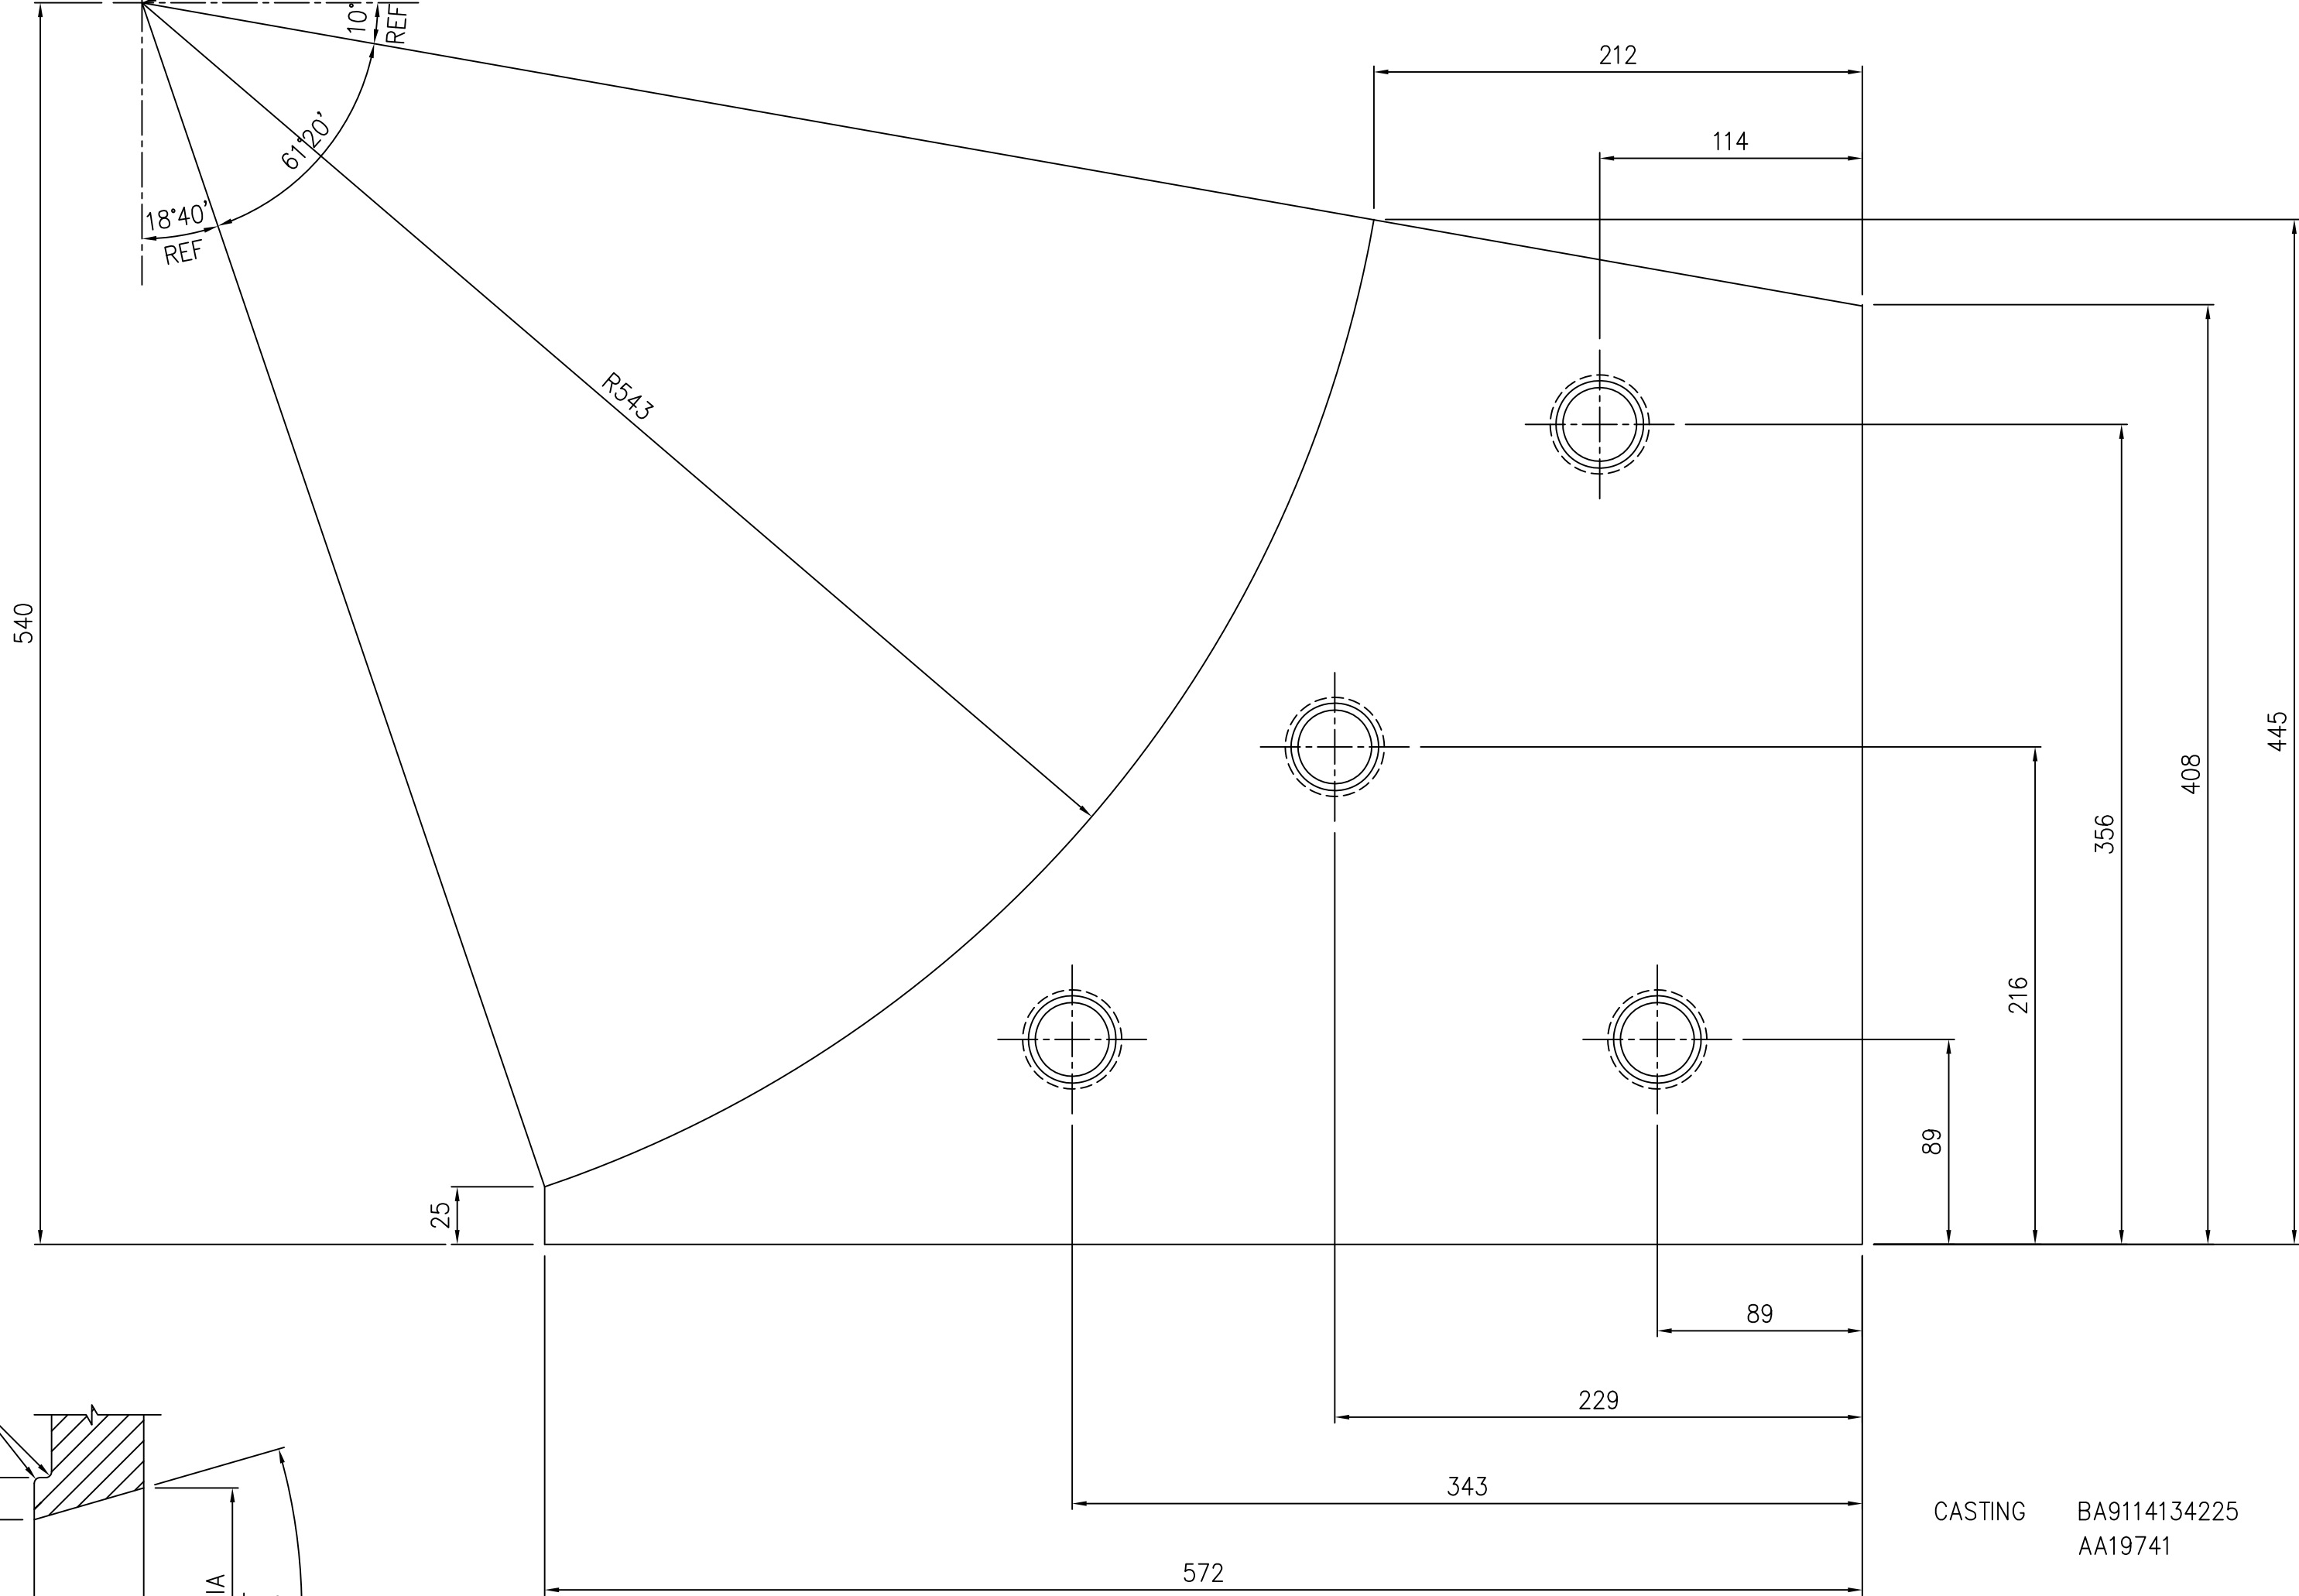ANGULAR ± 1/10°

FRACTIONAL ± 0.7

BREAK ALL SHARP EDGES AND CORNERS UNLESS OTHERWISE NOTED.

CASTING BA9114134225  
AA19741


NOTES :-

- FOLLOWING INFO TO BE CAST INTO PART USING 10 MIN. LETTER HEIGHT "2-61-000-00749."
- CORED HOLES ARE TO BE CLEANED AND FREE FROM FINS, SAND ETC.
- DIMENSIONS AND LOCATIONS OF THE CORED HOLES ARE TO BE ENSURED WITH A TEMPLATE.

ITEM NO	DESCRIPTION	DRAWING NO.	VAR. NO.	RAW MATERIAL SIZE OR CASTING DRG.NO. OR FORGING DRG.NO.	MATERIAL CODE	NET WT.	GROSS WT.
					MATERIAL SPECN.	QUANTITY	



THE FOLLOWING CONDITIONS APPLY EXCEPT OTHERWISE STATED...

- REF.TO HY0230261 FOR UNSPECIFIED TOLERANCES.
- CHAMFER M/CD SHARP EDGES 1.2 TO 1.0 AT 45°.
- INTERNAL M/CD CORNER RADII 1 TO 0.7.
- THE SURFACE ROUGHNESS WHEREVER NOT SHOWN SHALL BE TAKEN FROM THE SURFACE ROUGHNESS SHOWN OUT SIDE BACK SLASHES GIVEN AT THE TOP MOST RIGHT CORNER OF THE DRG.

TYPE OF PRODUCT OR NAME OF CUSTOMER/PROJECT		1003 X RP BOWL MILL						
 BHARAT HEAVY ELECTRICALS LTD. HYDERABAD		DRN.	N.D.S	SIGN.	DATE	NO.OF VAR.		
		CHD.	S.G		24.12.86			
		APPD.	K.M.R		24.12.86			
DEPT.	PULV.ENGG	SCALE	1:2.5	WEIGHT(Kg)	20.00	REF. TO ASSY DRG. C-101-01443/0 CE PART NO.101-01443	ITEM NO.	NO.OF ITEMS
CODE	446	TITLE		JOURNAL HEAD LINER		DRAWING NO. 2-61-000-00749		REV. 04
		SHEET NO. 1		NO OF SHEETS 1				

REV.	DATE	ALTERED	REV.	DATE	ALTERED	REV.	DATE	ALTERED	REV.	DATE	ALTERED	T.A.V.M.
04	18.8.02	CHECKED <i>ld</i> APPD. <i>vsj</i>	03	-	CHECKED <i>ld</i> APPD. <i>vsj</i>	02	18.1.93	CHECKED <i>ld</i> APPD. <i>vsj</i>	01	3.7.87	CHECKED <i>ld</i> APPD. <i>vsj</i>	
ZONE	BOSS DIM. ø50 WAS ø38.		ZONE	DRAWING REDRAWN		ZONE	C.E.MATERIAL SPECIFICATION DELETED, NOTES 2 & 3 ADDED.		ZONE	THE CORED WELD PLUG HOLE CHANGED TO SUIT 1" PLUG.		

SH. 01 OF 01	DRG. NO. 2-61-004-02258
2	

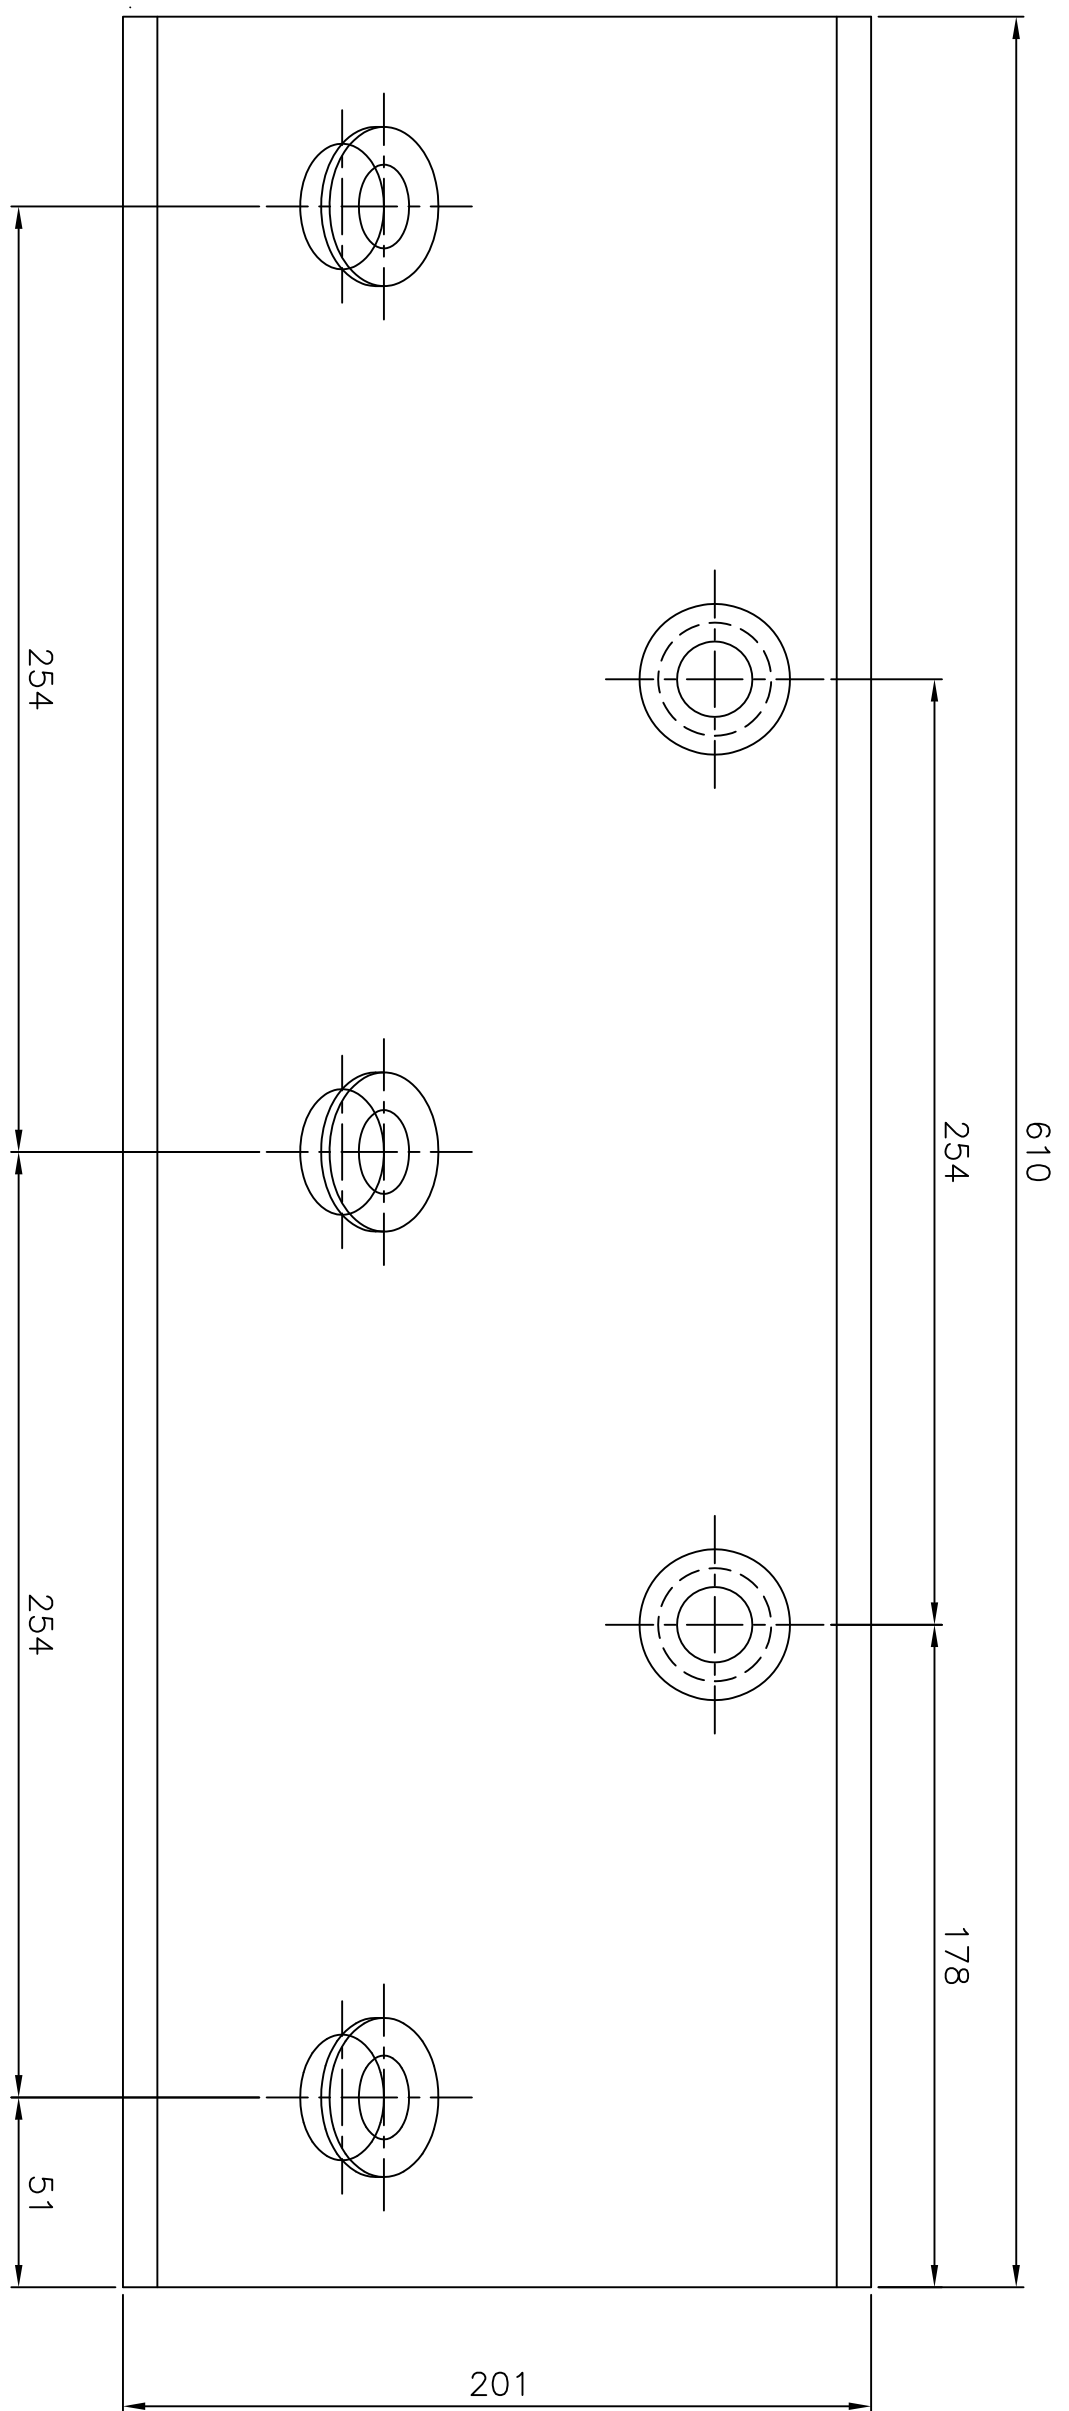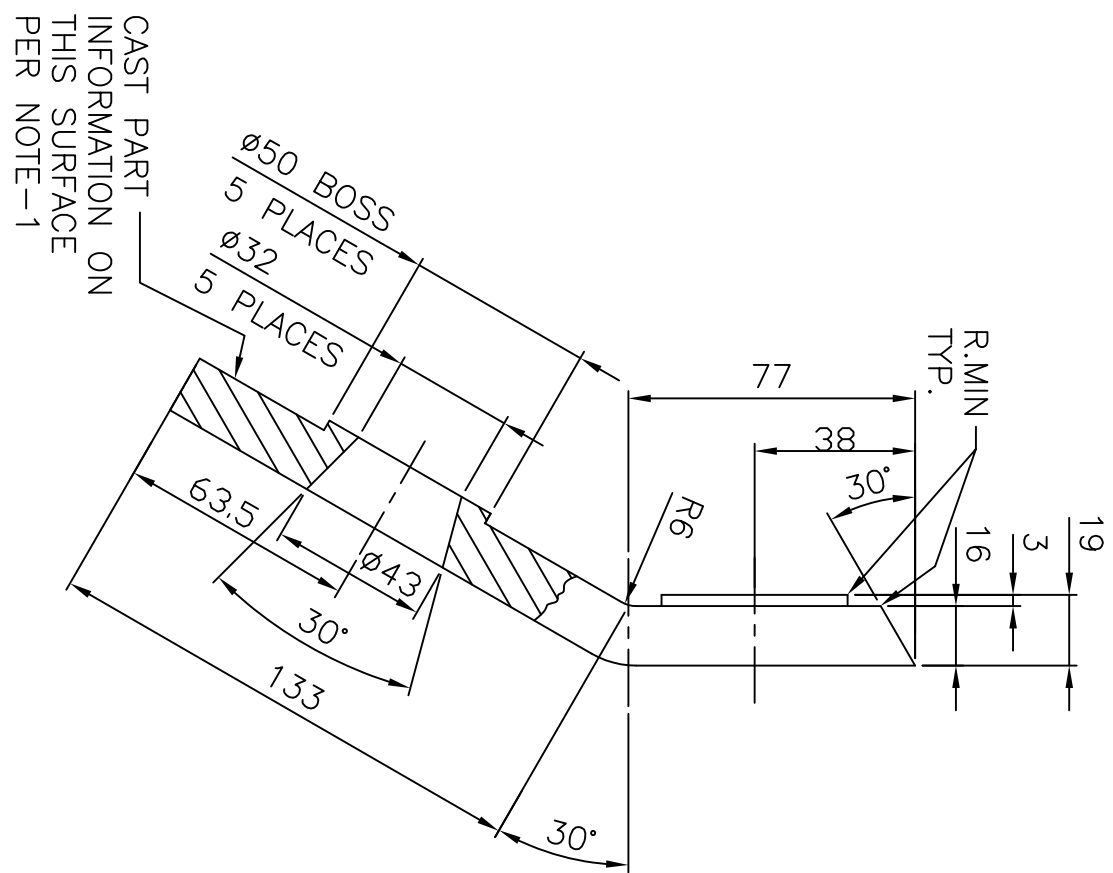

CAST PART \_\_\_\_\_  
INFORMATION ON  
THIS SURFACE  
PER NOTE-1

NOTES:—


01. FOLLOWING INFORMATION TO BE CAST INTO PART  
USING 3mm MAX. HEIGHT LETTERS. 26100402258


02. TOLERANCES UNLESS OTHERWISE NOTED.

CASTING  $\pm 1.6$ ANGULAR  $\pm 0.1^\circ$ 

01	CASTING			RAW MATERIAL SIZE OR CASTING DRG. NO. OR FORGING DRG. NO.	BA9114135485	16.200	
					AA19741	1	
ITEM NO.	DESCRIPTION	DRAWING NO.	VAR. NO.		MATERIAL CODE	NET WT.	GROSS WT.
					MATERIAL SPECN.	QUANTITY	

THE FOLLOWING CONDITIONS APPLY  
EXCEPT OTHERWISE STATED.

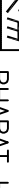 <b>BHARAT HEAVY ELECTRICALS LIMITED</b> <b>HYDERABAD</b>	DRN.	NAME	SIGN.	DATE	NO.OF VAR.
	CHD.	UNIC			
	APPD.	E.M.ASHOK			
		K.M.RAO			/

3.	INTERNAL W./CO. CORNER RADI	1 TO 0.7						
4.	THE SURFACE ROUGHNESS WHERE-EVER NOT SHOWN SHALL BE TAKEN FROM THE SURFACE ROUGHNESS SHOWN OUT SIDE THE BACK SLASH GIVEN ON THE TOP MOST RIGHT CORNER OF THE DRG.							
TITLE		DEPT. PLANT ENGR.	UNTL. DIMS. GR.	SCALE	WEIGHT (KG)	REF. TO ASSY DRG.	ITEM NO.	NO.OF ITEMS
JOURNAL HEAD LINER		CAGE CODE 446		1:2	16.200	1-61-004-01189	05	07
DRAWING NO.		CARD CODE						REV.
2-61-004-02258								01
SHEET NO.		01	NO OF SHEETS		01			





FIRST ANGLE PROJECTION




(ALL DIMENSIONS ARE IN mm)

DRG. NO. 2-61-004-02265

INVENTORY NO. SIGN. AND DATE REF. DRG. NO. COMPUTER FILE NAME 26102265.DWG THE INFORMATION ON THIS DOCUMENT IS THE PROPERTY OF BHARAT HEAVY ELECTRICALS LIMITED. IT MUST NOT BE USED DIRECTLY OR INDIRECTLY IN ANY WAY DETRIMENTAL TO THE INTEREST OF THE COMPANY

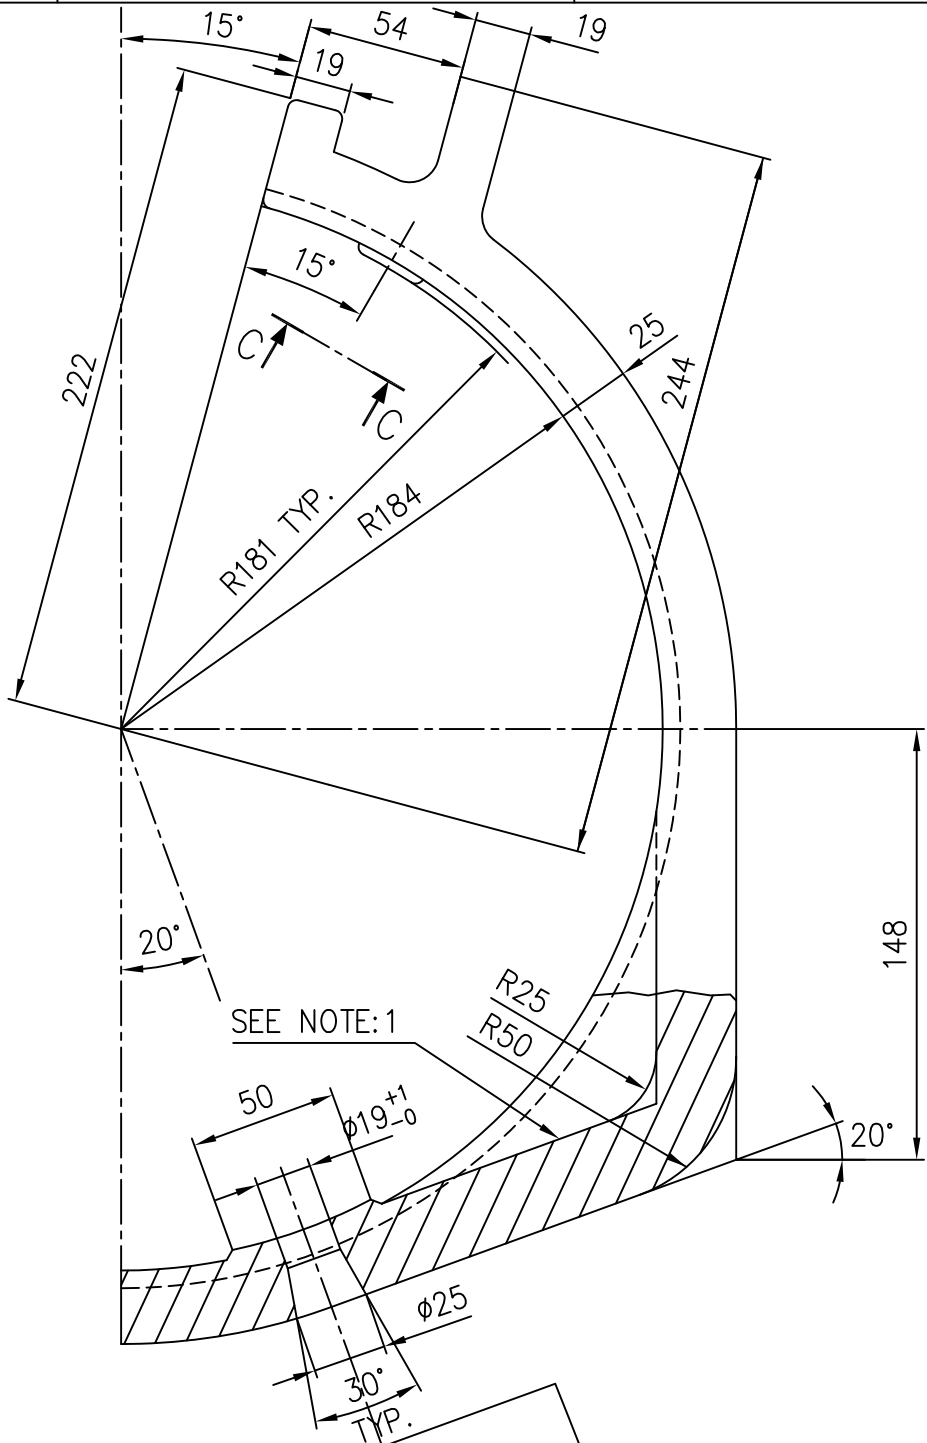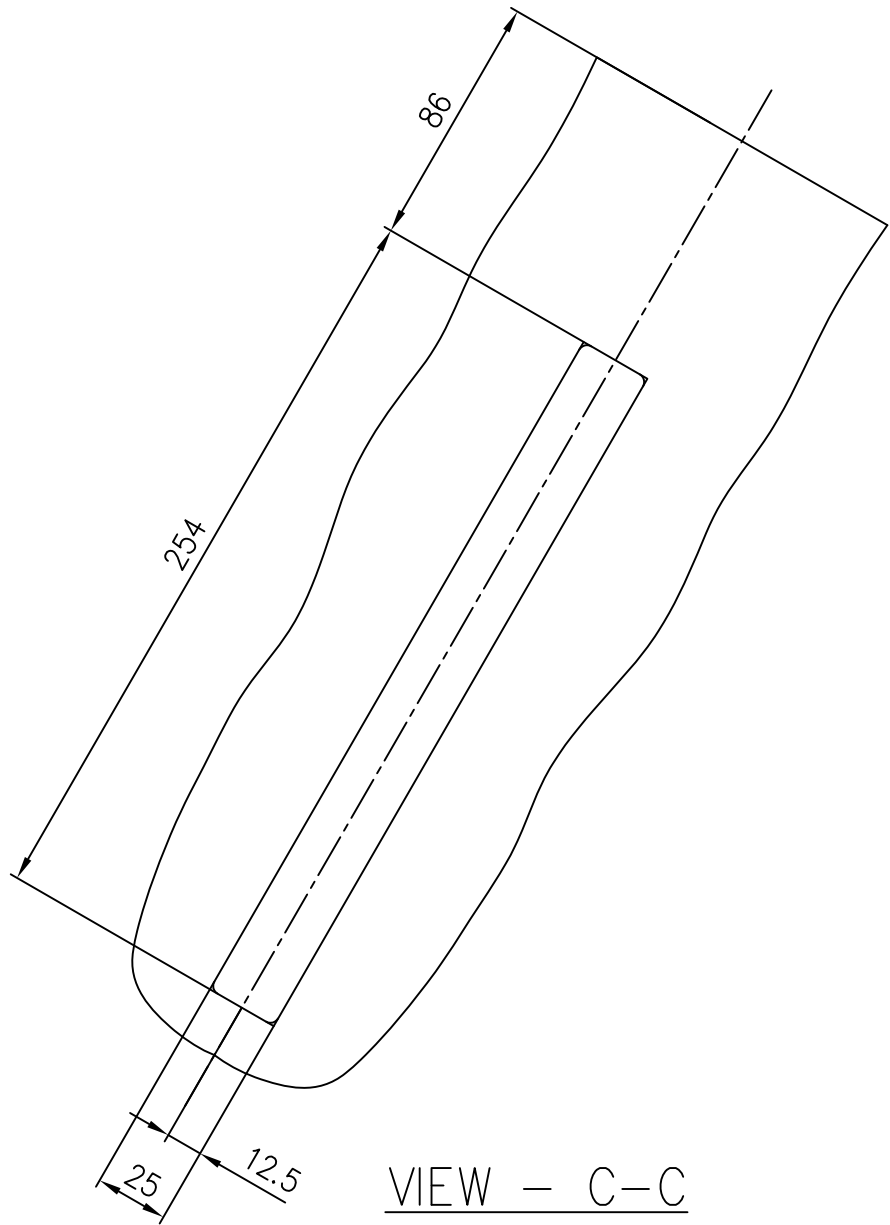

FULL RAD. TYP.

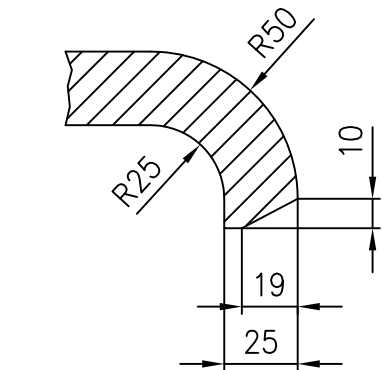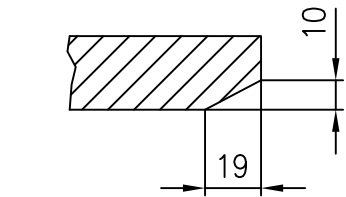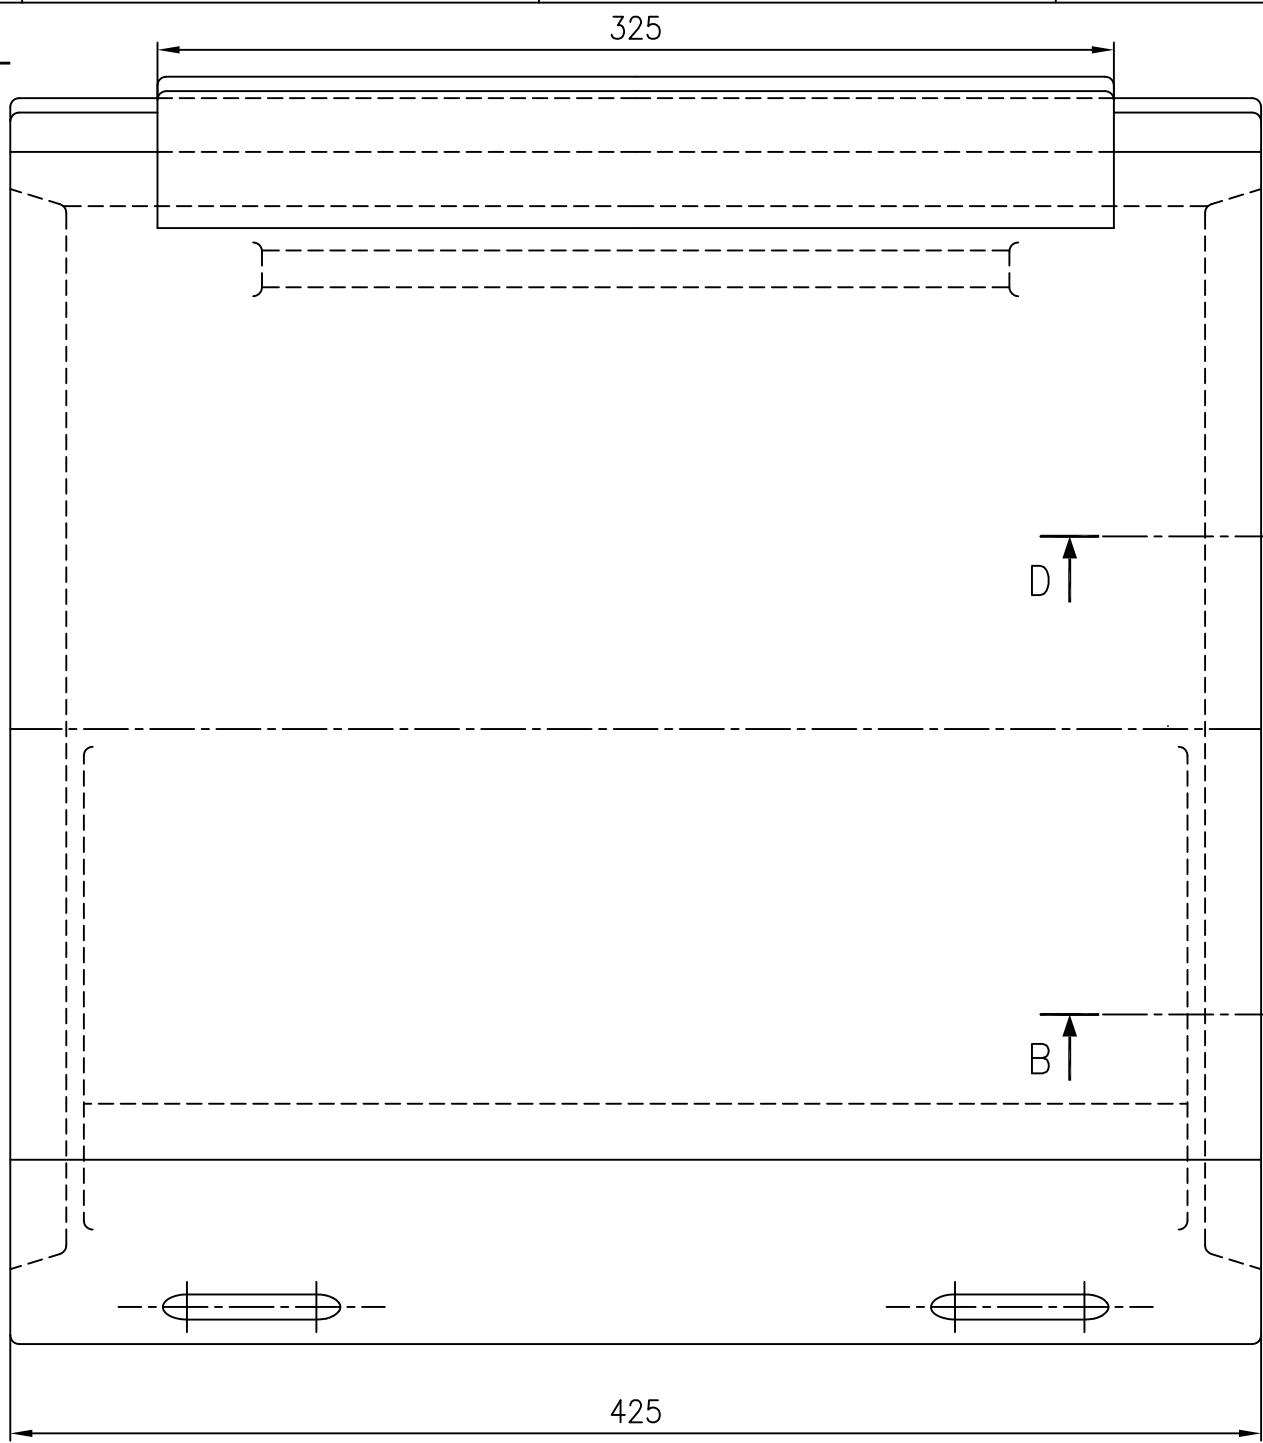

NOTES :-

- CAST PART NO. & PATT NO. USING 3 mm HEIGHT CHARACTERS.
- ALL FILLET RADII TO BE 3 mm UNLESS OTHERWISE SHOWN OR NOTED.
- BREAK ALL SHARP EDGES AND CORNERS UNLESS OTHERWISE NOTED.
- TOLERANCES UNLESS OTHERWISE NOTED.

CASTING  $\pm 1.6$

ANGULAR  $\pm 0.1^\circ$

01	CASTING				BA9114135477		49.000
					AA19741		1
ITEM NO.	DESCRIPTION	DRAWING NO.	VAR. NO.	RAW MATERIAL SIZE OR CASTING DRG. NO. OR FORGING DRG. NO.	MATERIAL CODE	NET WT.	GROSS WT.
					MATERIAL SPECN.	QUANTITY	

THE FOLLOWING CONDITIONS APPLY EXCEPT OTHERWISE STATED.

- REF. TO HY0230261 FOR UNSPECIFIED TOLERANCES.
- CHAMFER M/CD. SHARP EDGES 1.2 TO 1.0 AT 45°.
- INTERNAL M/CD. CORNER RADII 1 TO 0.7
- THE SURFACE ROUGHNESS WHERE-EVER NOT SHOWN SHALL BE TAKEN FROM THE SURFACE ROUGHNESS SHOWN OUT SIDE THE BACK SLASH GIVEN OR THE TOP MOST RIGHT CORNER OF THE DRG.

DRG. REDRAWN IN AUTOCAD.

TYPE OF PRODUCT 1043 RP BOWL MILL  
NAME OF CUSTOMER/PROJECT CHANDRAPUR 500 MW



BHARAT HEAVY ELECTRICALS LIMITED  
HYDERABAD

NAME	SIGN.	DATE	NO.OF VAR.
L.W.C.			
E.M.A.		-	
APPD.	K.M.RAO.		-

DEPT. PULV ENGG. CODE 446	UNTOL. DIMS. GR. $\phi$ /M/ $\phi$	SCALE 1:1	WEIGHT (KG) 49.000
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REF. TO ASSY DRG. 0-61-004-00571	ITEM NO. 26	NO.OF ITEMS 32
----------------------------------	-------------	----------------



TITLE JOURNAL HEAD LINER

DRAWING NO. 2-61-004-02265	REV. 00
SHEET NO. 01	NO OF SHEETS 01



89220-400-19-2 ON DRG 2 10 FO 10 HS


CAST PART INFORMATION ON THIS SURFACE PER NOTE-1

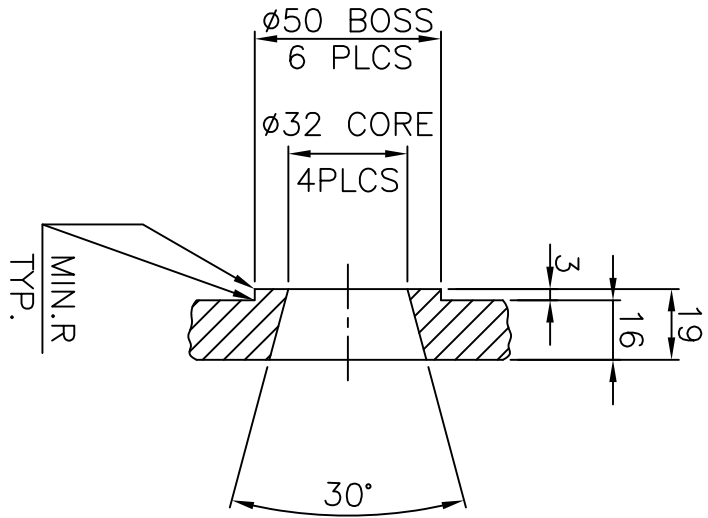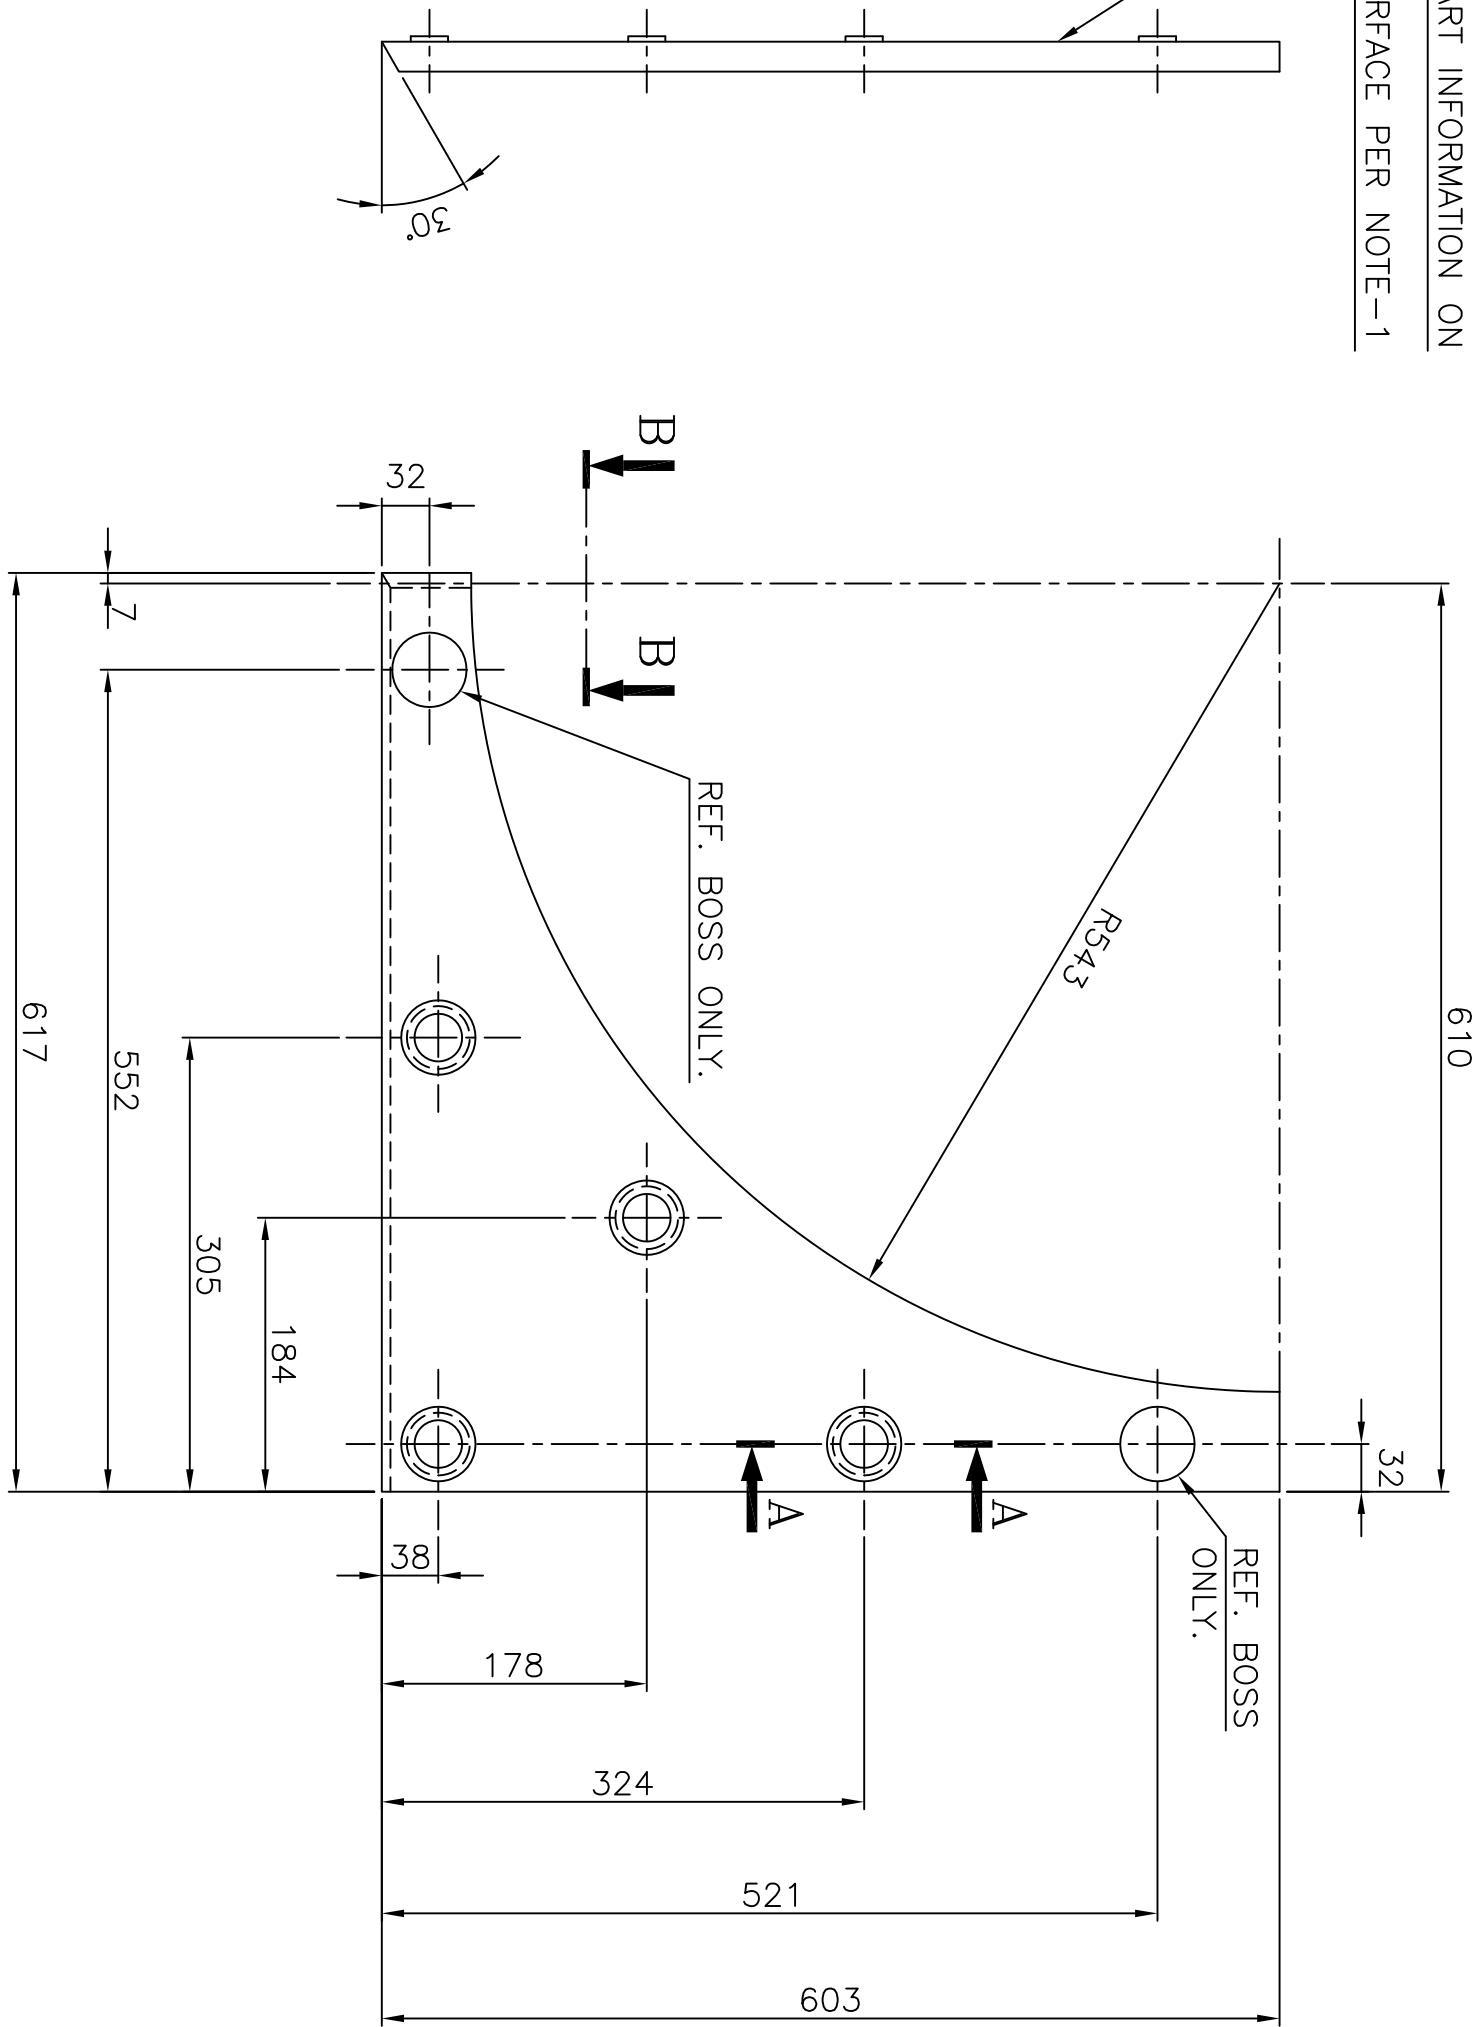

NOTES:-

1. FOLLOWING INFORMATION TO BE CAST INTO PART USING 3MM. MAX. LETTERS: 26100402268.
2. BREAK ALL SHARP EDGES AND CORNERS UNLESS OTHERWISE NOTED.
3. TOLERANCES UNLESS OTHERWISE NOTED:  
CASTING  $\pm 1.6$   
ANGULAR  $\pm 0.1^\circ$

SECTION-BB

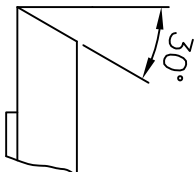

GENERAL DIMENSIONAL LIMITS,FITS & TOLERANCES AS PER HY0230261

INVENTORY NO		SIGN. AND DATE		REF. DRG. NO. 1-61-004-01189		COMPUTER FILE NAME 26102268.DWG		THE INFORMATION ON THIS DOCUMENT IS THE PROPERTY OF BHARAT HEAVY ELECTRICALS LIMITED. IT MUST NOT BE USED DIRECTLY OR INDIRECTLY IN ANY WAY DETRIMENTAL TO THE INTEREST OF THE COMPANY											
F		E		D		C		B		A									
1		2		3		4		5		6		7		8					
REV.		DATE		REV.		DATE		REV.		DATE		REV.		REV.					
ZONE		CHD.		ZONE		CHD.		ZONE		CHD.		ZONE		CHD.		ZONE			
1		2		3		4		5		6		7		8					
1		2		3		4		5		6		7		8					
1		2		3		4		5		6		7		8					
1		2		3		4		5		6		7		8					
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1		2		3		4		5		6		7		8					
1		2		3		4		5		6		7		8					
1		2		3		4		5		6		7		8					
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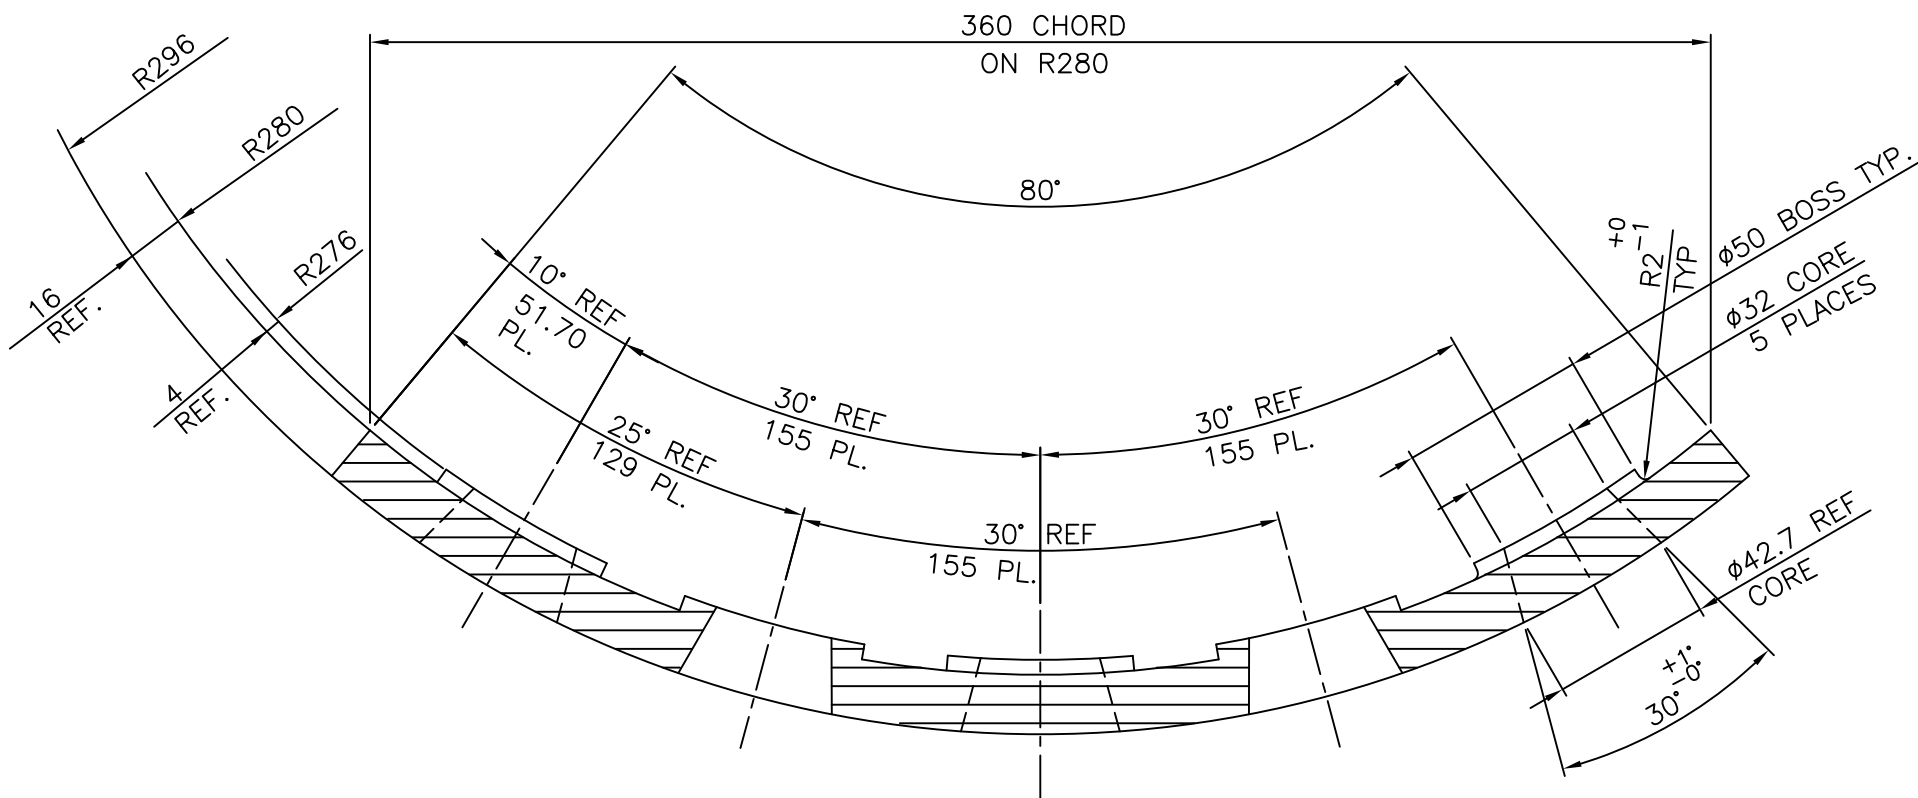
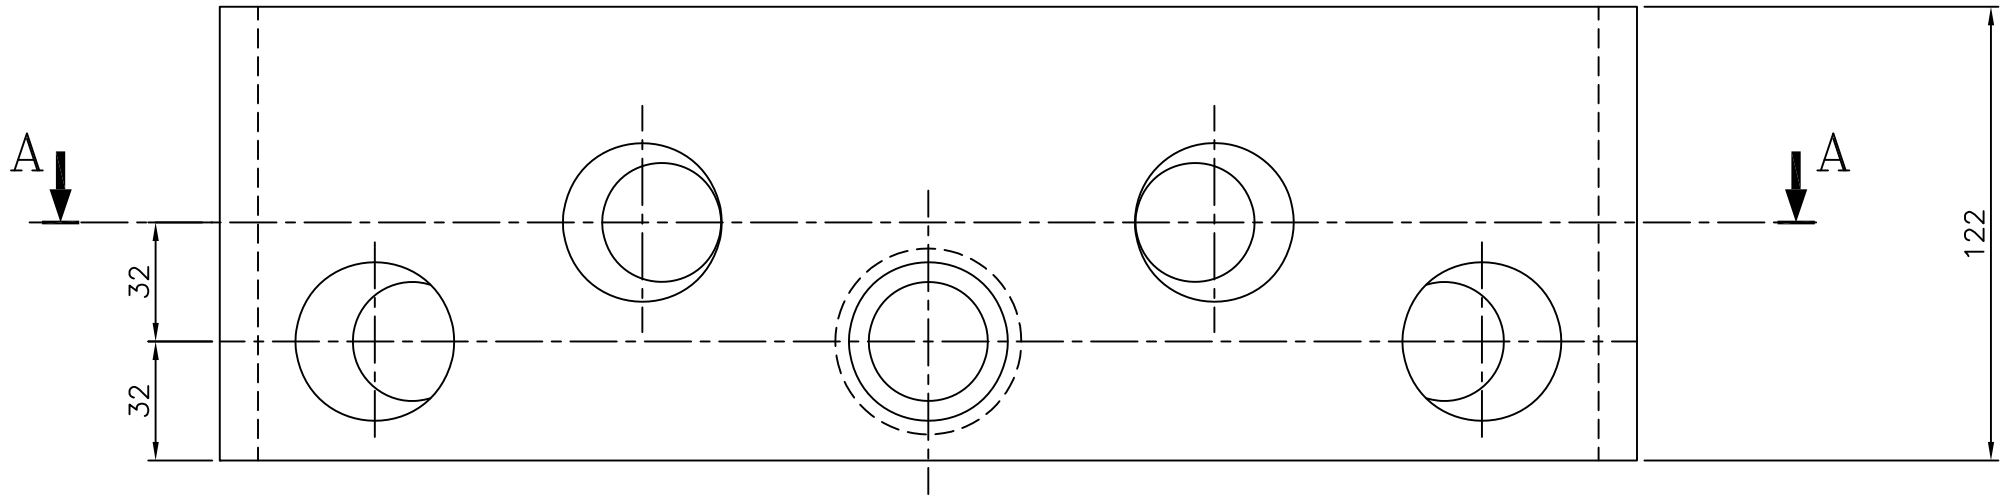
THE INFORMATION ON THIS DOCUMENT IS THE PROPERTY OF BHARAT HEAVY ELECTRICALS LIMITED. IT MUST NOT BE USED DIRECTLY OR INDIRECTLY IN ANY WAY DETRIMENTAL TO THE INTEREST OF THE COMPANY.

COMP. FILE NAME 26100420.DWG  
REF.DRG.NO.  
INVENTORY NO.

FIRST ANGLE PROJECTION

(ALL DIMENSIONS ARE IN mm) POORNIMA

DRG.NO. 2-61-080-00420




SECTION A-A

NOTE:

- 1. ALL PERIPHERAL LENGTHS ARE BASED ON R296
- 2. BREAK ALL SHARP EDGES AND CORNERS.
- 3. TOLERANCE, UNLESS OTHERWISE SPECIFIED.  
CASTING: ±1.5  
ANGULAR: ±0°6'

	CASTING				BA9114133750		5.20	
					AA19741			
ITEM NO	DESCRIPTION	DRAWING NO.	VAR. NO.	RAW MATERIAL SIZE OR CASTING DRG.NO. OR FORGING DRG.NO.	MATERIAL CODE		NET WT.	GROSS WT.
					MATERIAL SPECN.		QUANTITY	

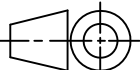THE FOLLOWING CONDITIONS APPLY EXCEPT OTHERWISE STATED...  1. REF.TO HY0230261 FOR UNSPECIFIED TOLERANCES.  2. CHAMFER M/CD SHARP EDGES 1.2 TO 1.0 AT 45°.  3. INTERNAL M/CD CORNER RADII 1 TO 0.7.  4. THE SURFACE ROUGHNESS WHEREVER NOT SHOWN SHALL BE TAKEN FROM THE SURFACE ROUGHNESS SHOWN OUT SIDE BACK SLASHES GIVEN AT THE TOP MOST RIGHT CORNER OF THE DRG.	TYPE OF PRODUCT OR NAME OF CUSTOMER/PROJECT									
	<div><div><div><div>श्रीहरी</div><div>BHEL</div></div><div>BHARAT HEAVY ELECTRICALS LTD. HYDERABAD</div></div></div>			NAME	SIGN.	DATE	NO.OF VAR.			
	DRN.	ASHOK		06.06.84	NA					
	CHD.	AMAN		02.08.84						
	APPD.	S.G		12.11.84						
	DEPT.	PULV-ENGG		SCALE	1:2	WEIGHT(Kg)	5.20	REF. TO ASSY DRG. 1-61-080-00180 (C-80-654-1)	ITEM NO. 02	NO.OF ITEMS
	CODE	4460								
	TITLE  JOURNAL HEAD LINER I							DRAWING NO.  2-61-080-00420		REV.  03
	SHEET NO. 01					NO OF SHEETS 01				

REV.	DATE	ALTERED		REV.	DATE	ALTERED		REV.	DATE	ALTERED		REV.	DATE	ALTERED	
		CHECKED	APPD.			CHECKED	APPD.			CHECKED	APPD.			CHECKED	APPD.
ZONE				ZONE				ZONE				ZONE			
1		2		3		4		5		6		7		8	




INVENTORY NO  
SIGN. AND DATE  
REF. DRG. NO.  
COMPUTER FILE NAME  
26102057dwg.

THE INFORMATION ON THIS DOCUMENT IS THE PROPERTY OF BHARAT HEAVY ELECTRICALS LIMITED. IT MUST NOT BE USED DIRECTLY OR INDIRECTLY IN ANY WAY DETRIMENTAL TO THE INTEREST OF THE COMPANY


FIRST ANGLE PROJECTION

(ALL DIMENSIONS ARE IN mm)


DRG. NO. 2-61-088-02057

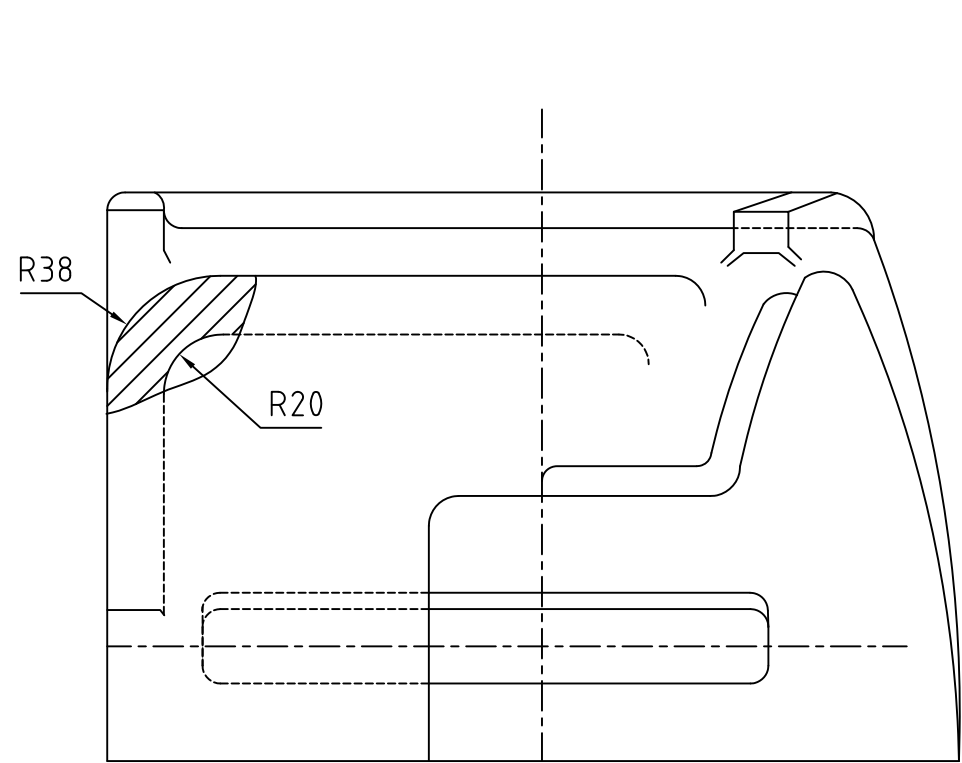


VIEW Q-Q

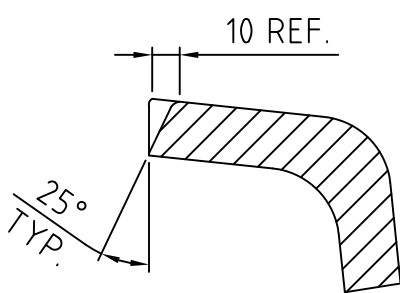


SECTION D-D

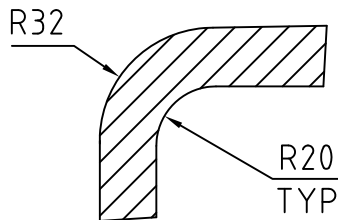


SECTION F-F

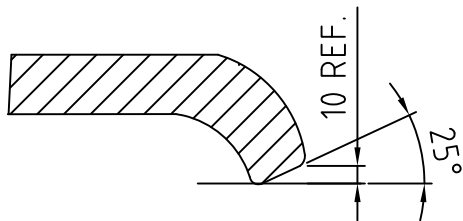


SECTION E-E

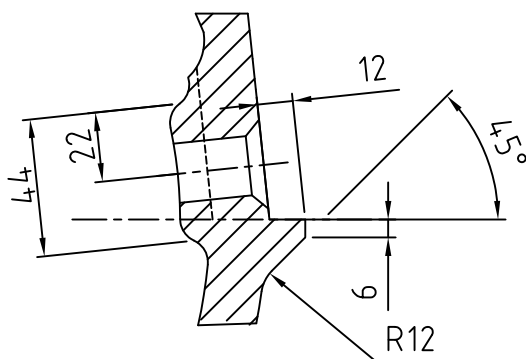


SECTION C-C

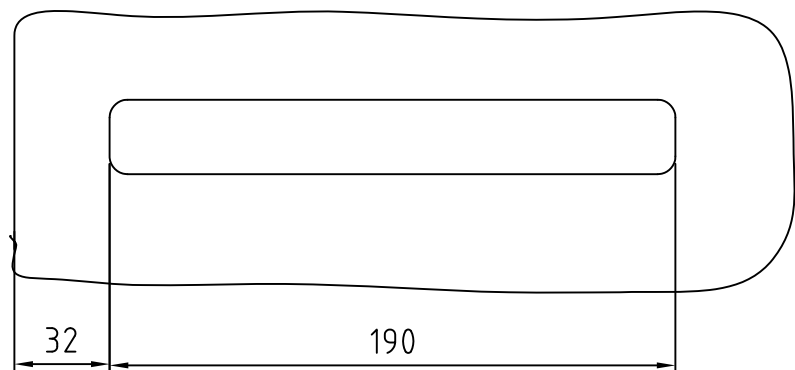


VIEW B-B

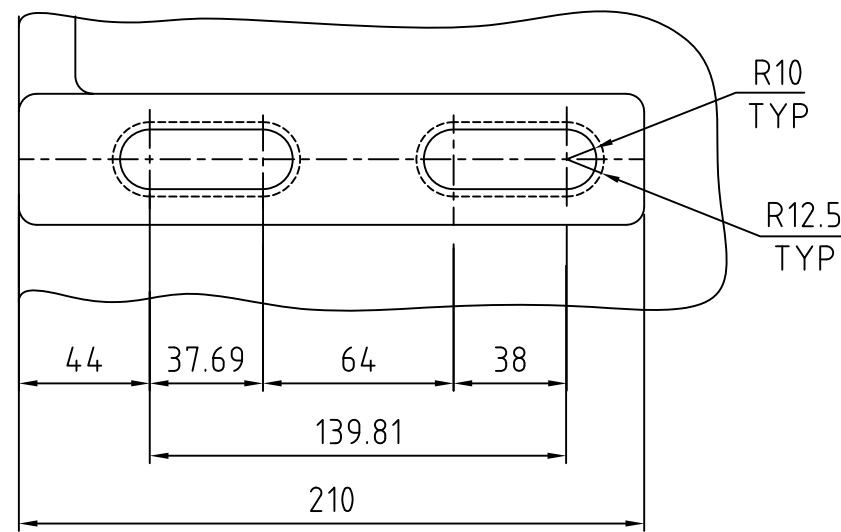


VIEW A-A

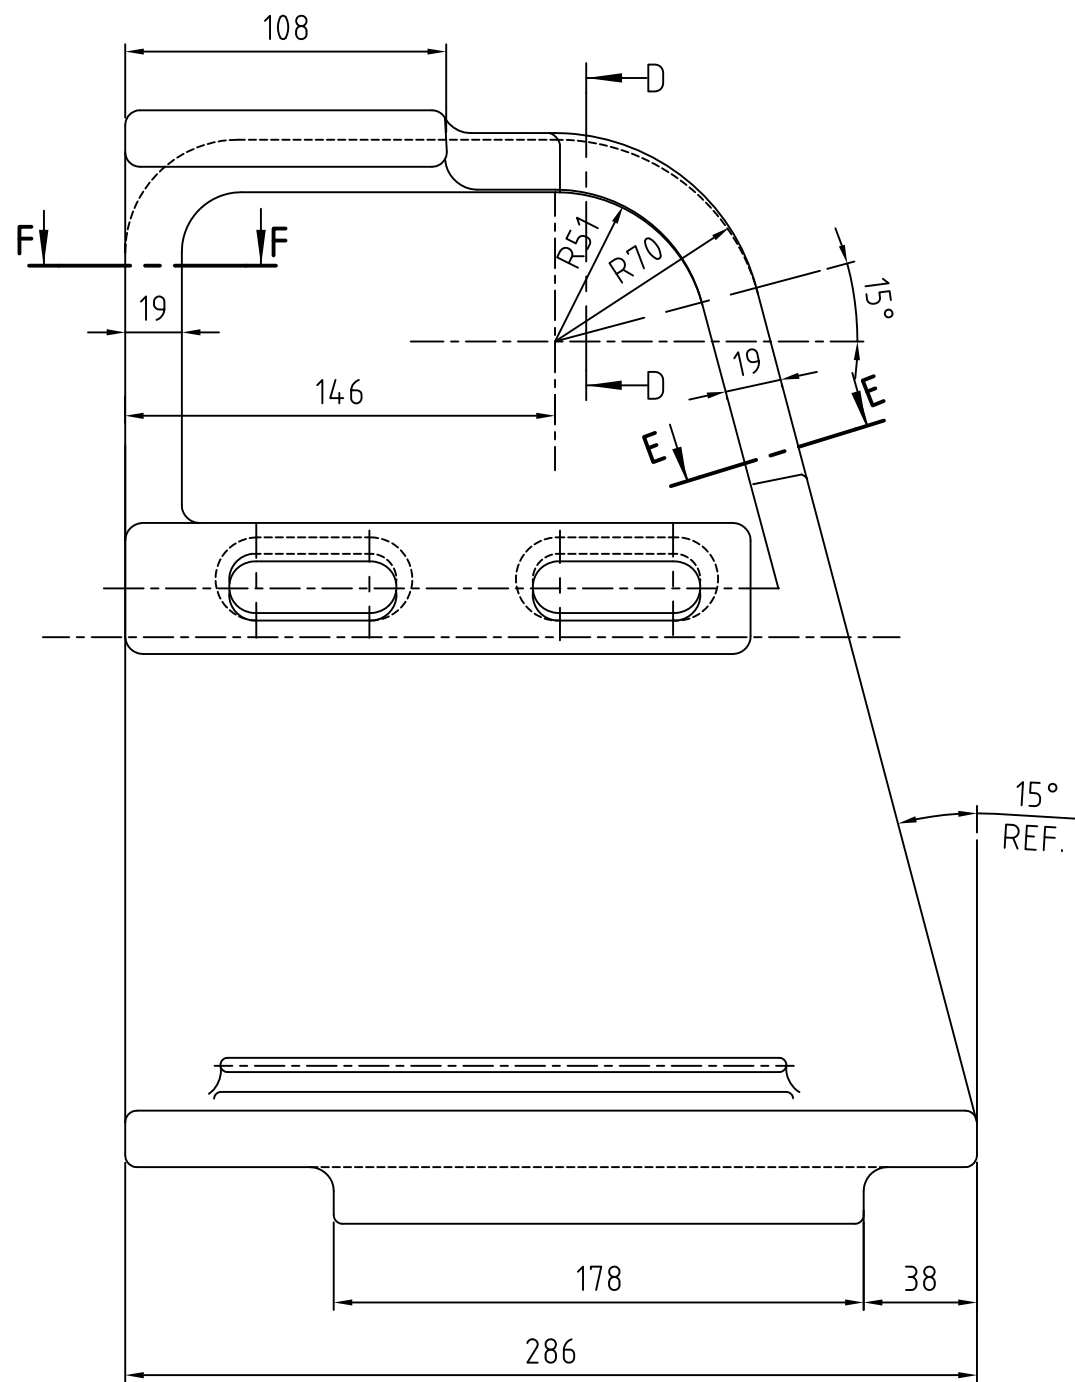

VIEW P-P

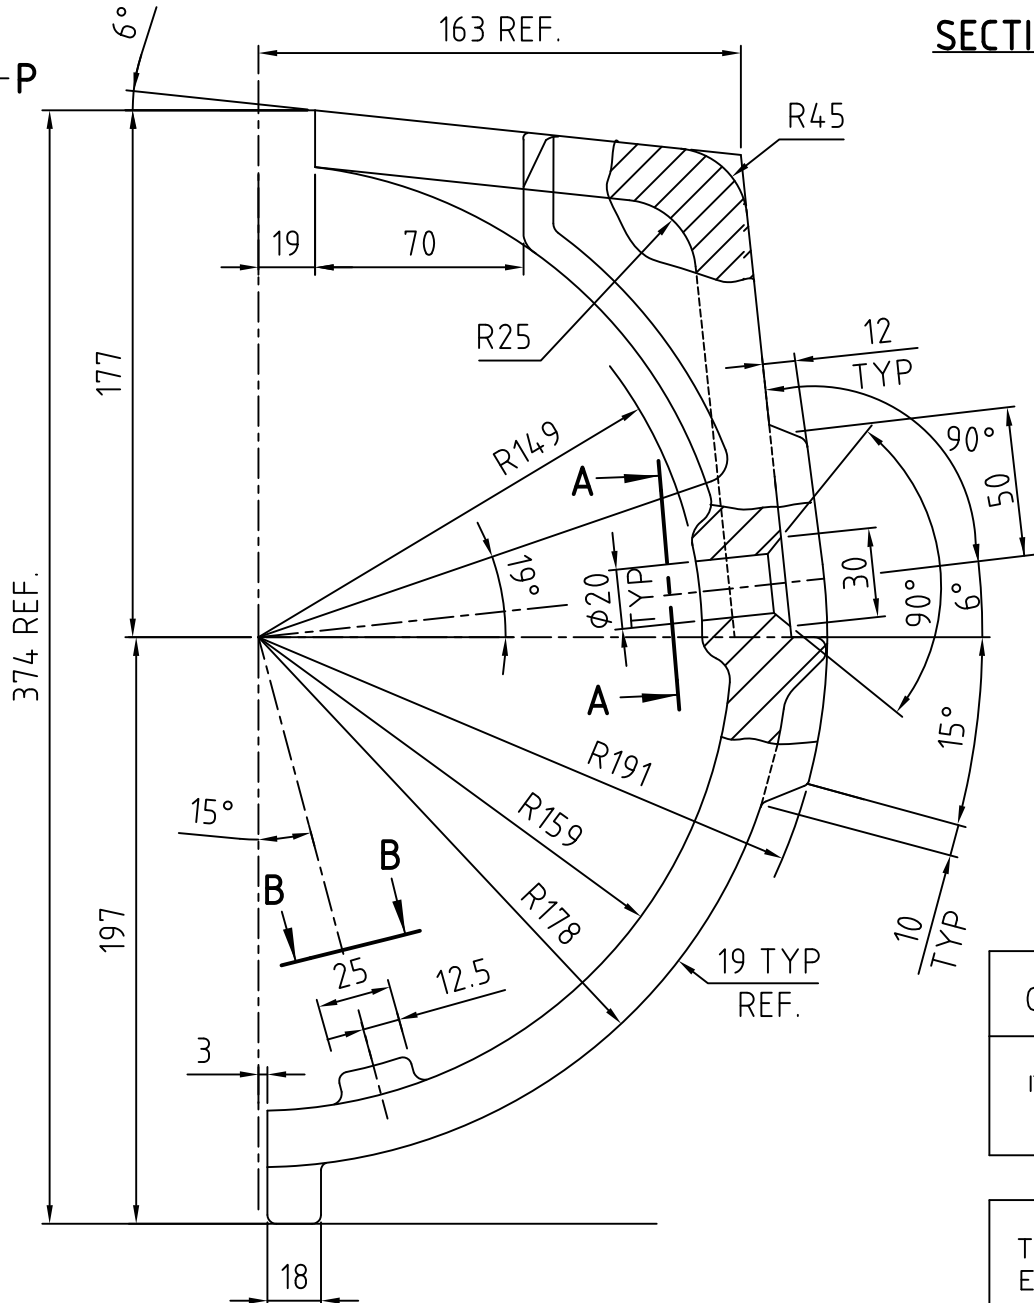

VIEW P-P

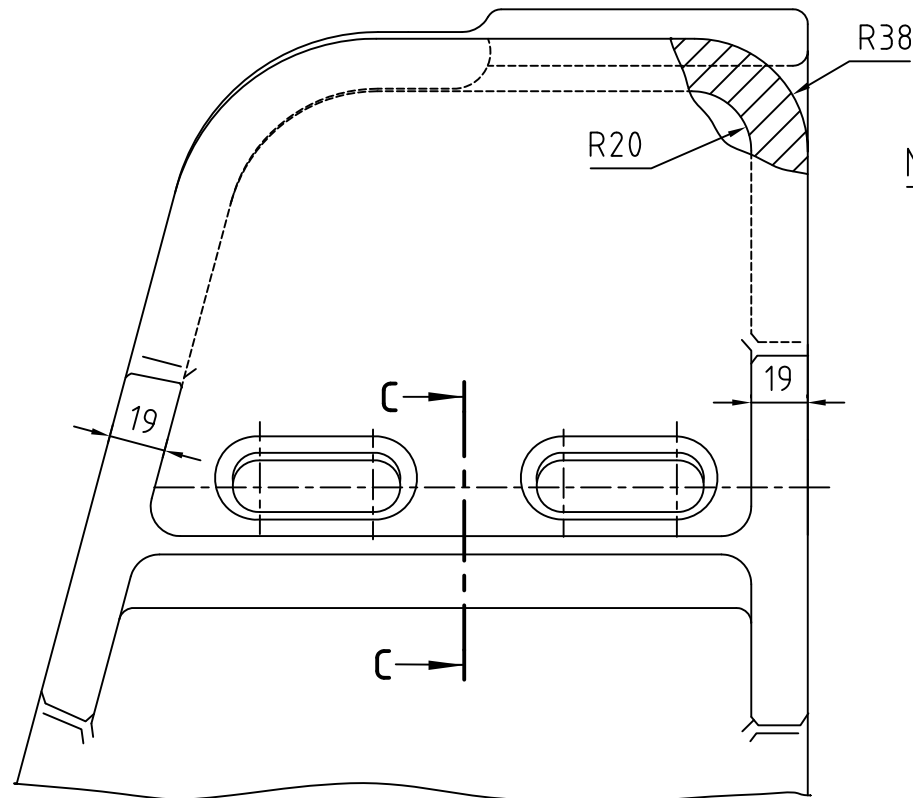

VIEW P-P

1.UNLESS OTHERWISE NOTED:

- A. ALL INSIDE CORNER FILLETS TO BE R6  
B. ALL OUTSIDE CORNER RADII TO BE R3

2.CASTING TOL. SHOULD BE WITH IN  
ANGULAR 0°6'

3.CASTING SHALL BE SUPPLIED AS PER

DRAWING DIMENSIONS AS IT IS ASSEMBLED  
AS IT IS.

01	CASTING				BA9114134721	22.0	
					AA19741		1
ITEM NO.	DESCRIPTION	DRAWING NO.	VAR. NO.	RAW MATERIAL SIZE OR CASTING DRG. NO. OR FORGING DRG. NO.	MATERIAL CODE	NET WT.	GROSS WT.
					MATERIAL SPECN.	QUANTITY	

THE FOLLOWING CONDITIONS APPLY EXCEPT OTHERWISE STATED.

- REF. TO HY0230261 FOR UNSPECIFIED TOLERANCES.
- CHAMFER M/CD. SHARP EDGES 1.2 TO 1.0 AT 45°.
- INTERNAL M/CD. CORNER RADII 1 TO 0.7
- THE SURFACE ROUGHNESS WHERE-EVER NOT SHOWN SHALL BE TAKEN FROM THE SURFACE ROUGHNESS SHOWN OUT SIDE THE BACK SLASH GIVEN OR THE TOP MOST RIGHT CORNER OF THE DRG.

TYPE OF PRODUCT

NAME OF CUSTOMER/PROJECT

883 XRP BOWL MILL




BHARAT HEAVY ELECTRICALS LIMITED  
HYDERABAD

NAME	SIGN.	DATE	NO.OF VAR.
KRISHNA		29.11.03	
G.S.N.M.R		29.11.03	

DEPT. PULV ENGG. CODE 446

UNTOL. DIMS. GR. 4/M/F

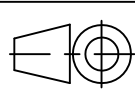

SCALE 1:2.5

WEIGHT (KG) 22.0

REF. TO ASSY DRG. 2.61.088.02067

ITEM NO. 01 NO.OF ITEMS 06

TITLE  
JOURNAL HEAD LINER

DRAWING NO. 2-61-088-02057

REV. 02

SHEET NO. 01 NO OF SHEETS 01

REV.	DATE	ALTERED CHD.	APPD.	REV.	DATE	ALTERED CHD.	APPD.	REV.	DATE	ALTERED CHD.	APPD.
02	29.11.03										
DRAWING REDRAWN ON AUTOCAD											

KRISHNA  
G.S.N.M.R



1. ALL RADII TO BE 1.5mm UNLESS OTHERWISE SPECIFIED.
2. CASTING TOL. SHOULD BE WITHIN  $\pm 0.0$  ANGULAR  $0.6^\circ$
3. CASTING SHALL SUPPLIED AS PER DRG.DIMENSIONS WITH OUT ANY ALLOWANCES AS THE ITEM IS ASSEMBLD AS IT IS.

BA9114134764	16.00	1
AA19741		
MATERIAL CODE	NET WT.	GROSS WT.
MATERIAL SPECN.	QUANTITY	

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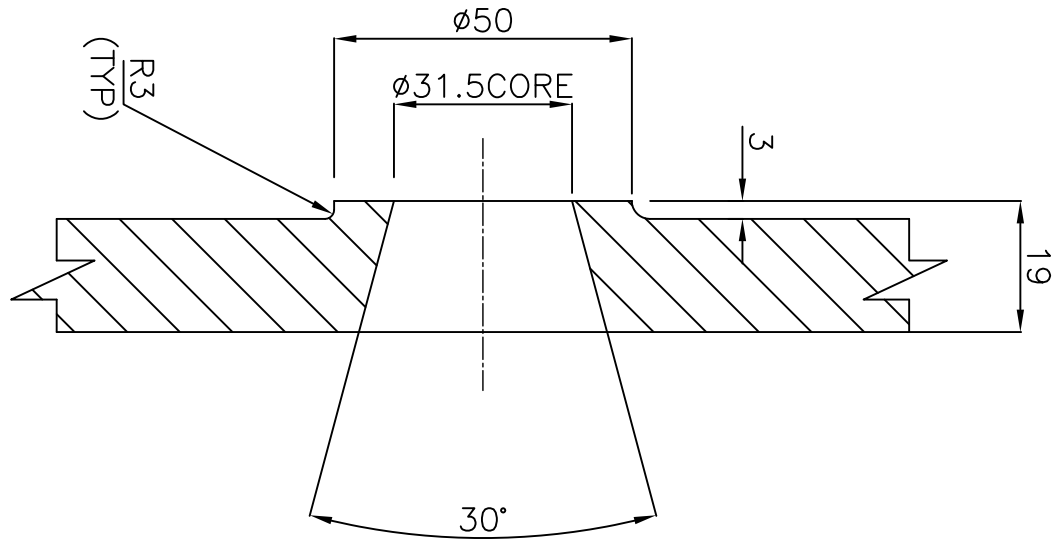
883 XRP BOWL MILL

- |      | NAME        | SIGN. | DATE     | NO. OF<br>VAR. |
|------|-------------|-------|----------|----------------|
| DRN. | RAZVI       |       | 13.11.03 |                |
| CHD. | G.S.N.M.RAO |       | 13.11.03 |                |

DEPT. PLANT ENG'G	UNITOL. DIMS. OR	SCALE	WEIGHT (KG)	REF. TO ASSY DRG.	ITEM NO.	NO. OF ITEMS
	<i>d</i> /M/Y					
446		1:2.5	16.00	2.61.088.02060	4	5
TITLE				DRAWING NO.		
JOURNAL HEAD LINER				2-61-088-02060		
				SHEET NO. 01		NO OF SHEETS 01


DIM 470 AND ANGLE 9.81° ADDED.


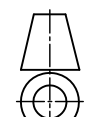

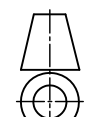

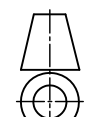
DRG. NO. 2-61-088-02061



## SECTION-AA


1. ALL RADIIT TO BE 1.5mm UNLESS OTHERWISE SPECIFIED.
2. CASTING TOL. SHOULD BE WITHIN  $+0.0$  ANGULAR  $-1.6$  ANGULAR  $0.6$
3. CASTING SHALL BE SUPPLIED AS PER DRAWING DIMENSIONS WITHOUT ANY ALLOWANCES AS THE ITEM IS ASSEMBLED AS IT IS

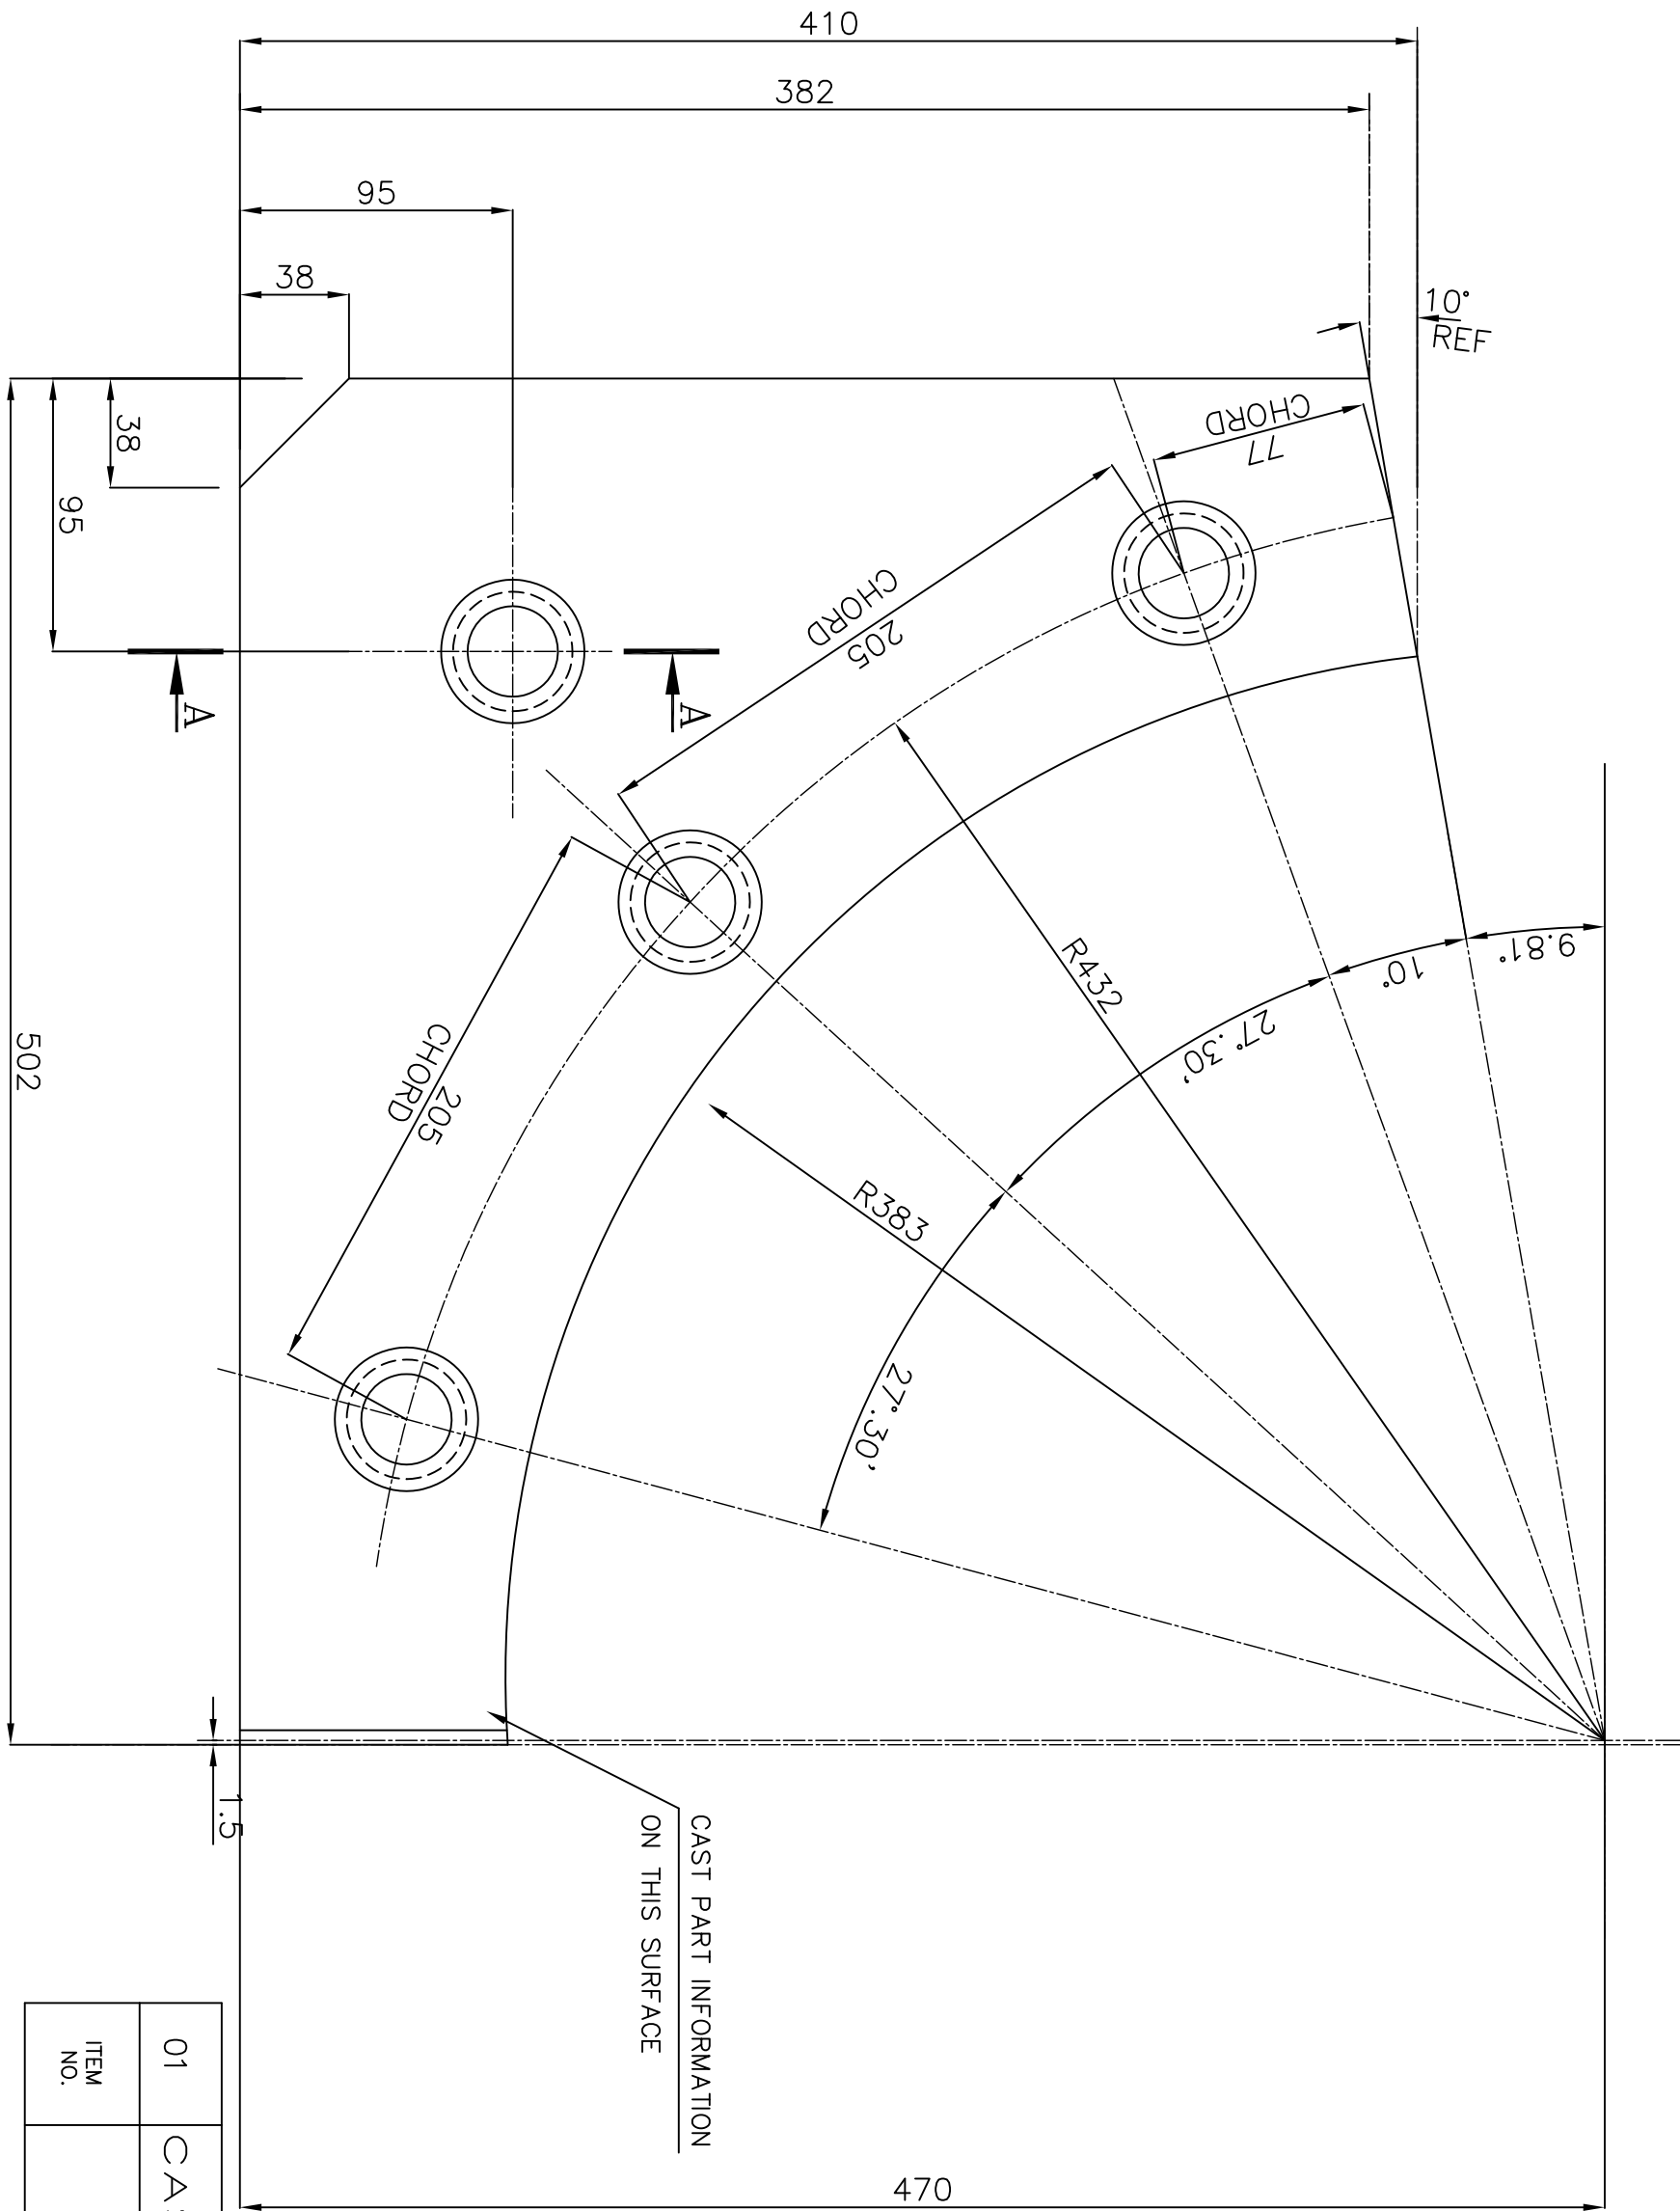

THE FOLLOWING CONDITIONS APPLY EXCEPT OTHERWISE STATED.																																																																																			
1. REF. TO HY0230261 FOR UNSPECIFIED TOLERANCES.																																																																																			
2. CHAMFER M/CD. SHARP EDGES 1.2 TO 1.0 AT 45°.																																																																																			
3. INTERNAL M/CD. CORNER RADII 1 TO 0.7																																																																																			
4. THE SURFACE ROUGHNESS WHERE-EVER NOT SHOWN SHALL BE TAKEN FROM THE SURFACE ROUGHNESS SHOWN OUT SIDE THE BACK SLASH GIVEN OR THE TOP MOST RIGHT CORNER OF THE DRG.																																																																																			
TYPE OF PRODUCT																																																																																			
NAME OF CUSTOMER/PROUJECT																																																																																			
883 XRP BOWL MILL																																																																																			
<table><tr><td colspan="2"></td><td colspan="2">BHARAT HEAVY ELECTRICALS LIMITED</td><td colspan="2">DRN.</td><td colspan="2">NAME</td><td colspan="2">SIGN.</td><td colspan="2">DATE</td><td colspan="2">NO OF VAR.</td></tr><tr><td colspan="2" rowspan="2"></td><td colspan="2" rowspan="2">HYDERABAD</td><td colspan="2">CHD.</td><td colspan="2">G.S.N.M.RAO</td><td colspan="2"></td><td colspan="2">13.11.03</td><td colspan="2"></td></tr><tr><td colspan="2">APPLD.</td><td colspan="2"></td><td colspan="2"></td><td colspan="2"></td></tr></table>																BHARAT HEAVY ELECTRICALS LIMITED		DRN.		NAME		SIGN.		DATE		NO OF VAR.				HYDERABAD		CHD.		G.S.N.M.RAO				13.11.03				APPLD.																																									
		BHARAT HEAVY ELECTRICALS LIMITED		DRN.		NAME		SIGN.		DATE		NO OF VAR.																																																																							
		HYDERABAD		CHD.		G.S.N.M.RAO				13.11.03																																																																									
				APPLD.																																																																															
<table><tr><td colspan="2">DEPT. PLY ENGG.</td><td colspan="2">UNIML DIMS. GR.</td><td colspan="2">SCALE</td><td colspan="2">WEIGHT (KG)</td><td colspan="2">REF. TO ASSY DRG.</td><td colspan="2">ITEM NO.</td><td colspan="2">NO OF ITEMS</td></tr><tr><td colspan="2">446</td><td colspan="2">ø/M/Y</td><td colspan="2">1:2.5</td><td colspan="2">16.00</td><td colspan="2">2.61.088.02068</td><td colspan="2">3</td><td colspan="2">5</td></tr><tr><td colspan="10">TITLE</td><td colspan="2">DRAWING NO.</td><td colspan="2">REV.</td></tr><tr><td colspan="10">JOURNAL HEAD LINER</td><td colspan="2">2-61-088-02061</td><td colspan="2">03</td></tr><tr><td colspan="4">SHEET NO. 01</td><td colspan="4">NO OF SHEETS 01</td><td colspan="2"></td><td colspan="2"></td><td colspan="2"></td></tr></table>														DEPT. PLY ENGG.		UNIML DIMS. GR.		SCALE		WEIGHT (KG)		REF. TO ASSY DRG.		ITEM NO.		NO OF ITEMS		446		ø/M/Y		1:2.5		16.00		2.61.088.02068		3		5		TITLE										DRAWING NO.		REV.		JOURNAL HEAD LINER										2-61-088-02061		03		SHEET NO. 01				NO OF SHEETS 01									
DEPT. PLY ENGG.		UNIML DIMS. GR.		SCALE		WEIGHT (KG)		REF. TO ASSY DRG.		ITEM NO.		NO OF ITEMS																																																																							
446		ø/M/Y		1:2.5		16.00		2.61.088.02068		3		5																																																																							
TITLE										DRAWING NO.		REV.																																																																							
JOURNAL HEAD LINER										2-61-088-02061		03																																																																							
SHEET NO. 01				NO OF SHEETS 01																																																																															

[illegible]

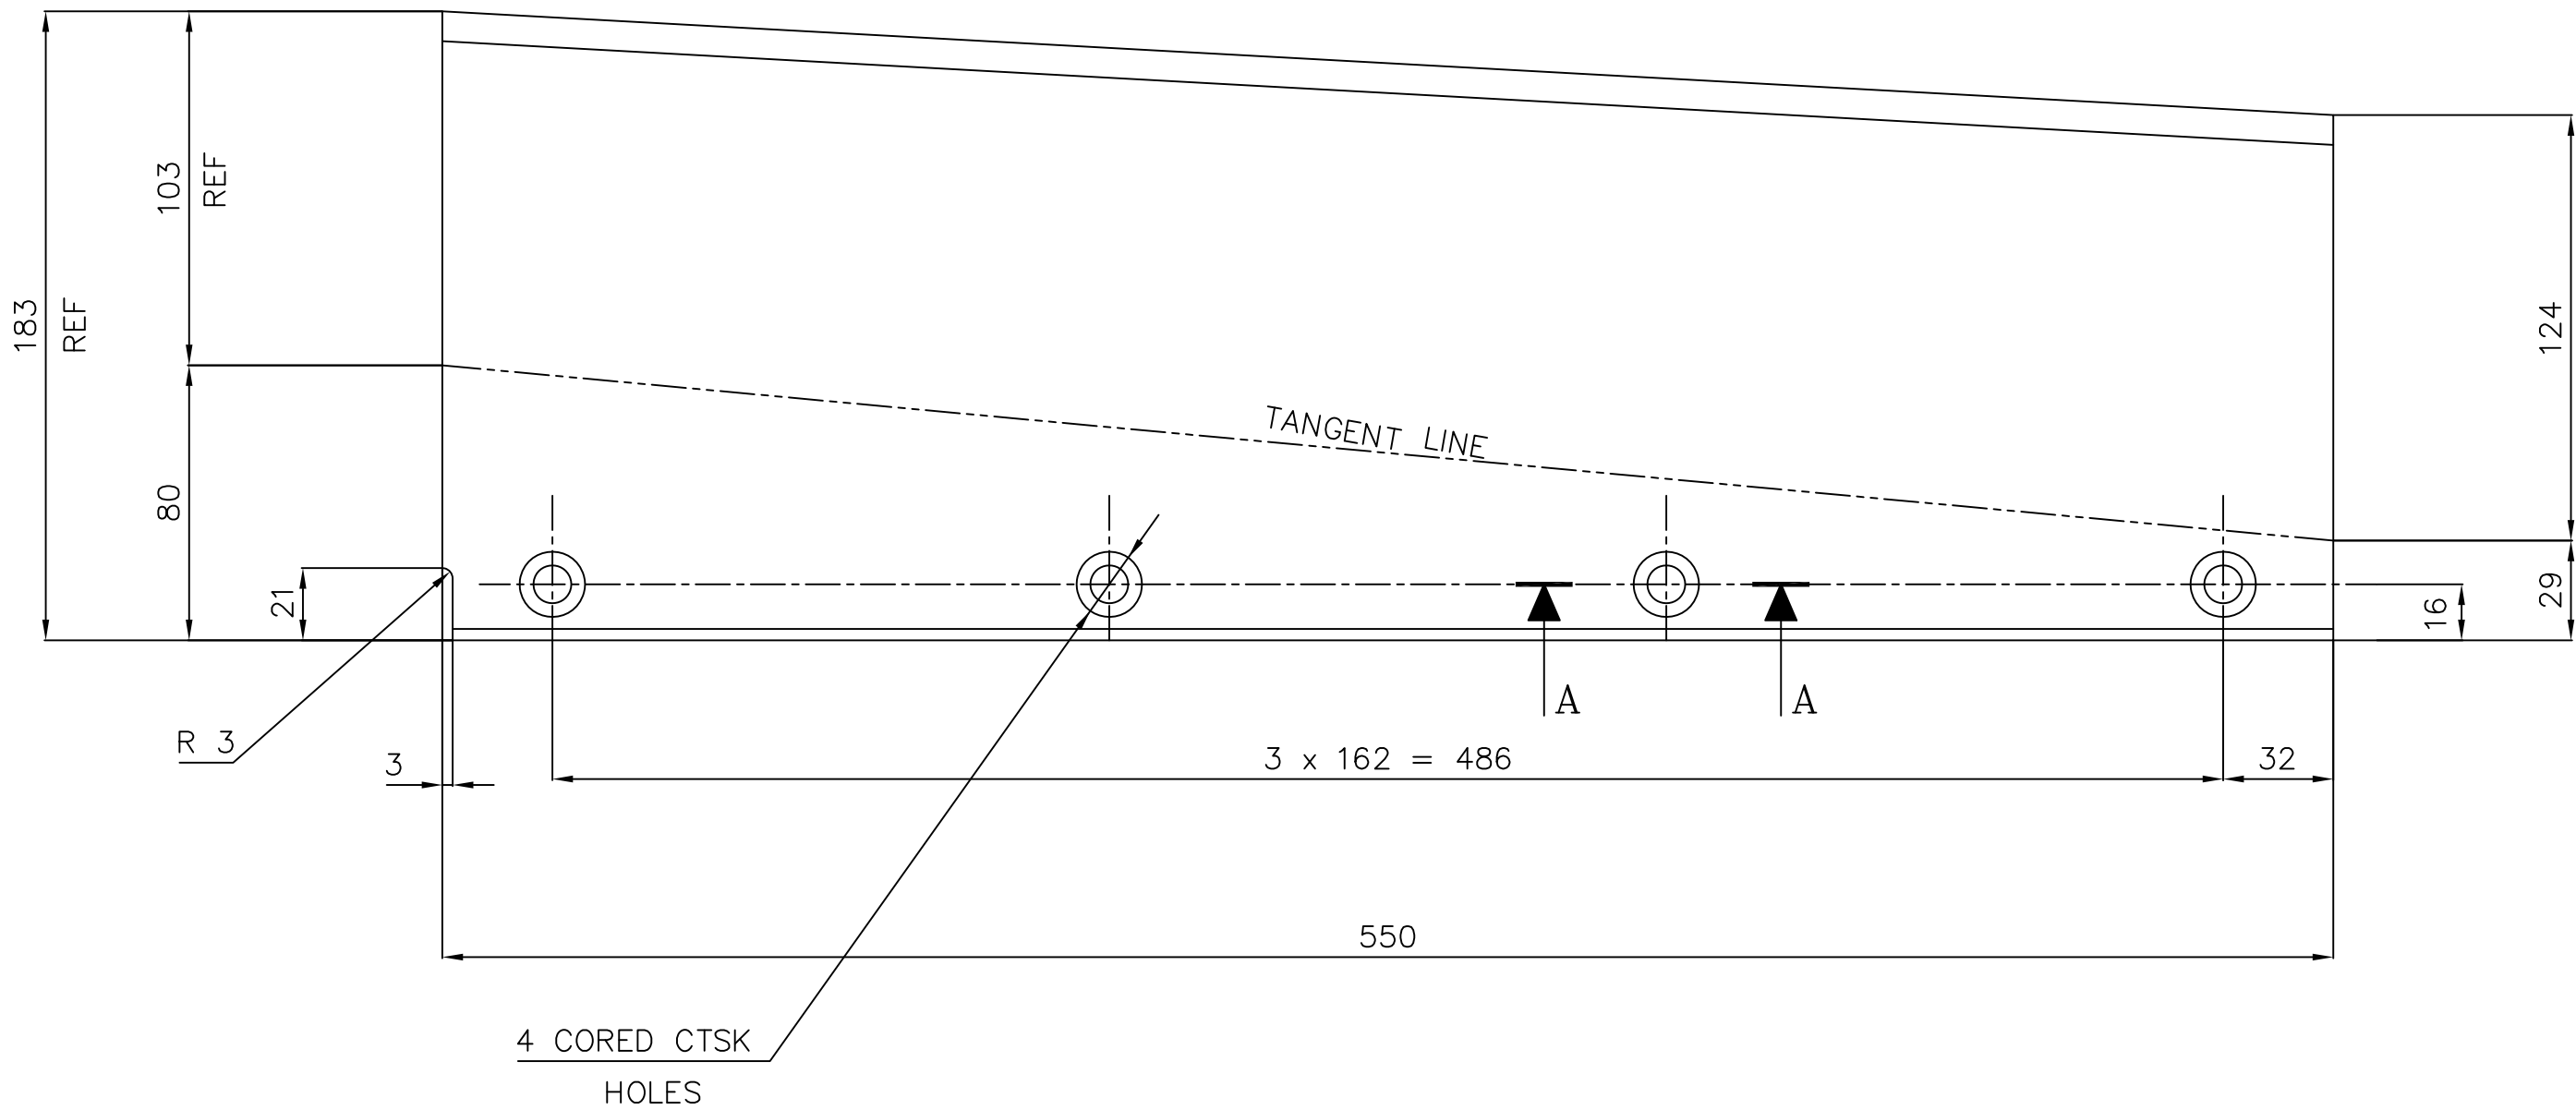

$$\frac{2}{\text{SH} \cdot \text{OF}}$$


NOTES : —

1. BREAK ALL SHARP EDGES AND CORNERS UNLESS OTHERWISE SPECIFIED.
2. PATTERN No. 2-61-300-00551.
3. CORED HOLES ARE TO BE CLEANED AND FREE FROM FINS, SAND ETC.
4. DIMENSIONS & LOCATIONS OF THE CORED HOLES ARE TO BE ENSURED WITH A TEMPLATE.

	REV.	DATE	ALTERED	REV.	DATE	ALTERED	REV.	DATE	ALTERED	N.D.S	REV.	DATE	ALTERED	N.D.S	
			CHD/APPD			CHD/APPD	04	29.06.04	CHD/APPD	S.G.	03	11.03.98	CHD/APPD	GSNMR	
	ZONE			ZONE			ZONE		WEIGHT WAS 7.8 NOTE 5 DELETED		ZONE		DRG. REDRAWN INCORPORATING ALL PREVIOUS REVISIONS		
1			2			3			4						

THE FOLLOWING CONDITIONS APPLY  
EXCEPT OTHERWISE STATED.

1. REF. TO HY0230261 FOR UNSPECIFIED TOLERANCES.
2. CHAMFER M/CD. SHARP EDGES 1.2 TO 1.0 AT 45°
3. INTERNAL M/CD. CORNER RADII 1 TO 0.7
4. THE SURFACE ROUGHNESS WHERE-EVER N SHOWN SHALL BE TAKEN FROM THE SURF. ROUGHNESS SHOWN OUT SIDE THE BACK SLASH GIVEN ON THE TOP MOST RIGHT CORNER OF THE DRG.


TYPE OF PRODUCT OR				
NAME OF CUSTOMER/PROJECT	883,1003	XRP	BOWL	MILL



BHARAT HEAVY ELECTRICALS LIMITED  
HYDERABAD

	NAME	SIGN.	DATE	NO.OF VAR.
DRN.	N.D.S		11.03.98	
CHD.	G.S.N.M.R		16.10.03	
APPD.	S.G.		29.06.04	

DEPT. BMD	UNTOL. DIMS.
DEPT CODE. 446	GR. <del>C</del> /M/ <del>A</del>

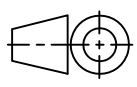

SCALE  
1:2  
1:1

WEIGHT (KG)	10.00
-------------	-------

REF. TO ASSY. DRG.  
C-101-00215/06  
2-61-388-02133

ITEM NO.	NO.OF ITEMS
1	5

DEFLECTOR BLADE


CARD  
CODE

DRAWING NO.  
2-61-300-00551



REV.  
04

SHT. No 01 | NO. OF SHT. 01

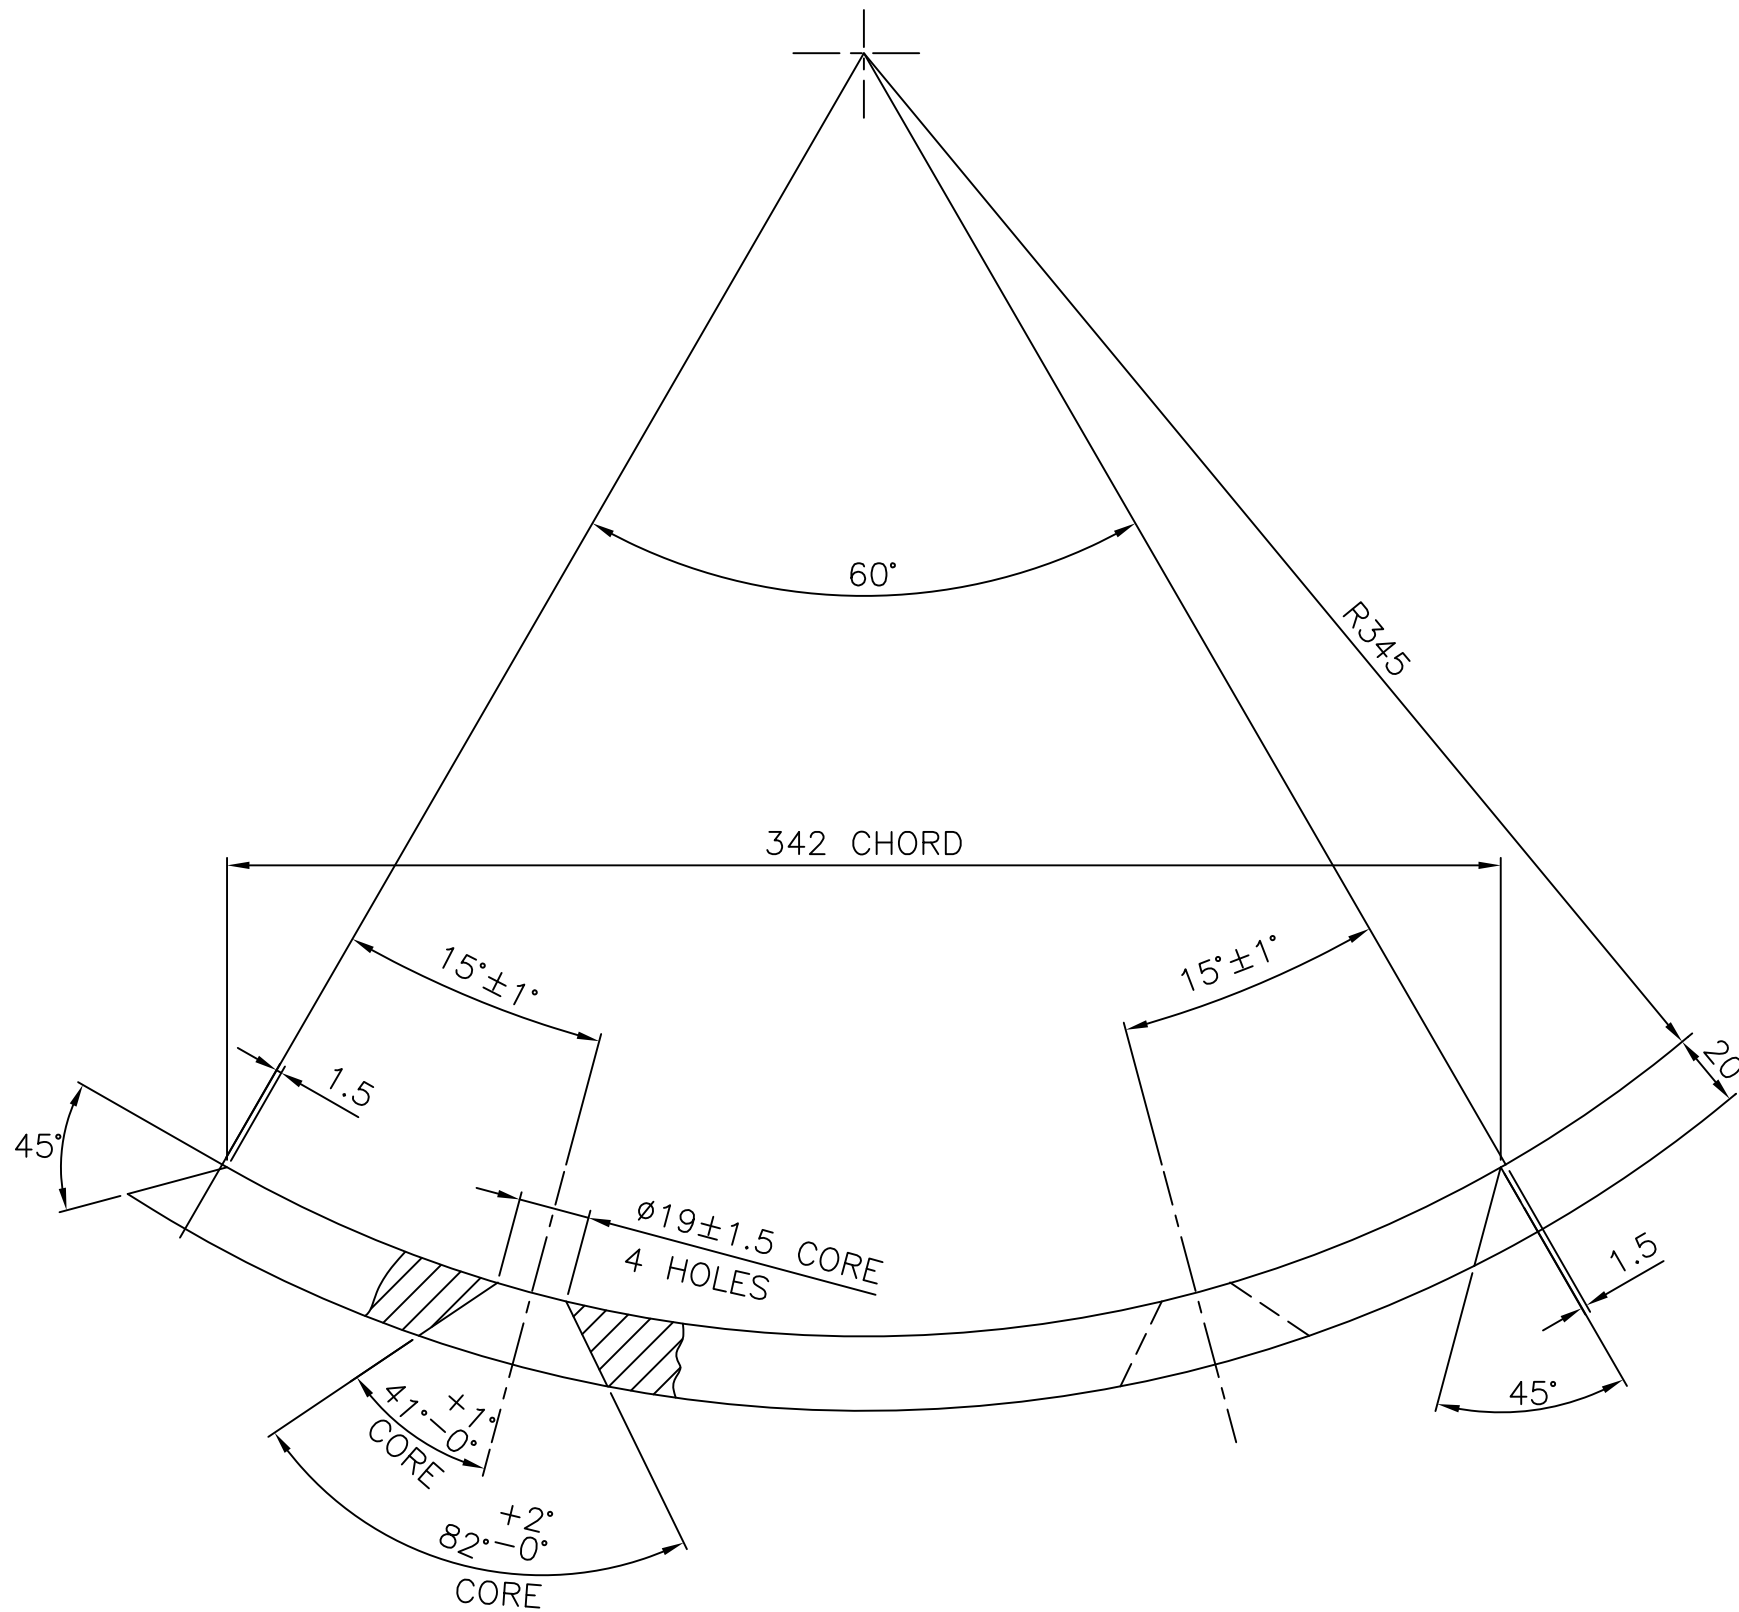DRG, NO. 2-61-300-01184



	CASTING				BA9114153572	32.000	
					AA19741		
				RAW MATERIAL SIZE OR CASTING DRG.NO. OR FORGING DRG.NO.	MATERIAL CODE	NET WT.	GROSS WT.
ITEM NO	DESCRIPTION	DRAWING NO.	VAR. NO.		MATERIAL SPECN.	QUANTITY	



TYPE OF PRODUCT OR NAME OF CUSTOMER/PROJECT				1003 XRP BOWL MILL				
 BHARAT HEAVY ELECTRICALS LTD. HYDERABAD					NAME	SIGN.	DATE	NO.OF VAR.
				DRN.	N.D.S		17.02.99	
				CHD.	S.G		17.02.99	
				APPD.	K.M.R		17.02.99	NA
DEPT.	PULV.ENGG		SCALE	WEIGHT(Kg)	REF. TO ASSY DRG. C-GP-4732 P/N. GP-4732	ITEM NO.	NO.OF ITEMS	
CODE	446		1:2	32.000	-NA-	NA		
TITLE INNER CONE SPOUT SEGMENT					DRAWING NO.		REV.	
					2-61-300-01184		02	
					SHEET NO.	01	NO OF SHEETS	01

INVENTORY NO. REF.DRG.NO. 26102274.DWG COMP. FILE NAME 26102274.DWG THE INFORMATION ON THIS DOCUMENT IS THE PROPERTY OF BHARAT HEAVY ELECTRICALS LIMITED. IT MUST NOT BE USED DIRECTLY OR INDIRECTLY IN ANY WAY DETRIMENTAL TO THE INTEREST OF THE COMPANY.

FIRST ANGLE PROJECTION

(ALL DIMENSIONS ARE IN mm)


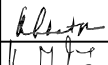
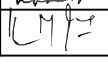
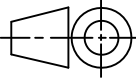
DRG.NO. 2-61-304-02274

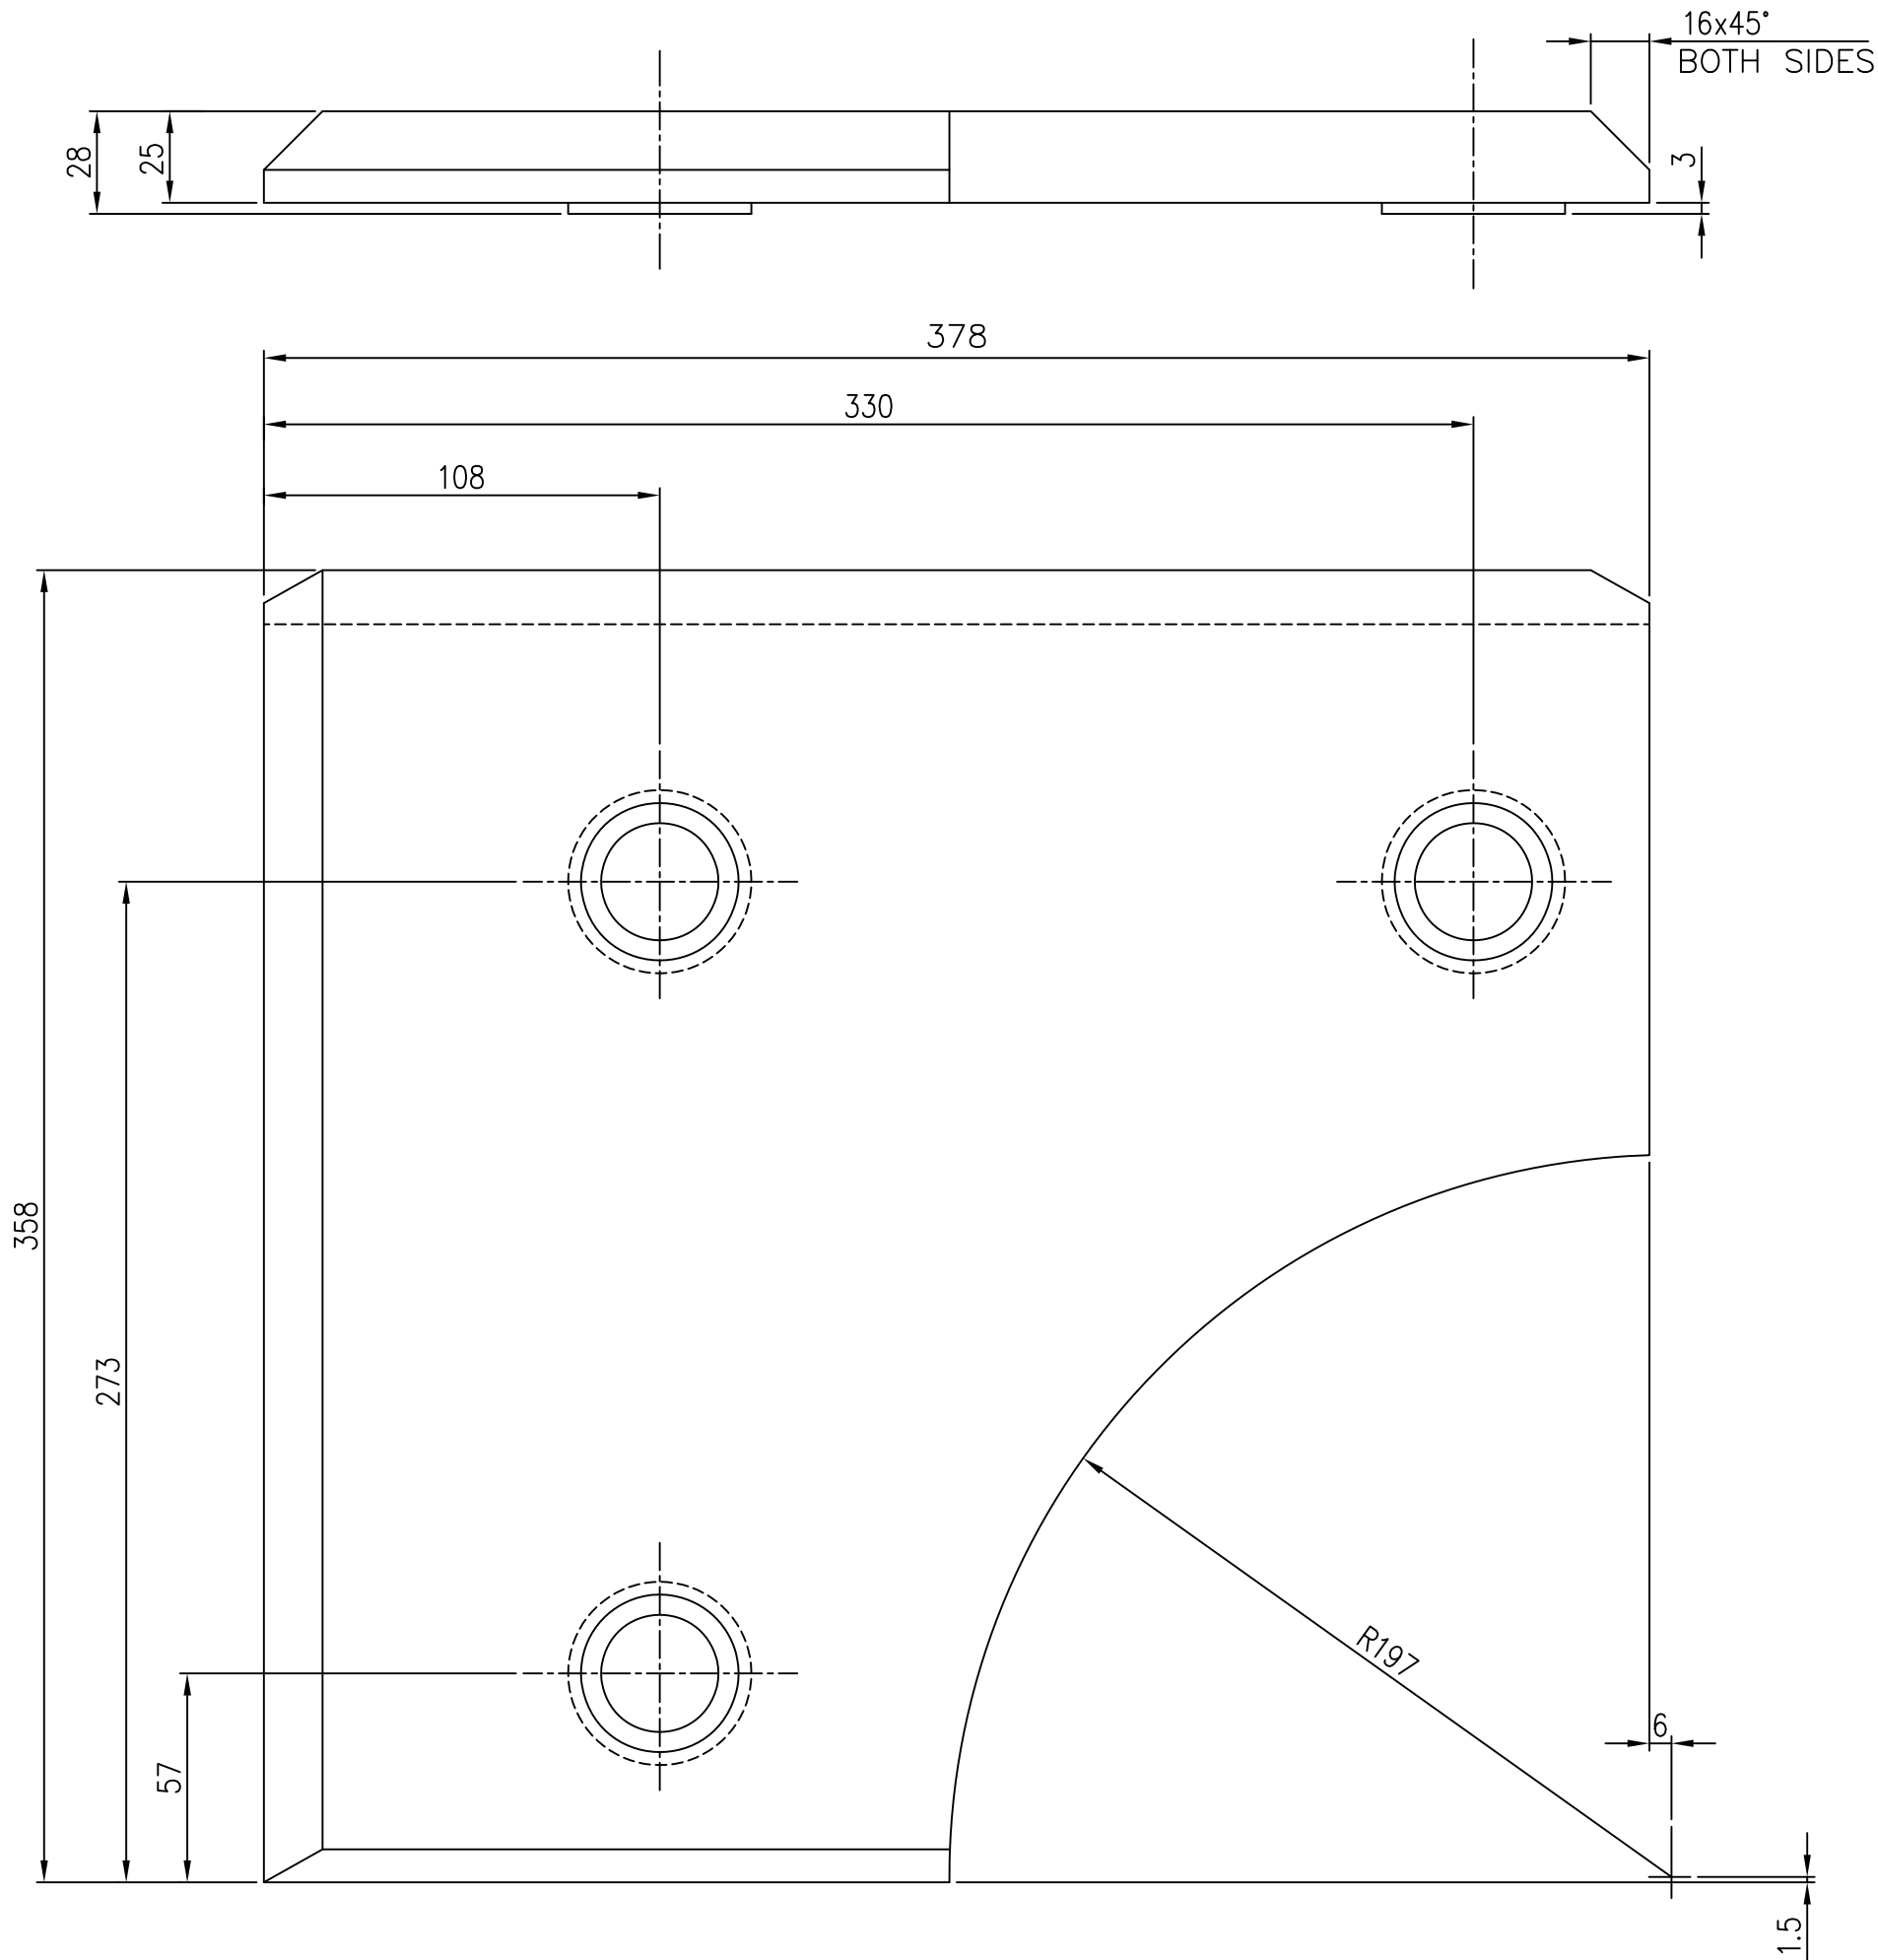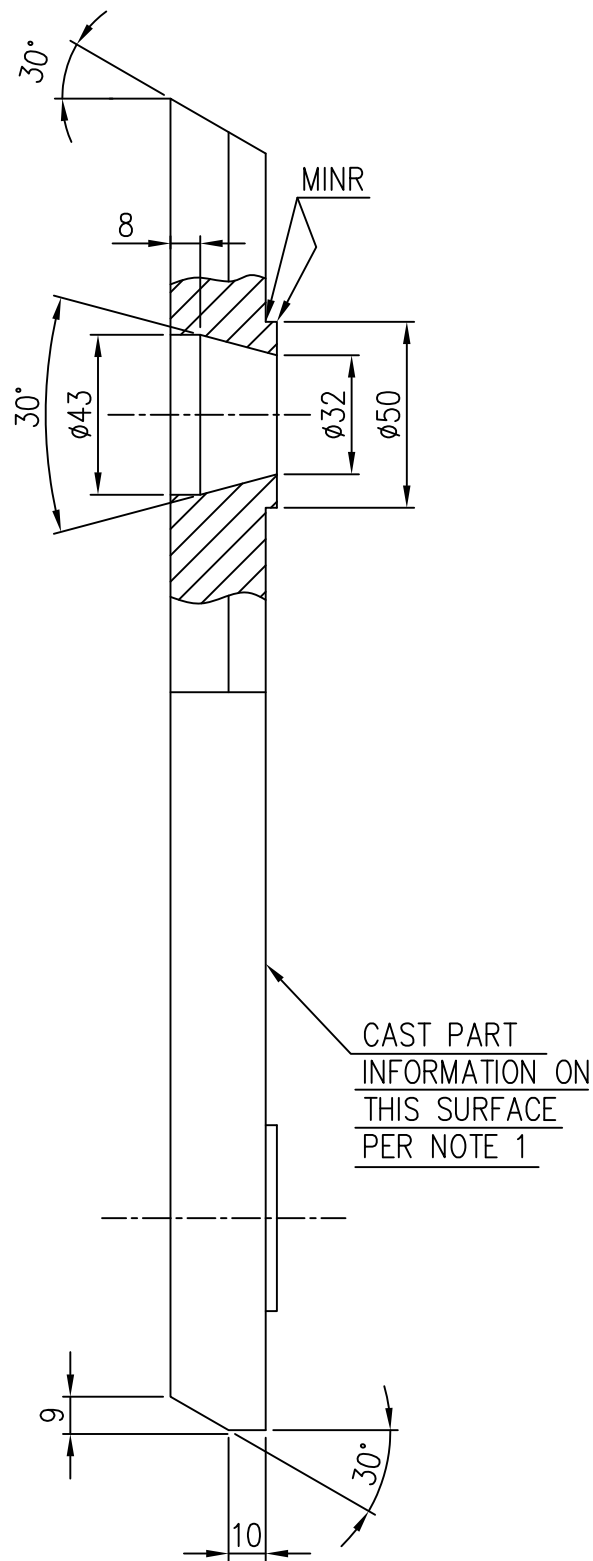

- NOTE:-
- 01. FOLLOWING INFORMATION TO BE CAST IN TO PART USING 3MM MAX. HEIGHT LETTERS 2613042274
  - 02. BREAK ALL SHARP EDGES AND CORNERS UNLESS OTHERWISE NOTED.
  - 03. TOLERANCES UNLESS OTHERWISE NOTED.  
CASTING±1.6  
ANGULAR ±0.1°

01	CASTING			BA9114135361	20.500	
				19741		1
ITEM NO	DESCRIPTION	DRAWING NO.	VAR. NO.	RAW MATERIAL SIZE OR CASTING DRG.NO. OR FORGING DRG.NO.	MATERIAL CODE	NET WT. GROSS WT.
					MATERIAL SPECN.	QUANTITY

- THE FOLLOWING CONDITIONS APPLY EXCEPT OTHERWISE STATED...
- REF.TO HY0230261 FOR UNSPECIFIED TOLERANCES.
  - CHAMFER M/CD SHARP EDGES 1.2 TO 1.0 AT 45°.
  - INTERNAL M/CD CORNER RADII 1 TO 0.7.
  - THE SURFACE ROUGHNESS WHEREVER NOT SHOWN SHALL BE TAKEN FROM THE SURFACE ROUGHNESS SHOWN OUT SIDE BACK SLASHES GIVEN AT THE TOP MOST RIGHT CORNER OF THE DRG.


TYPE OF PRODUCT OR NAME OF CUSTOMER/PROJECT		1043 RP BOWL MILL CHANDRAPUR-500 MW				
 BHARAT HEAVY ELECTRICALS LTD. HYDERABAD			NAME	SIGN.	DATE	NO.OF VAR.
		DRN.	n.d.samuel		15.6.99	
		CHD.	s.ghatge		15.6.99	-NA-
		APPD.	k.m.rao		15.6.99	
DEPT. PULV. ENGG.		SCALE	WEIGHT(Kg)	REF. TO ASSY DRG.	ITEM NO.	NO.OF ITEMS
CODE 446		1:2	20.500	C-110-00818/1	-NA-	-NA-
TITLE JOURNAL OPENING FRAME LINER				DRAWING NO. 2-61-304-02274	REV. 00	
				SHEET NO. 01	NO OF SHEETS 01	

REV.	DATE	ALTERED	REV.	DATE	ALTERED	REV.	DATE	ALTERED	REV.	DATE	ALTERED
		CHECKED			CHECKED			CHECKED			CHECKED
		APPD.			APPD.			APPD.			APPD.
ZONE			ZONE			ZONE			ZONE		
1			2			3			4		


INVENTORY NO		SIGN. AND DATE	REF. DRG. NO.	COMPUTER FILE NAME	THE INFORMATION ON THIS DOCUMENT IS THE PROPERTY OF BHARAT HEAVY ELECTRICALS LIMITED. IT MUST NOT BE USED DIRECTLY OR INDIRECTLY IN ANY WAY DETRIMENTAL TO THE INTEREST OF THE COMPANY

GENERAL DIMENSIONAL LIMITS, FITS & TOLERANCES AS PER HY0230261

REV.	DATE	ALTERED	REV.	DATE	ALTERED	REV.	DATE	ALTERED	REV.	DATE	ALTERED
		CHD / APPD			CHD / APPD			CHD / APPD			CHD / APPD
ZONE			ZONE			ZONE			ZONE	15.6.99	DRAWING REDRAWN IN AUTOCAD

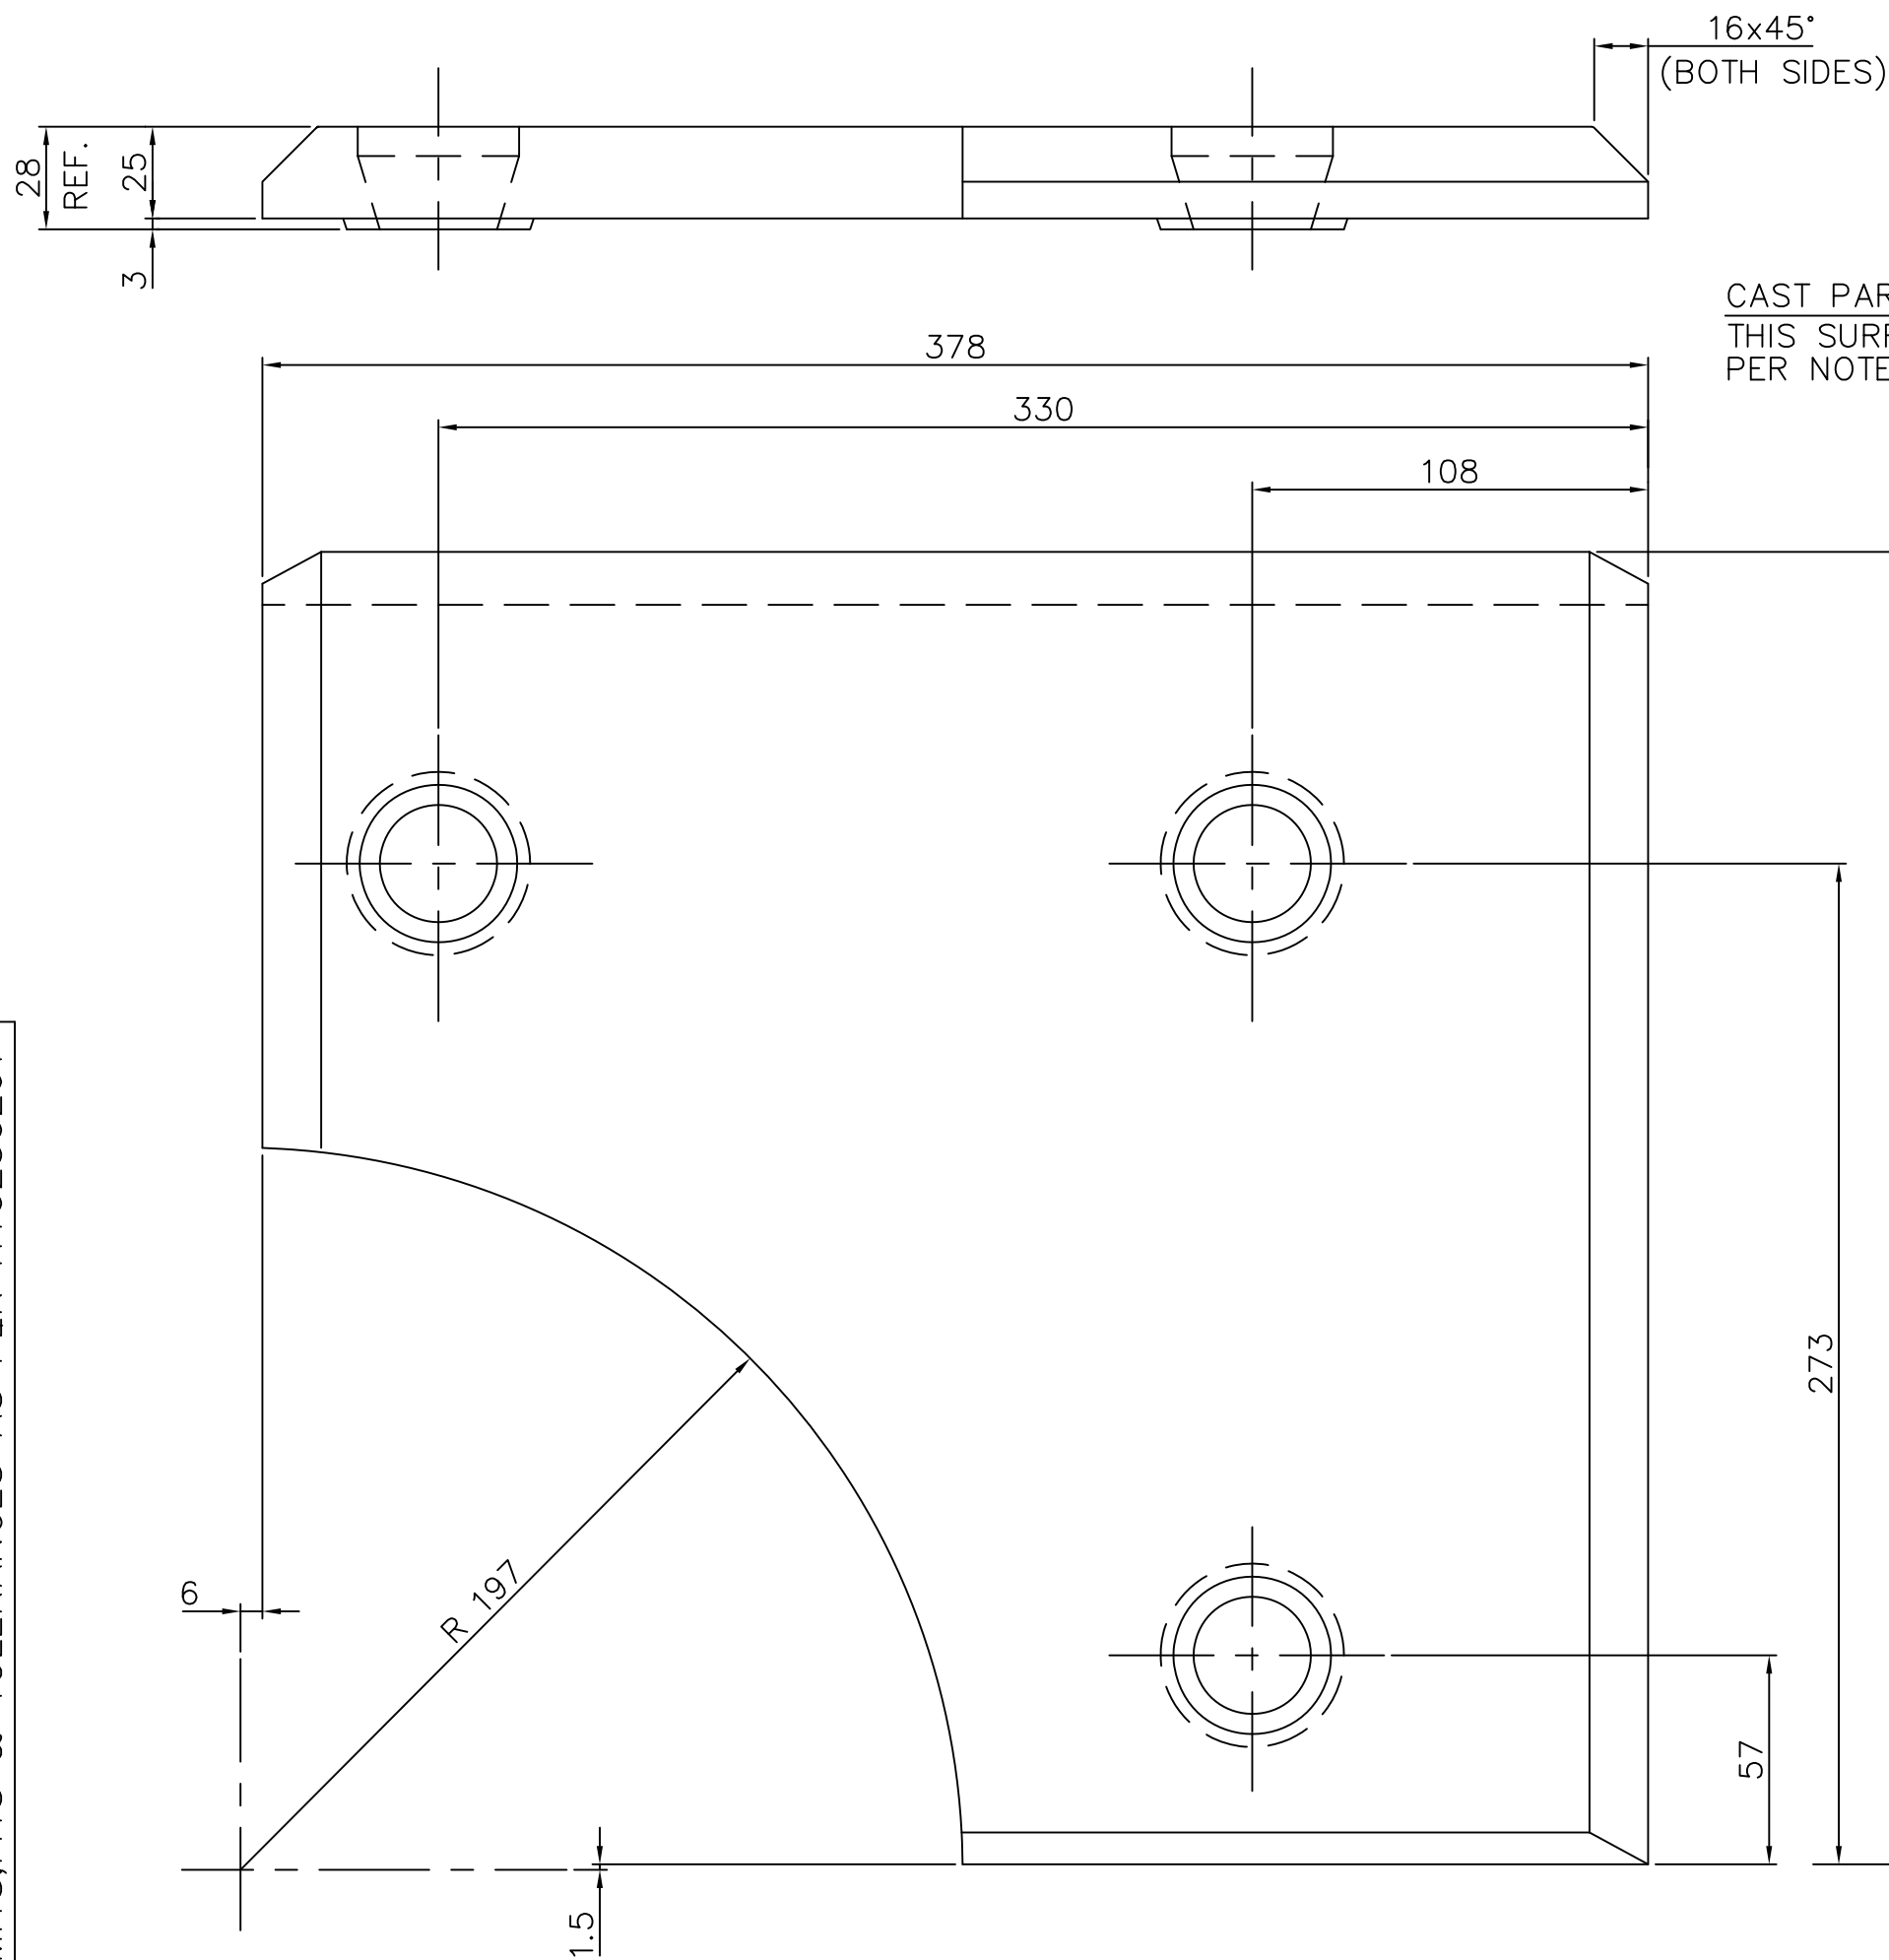

CAST PART INFO. ON  
THIS SURFACE  
PER NOTE :- 1

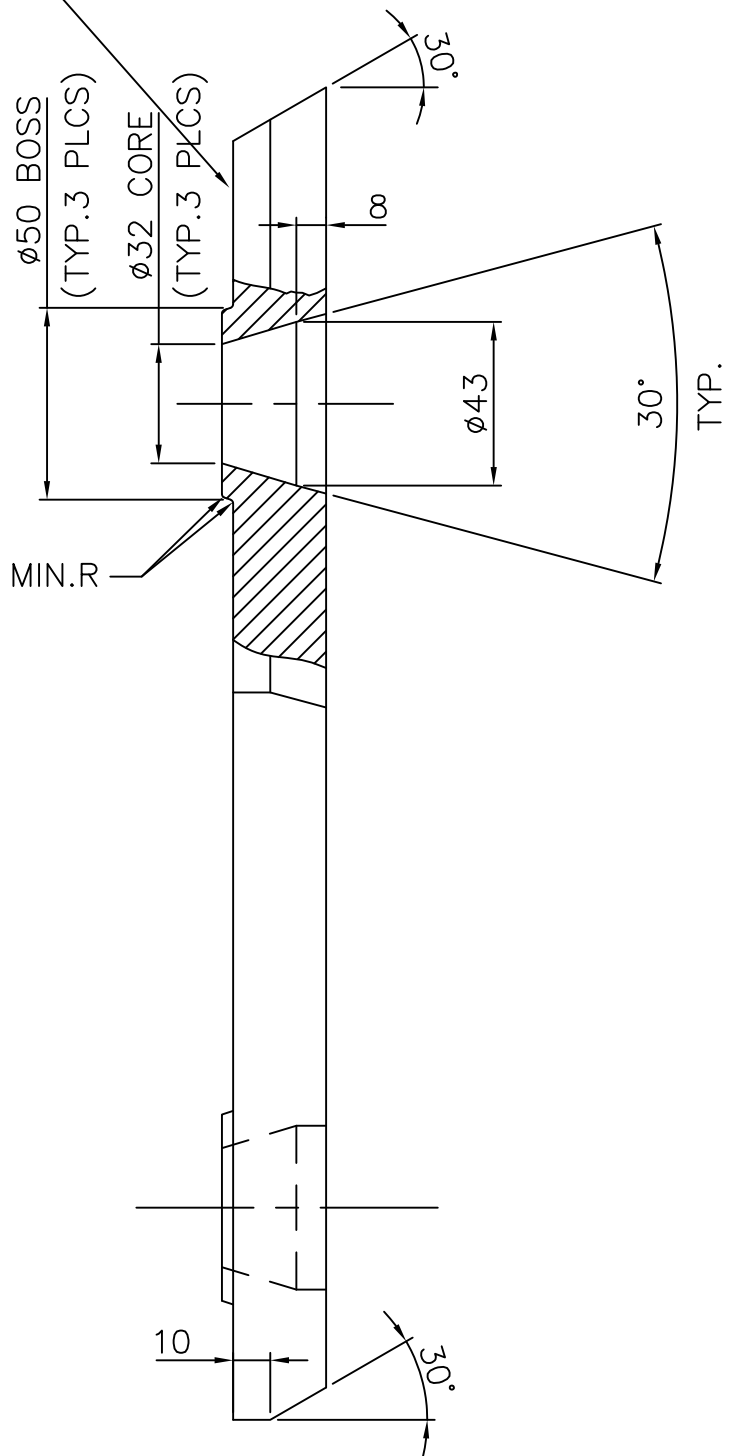

NOTES:



1. FOLLOWING INFORMATION TO BE CAST INTO PART  
USING 3mm MAX. HEIGHT LETTERS 26130402275
2. BREAK ALL SHARP EDGES AND CORNERS UNLESS  
OTHERWISE NOTED.
3. TOLERANCES UNLESS OTHERWISE NOTED :-  
CASTING  $\pm 1.6$   
ANGULAR  $\pm 0.1^\circ$

01	CASTING				BA9114135370	20.500	
					AA19741		
ITEM NO	DESCRIPTION	DRAWING NO.	VAR. NO.	RAW MATERIAL SIZE OR CASTING DRG.NO. OR FORGING DRG.NO.	MATERIAL CODE	NET WT.	GROSS WT.
					MATERIAL SPECN.	QUANTITY	

THE FOLLOWING CONDITIONS APPLY  
EXCEPT OTHERWISE STATED...

1. REF.TO HY0230261 FOR UNSPECIFIED TOLERANCES.
2. CHAMFER M/CD SHARP EDGES 1.2 TO 1.0 AT 45°.
3. INTERNAL M/CD CORNER RADII 1 TO 0.7.
4. THE SURFACE ROUGHNESS WHEREVER NOT SHOWN SHALL BE TAKEN FROM THE SURFACE ROUGHNESS SHOWN OUT SIDE BACK SLASHES GIVEN AT THE TOP MOST RIGHT CORNER OF THE DRG.

TYPE OF PRODUCT OR NAME OF CUSTOMER/PROJECT	1103 XRP BOWL MILL
--	--------------------

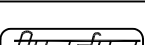		BHARAT HEAVY ELECTRICALS LTD. HYDERABAD				NAME	SIGN.	DATE	NO. OF VAR.
					DRN.	C.C.S.		15.6.99	
					CHD.	E.M.A.	<i>[Signature]</i>	15.6.99	
					APPD.	K.M.RAO	<i>[Signature]</i>	15.6.99	
DEPT. PULV		UNTOL. DIMS. GR.		SCALE 1:1	WEIGHT (KG) 20.500	REF. TO ASSY. DRG. C-110-00817/1		ITEM NO. -	NO. OF ITEMS -
CODE 446		<del>S.M.F.</del>							
TITLE JOURNAL OPENING FRAME LINER					CARD CODE N.A.	DRAWING NO.			REV. 01
						2-61-304-02275			
						SHT. No 01		NO. OF SHT. 01	







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CAST PART -  
INFORMATION  
THIS SIDE  
PER NOTE-1

NOTES:-

01. FOLLOWING INFORMATION TO BE CAST INTO PART  
USING 3mm MAX. HEIGHT LETTERS. 26100402276.
02. BREAK ALL SHARP EDGES AND CORNERS UNLESS  
OTHERWISE NOTED.
03. TOLERANCES UNLESS OTHERWISE NOTED.  
CASTING  $\pm 1.6$   
ANGULAR  $\pm 0.1^\circ$

01	CASTING				BA9114135388	21.000	
					AA19741	1	
ITEM NO.	DESCRIPTION	DRAWING NO.	VAR. NO.	RAW MATERIAL SIZE OR CASTING DRG. NO. OR FORGING DRG. NO.	MATERIAL CODE	NET WT.	GROSS WT.
					MATERIAL SPECN.	QUANTITY	

THE FOLLOWING CONDITIONS APPLY EXCEPT OTHERWISE STATED.  1. REF. TO HY0230261 FOR UNSPECIFIED TOLERANCES.  2. CHAMFER M/CD. SHARP EDGES 1.2 TO 1.0 AT 45'.  3. INTERNAL M/CD. CORNER RADII 1 TO 0.7  4. THE SURFACE ROUGHNESS WHERE-EVER NOT SHOWN SHALL BE TAKEN FROM THE SURFACE ROUGHNESS SHOWN OUT SIDE THE BACK SLASH GIVEN ON THE TOP MOST RIGHT CORNER OF THE DRG.	TYPE OF PRODUCT  NAME OF CUSTOMER/PROJECT		1103 XRP BOWL MILL						
		BHARAT HEAVY ELECTRICALS LIMITED  HYDERABAD	DRN.	NAME	SIGN.	DATE	NO.OF VAR.		
				UNIC					
				CHD.	S.GHATGE			22.5.99	
				APPD.	K.M.RAO			22.5.99	
	DEPT. PULV ENGG.	UNTOL. DIMS. GR.  Ø/M/φ		SCALE  1:2.5	WEIGHT (KG)  21.000	REF. TO ASSY DRG.  C-110-00814/1		ITEM NO. —	NO.OF ITEMS —
	CODE 446								
TITLE  JOURNAL OPENING  FRAME LINER				CARD CODE	DRAWING NO.  2-61-304-02276		REV.  01		
					SHEET NO. 01	NO OF SHEETS 01			

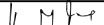DRG. NO. 2-61-304-02279

DRG. NO.

2

3




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
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				BA9114135418	16.100	
01	CASTING			AA19741		
ITEM NO.	DESCRIPTION	DRAWING NO.	VAR. NO.	RAW MATERIAL SIZE OR CASTING DRG.NO. OR FORGING DRG.NO.	MATERIAL CODE	NET WT.
					MATERIAL SPECN.	GROSS WT.
						QUANTITY

THE FOLLOWING CONDITIONS APPLY  
EXCEPT OTHERWISE STATED...  
1. REF. TO HY0230261 FOR UNSPECIFIED  
TOLERANCES.



1. REF. TO HY0230261 FOR UNSPECIFIED TOLERANCES.
2. CHAMFER M/CD SHARP EDGES 1.2 TO 1.0 AT 45°.
3. INTERNAL M/CD CORNER RADII 1 TO 0.7.
4. THE SURFACE ROUGHNESS WHEREVER NOT SHOWN SHALL BE TAKEN FROM THE SURFACE ROUGHNESS SHOWN OUT SIDE BACK SLASHES GIVEN AT THE TOP MOST RIGHT CORNER OF THE DRG.

TYPE OF PROJECT OR NAME OF CUSTOMER /PROJECT										1103 XRP BOWL MILL									
BHARAT HEAVY ELECTRICALS LTD. HYDERABAD																			
DEPT. PULV		UNTL. DIMS. GR. C/M/F				SCALE 1:2		WEIGHT (KG) 16.100				NAME		SIGN.		DATE		NO.OF VAR.	
CODE 446												DRL.				15.6.99			
												CHD.		E.M.A.		15.6.99		-	
												APPD.		K.M.RAD		15.6.99			
TITLE JOURNAL OPENING FRAME LINER										DRAWING NO. 2-61-304-02279									
N.A.		CARD CODE						REF. TO ASSY. DRG. C-110-00805/1		ITEM NO.								REV. 01	
SHT. No 01										NO. OF SHT. 01									


(ALL DIMENSIONS ARE IN mm)

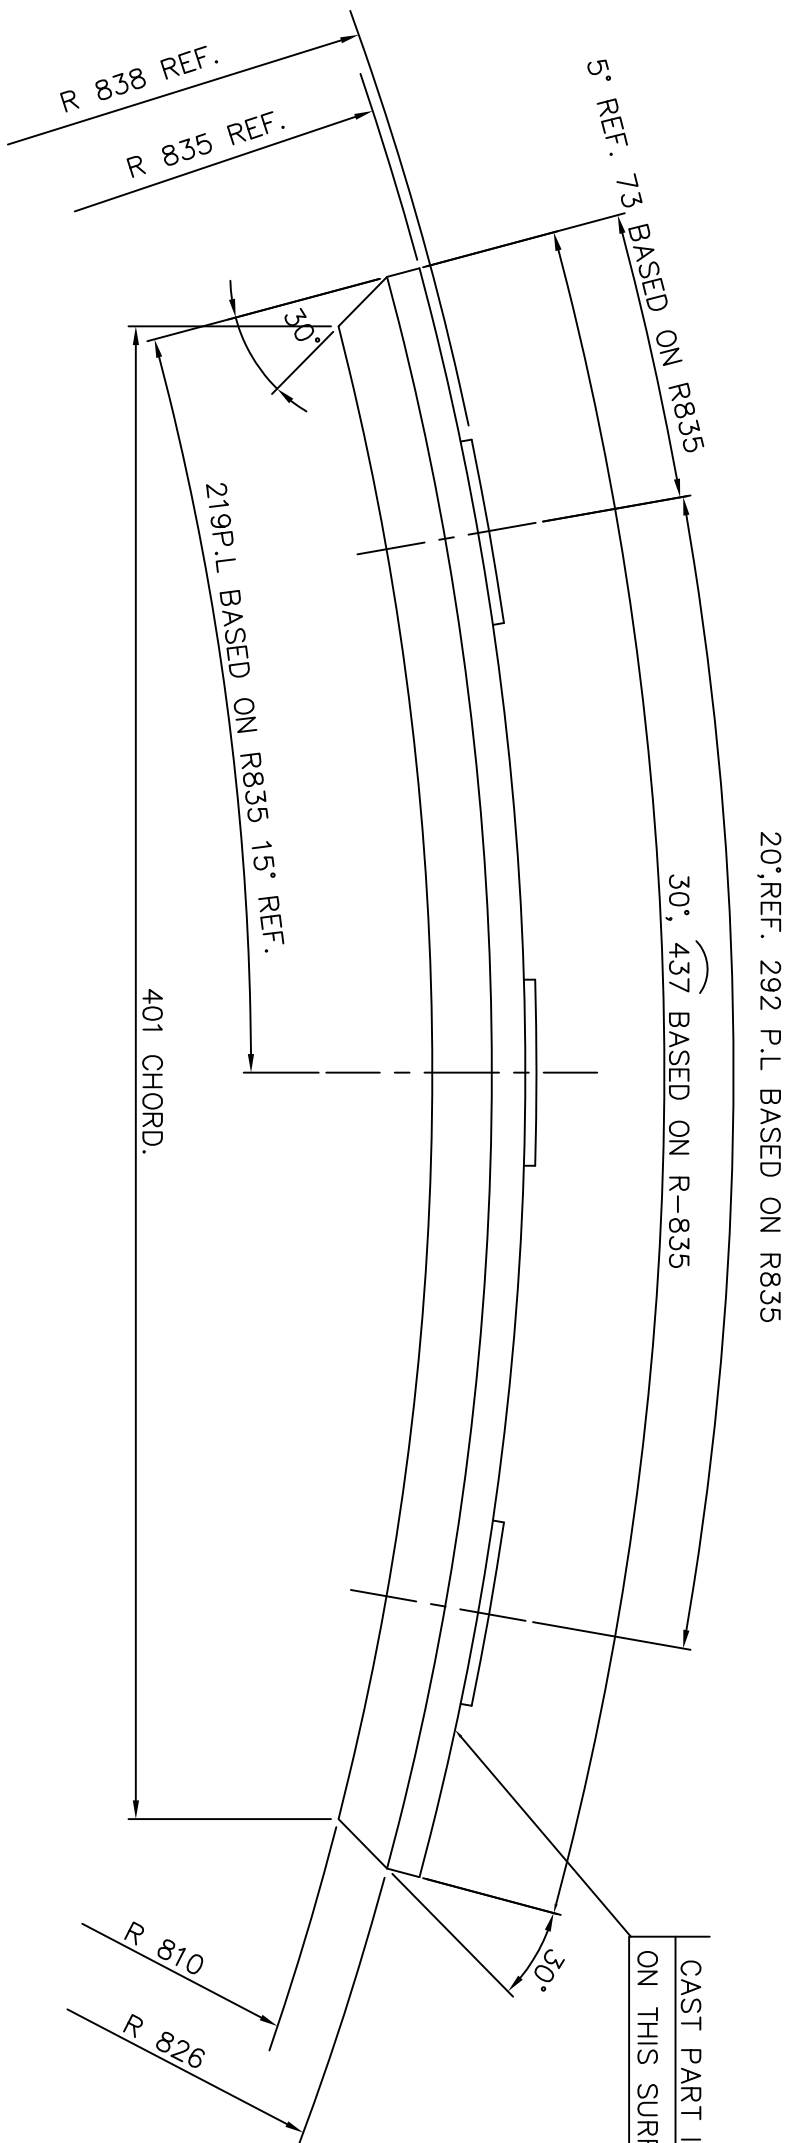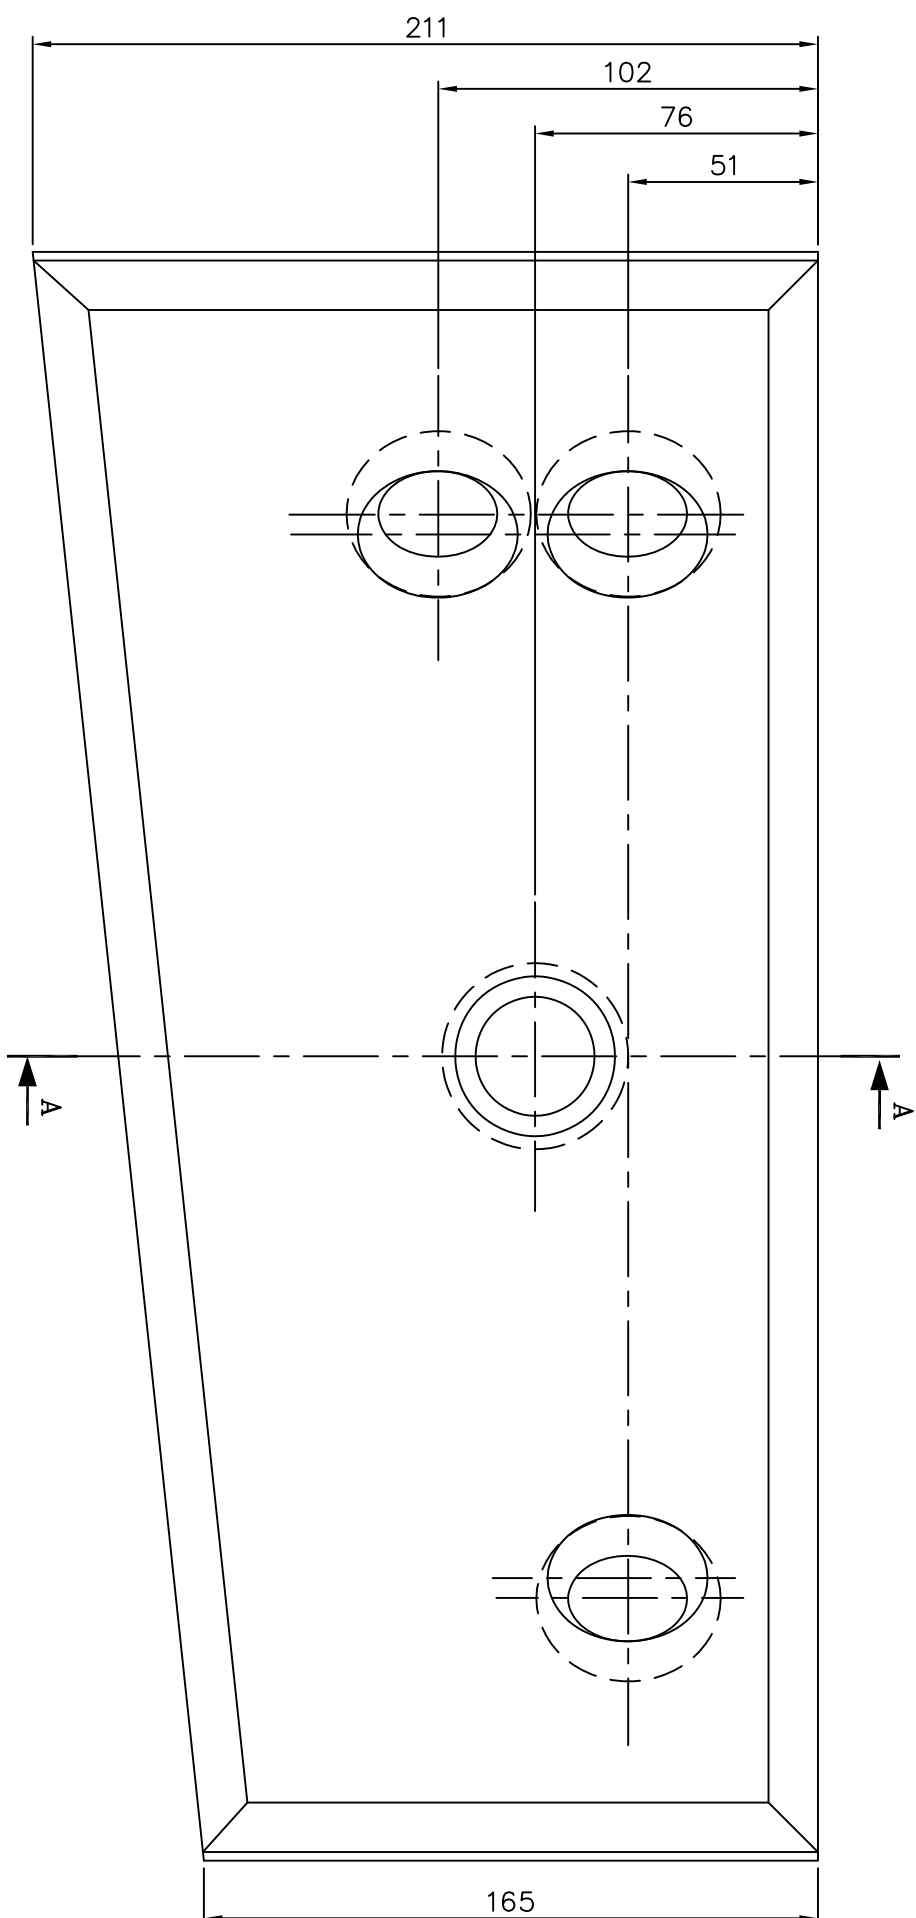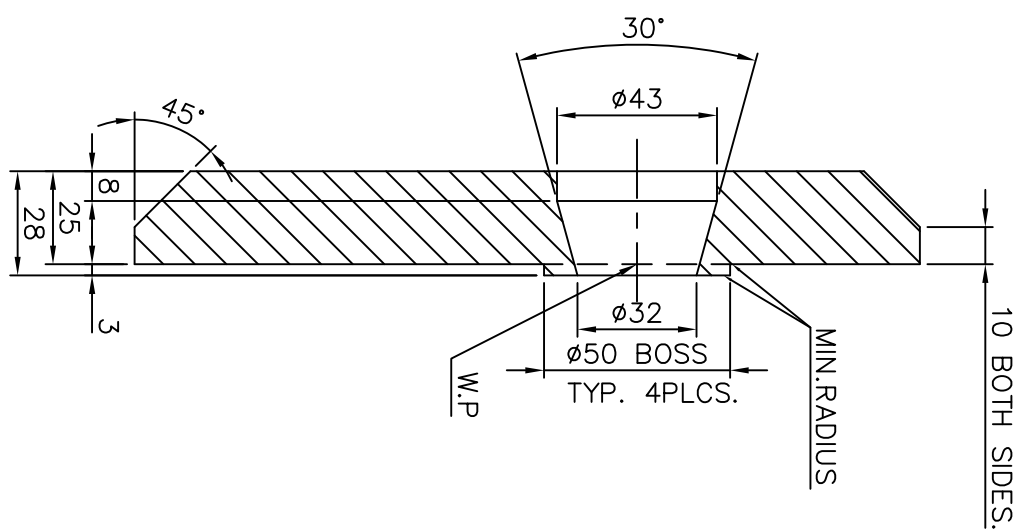FIRST ANGLE PROJECTION


DRG. NO. 2-61-404-02281

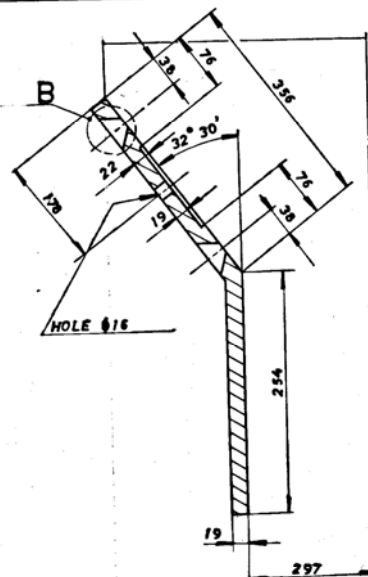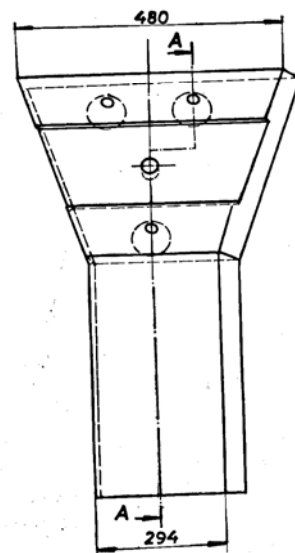

SECTION - A-A

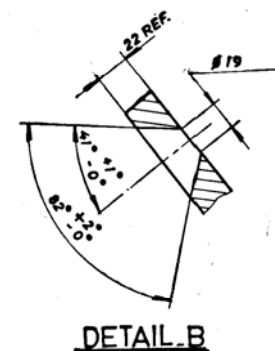

DETAIL B

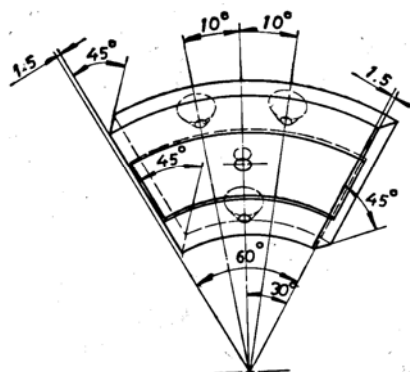

## NOTES:

1. BREAK ALL SHARP EDGES AND CORNERS UNLESS OTHERWISE NOTED.
2. TOLERANCES UNLESS OTHERWISE NOTED.  
CASTING  $\pm 1.6$   
ANGULAR  $\pm 0.1^\circ$

01 CASTING		AA 19741		43.200	
VAR. 00	REMARKS	ITEM NO.	DESCRIPTION	DRAWING NO.	UNIT WT.
CARD TYPE-3		CARD TYPE-2		CARD TYPE-1	
ADDITIONAL INFORMATION STATUS OF DRAWING DISTRIBUTION OF PRINTS					
TYPE OF PRODUCT OR NAME OF CUSTOMER/PROJECT 1043 RP BOWL MILL CHANDRAPUR - 500 MW					
BHARAT HEAVY ELECTRICALS LTD. HYDERABAD					
DEPT. BHD	GRADE OF TOL. DIM. S.M.F.	SCALE N.T.S.	WEIGHT (Kg) 43.200	REF. TO ASSY. DRG. C.GP.4064/06	ITEM NO. 16/7/75
TITLE INNER CONE SPOUT SEGMENT					
DRAWING NO. 2-61-304-02281 SHEET NO. 00					

GENERAL DIMENSIONS LIMITS, FITS &amp; TOLERANCES AS PER P.S-HY 02302 61

REV.	DATE	ALTERED	REV.	DATE	ALTERED	REV.	DATE	ALTERED
ZONE		CHECKED	ZONE		CHECKED	ZONE		CHECKED

THE INFORMATION ON THIS DOCUMENT IS THE PROPERTY OF BHARAT HEAVY ELECTRICALS LIMITED. IT MUST NOT BE USED DIRECTLY OR INDIRECTLY IN ANY WAY DETRIMENTAL TO THE INTEREST OF THE COMPANY.

COMP. FILE NAME: 26102287.DWG  
REF.DRG.NO.  
INVENTORY NO.

FIRST ANGLE PROJECTION

(ALL DIMENSIONS ARE IN mm)

DRG.NO. 2-61-304-02287

2

3

4

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6

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8

A

B

C

D

E

F

A


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C



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E

F



CAST PART INFORMATION THIS  
SURFACE PER NOTE.1

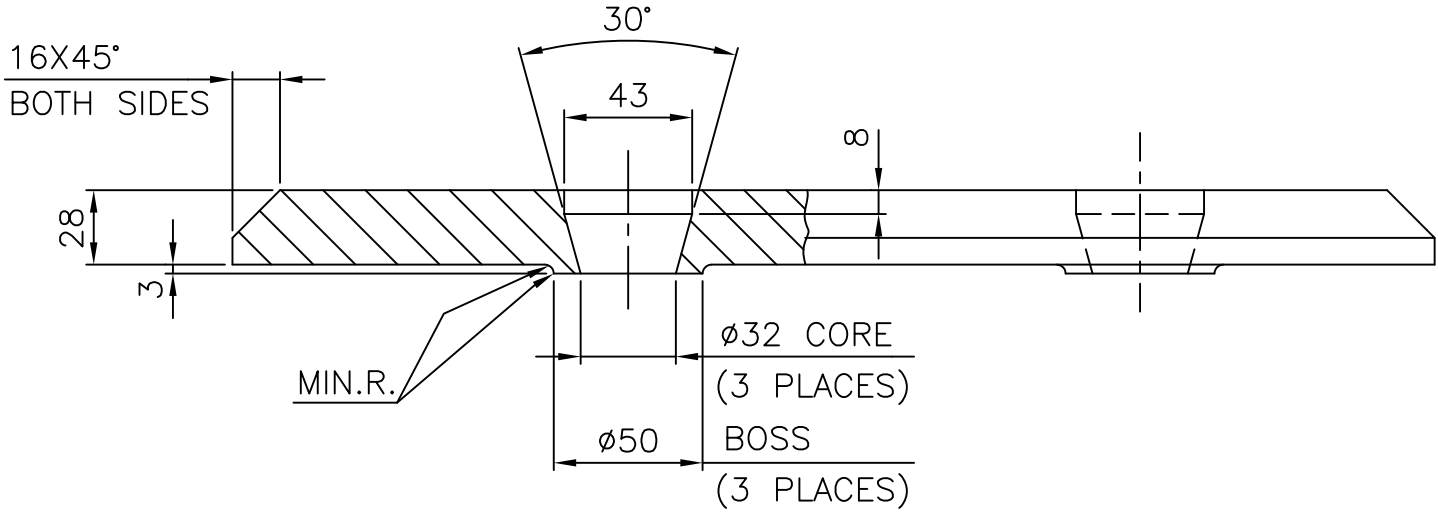

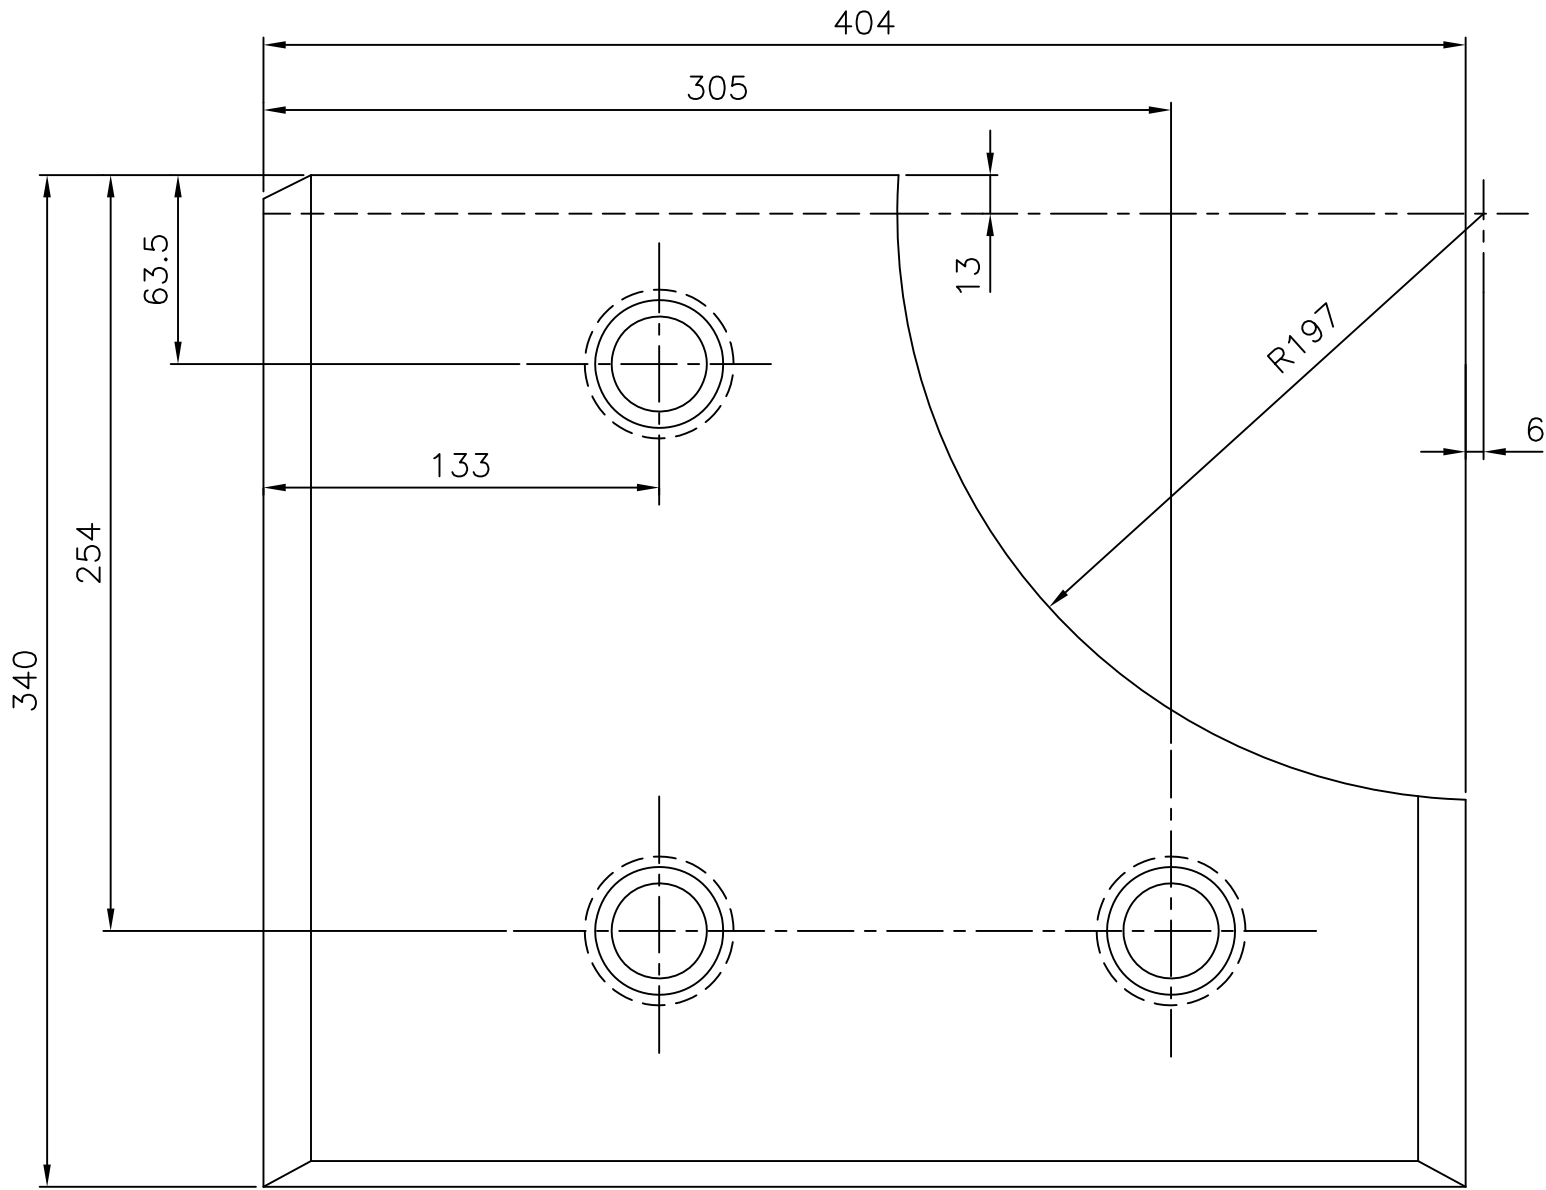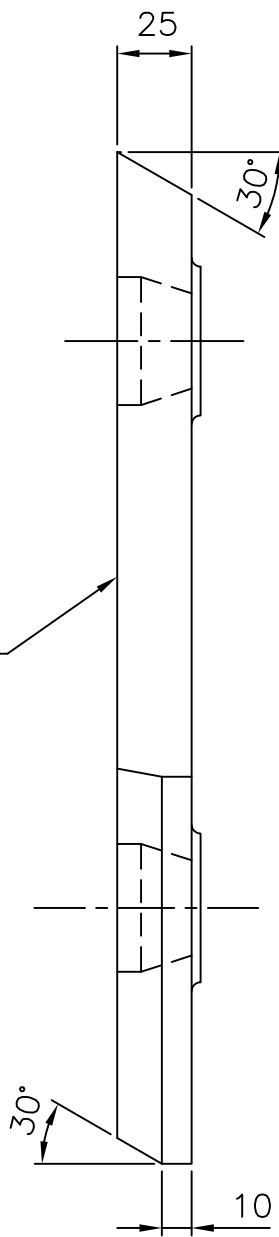NOTES:-


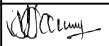
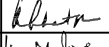
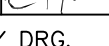
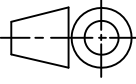
01. FOLLOWING INFORMATION TO BE CAST INTO PART USING 3mm MAXIMUM LETTER HEIGHT 26130402287
02. BREAK ALL SHARP EDGES AND CORNERS UNLESS OTHERWISE NOTED.
03. TOLERANCES UNLESS OTHERWISE NOTED:-  
CASTING  $\pm 1.6$   
ANGULAR  $\pm 0.1^\circ$

01	CASTING				BA9114135434	21.000	
					AA19741		1
ITEM NO	DESCRIPTION	DRAWING NO.	VAR. NO.	RAW MATERIAL SIZE OR CASTING DRG.NO. OR FORGING DRG.NO.	MATERIAL CODE	NET WT.	GROSS WT.
					MATERIAL SPECN.	QUANTITY	


THE FOLLOWING CONDITIONS APPLY EXCEPT OTHERWISE STATED...

1. REF.TO HY0230261 FOR UNSPECIFIED TOLERANCES.
2. CHAMFER M/CD SHARP EDGES 1.2 TO 1.0 AT 45°.
3. INTERNAL M/CD CORNER RADII 1 TO 0.7.
4. THE SURFACE ROUGHNESS WHEREVER NOT SHOWN SHALL BE TAKEN FROM THE SURFACE ROUGHNESS SHOWN OUT SIDE BACK SLASHES GIVEN AT THE TOP MOST RIGHT CORNER OF THE DRG.


TYPE OF PRODUCT OR NAME OF CUSTOMER/PROJECT 1043 RP. BOWL MILL

 BHARAT HEAVY ELECTRICALS LTD. HYDERABAD			NAME	SIGN.	DATE	NO.OF VAR.
		DRN.	N.D.SAMUEL			
		CHD.	S.GHATGE		22.5.99	
		APPD.	K.M.RAO		22.5.99	
DEPT. PULV.ENGGE.		SCALE N.T.S	WEIGHT(Kg) 21.000	REF. TO ASSY DRG. C-110-00800/1	ITEM NO. -	NO.OF ITEMS -
CODE 446				TITLE JOURNAL OPENING FRAME LINER	DRAWING NO. 2-61-304-02287	REV. 01
					SHEET NO. 01	NO OF SHEETS 01

REV.	DATE	ALTERED		REV.	DATE	ALTERED		REV.	DATE	ALTERED		REV.	DATE	ALTERED	
		CHECKED	APPD.			CHECKED	APPD.			CHECKED	APPD.			CHECKED	APPD.
ZONE				ZONE				ZONE				ZONE			
1				2				3				4			

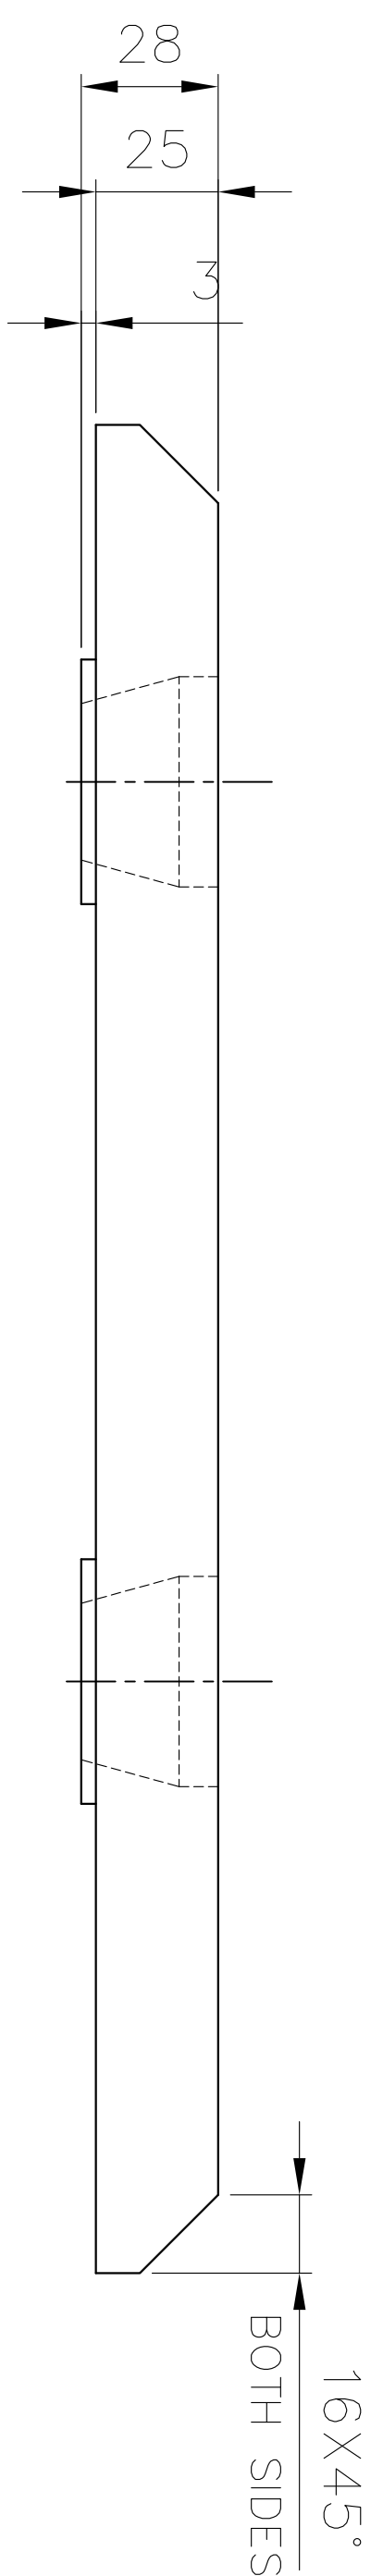


CAST PART INFORMATION  
ON THIS SURFACE PER NOTE: 3

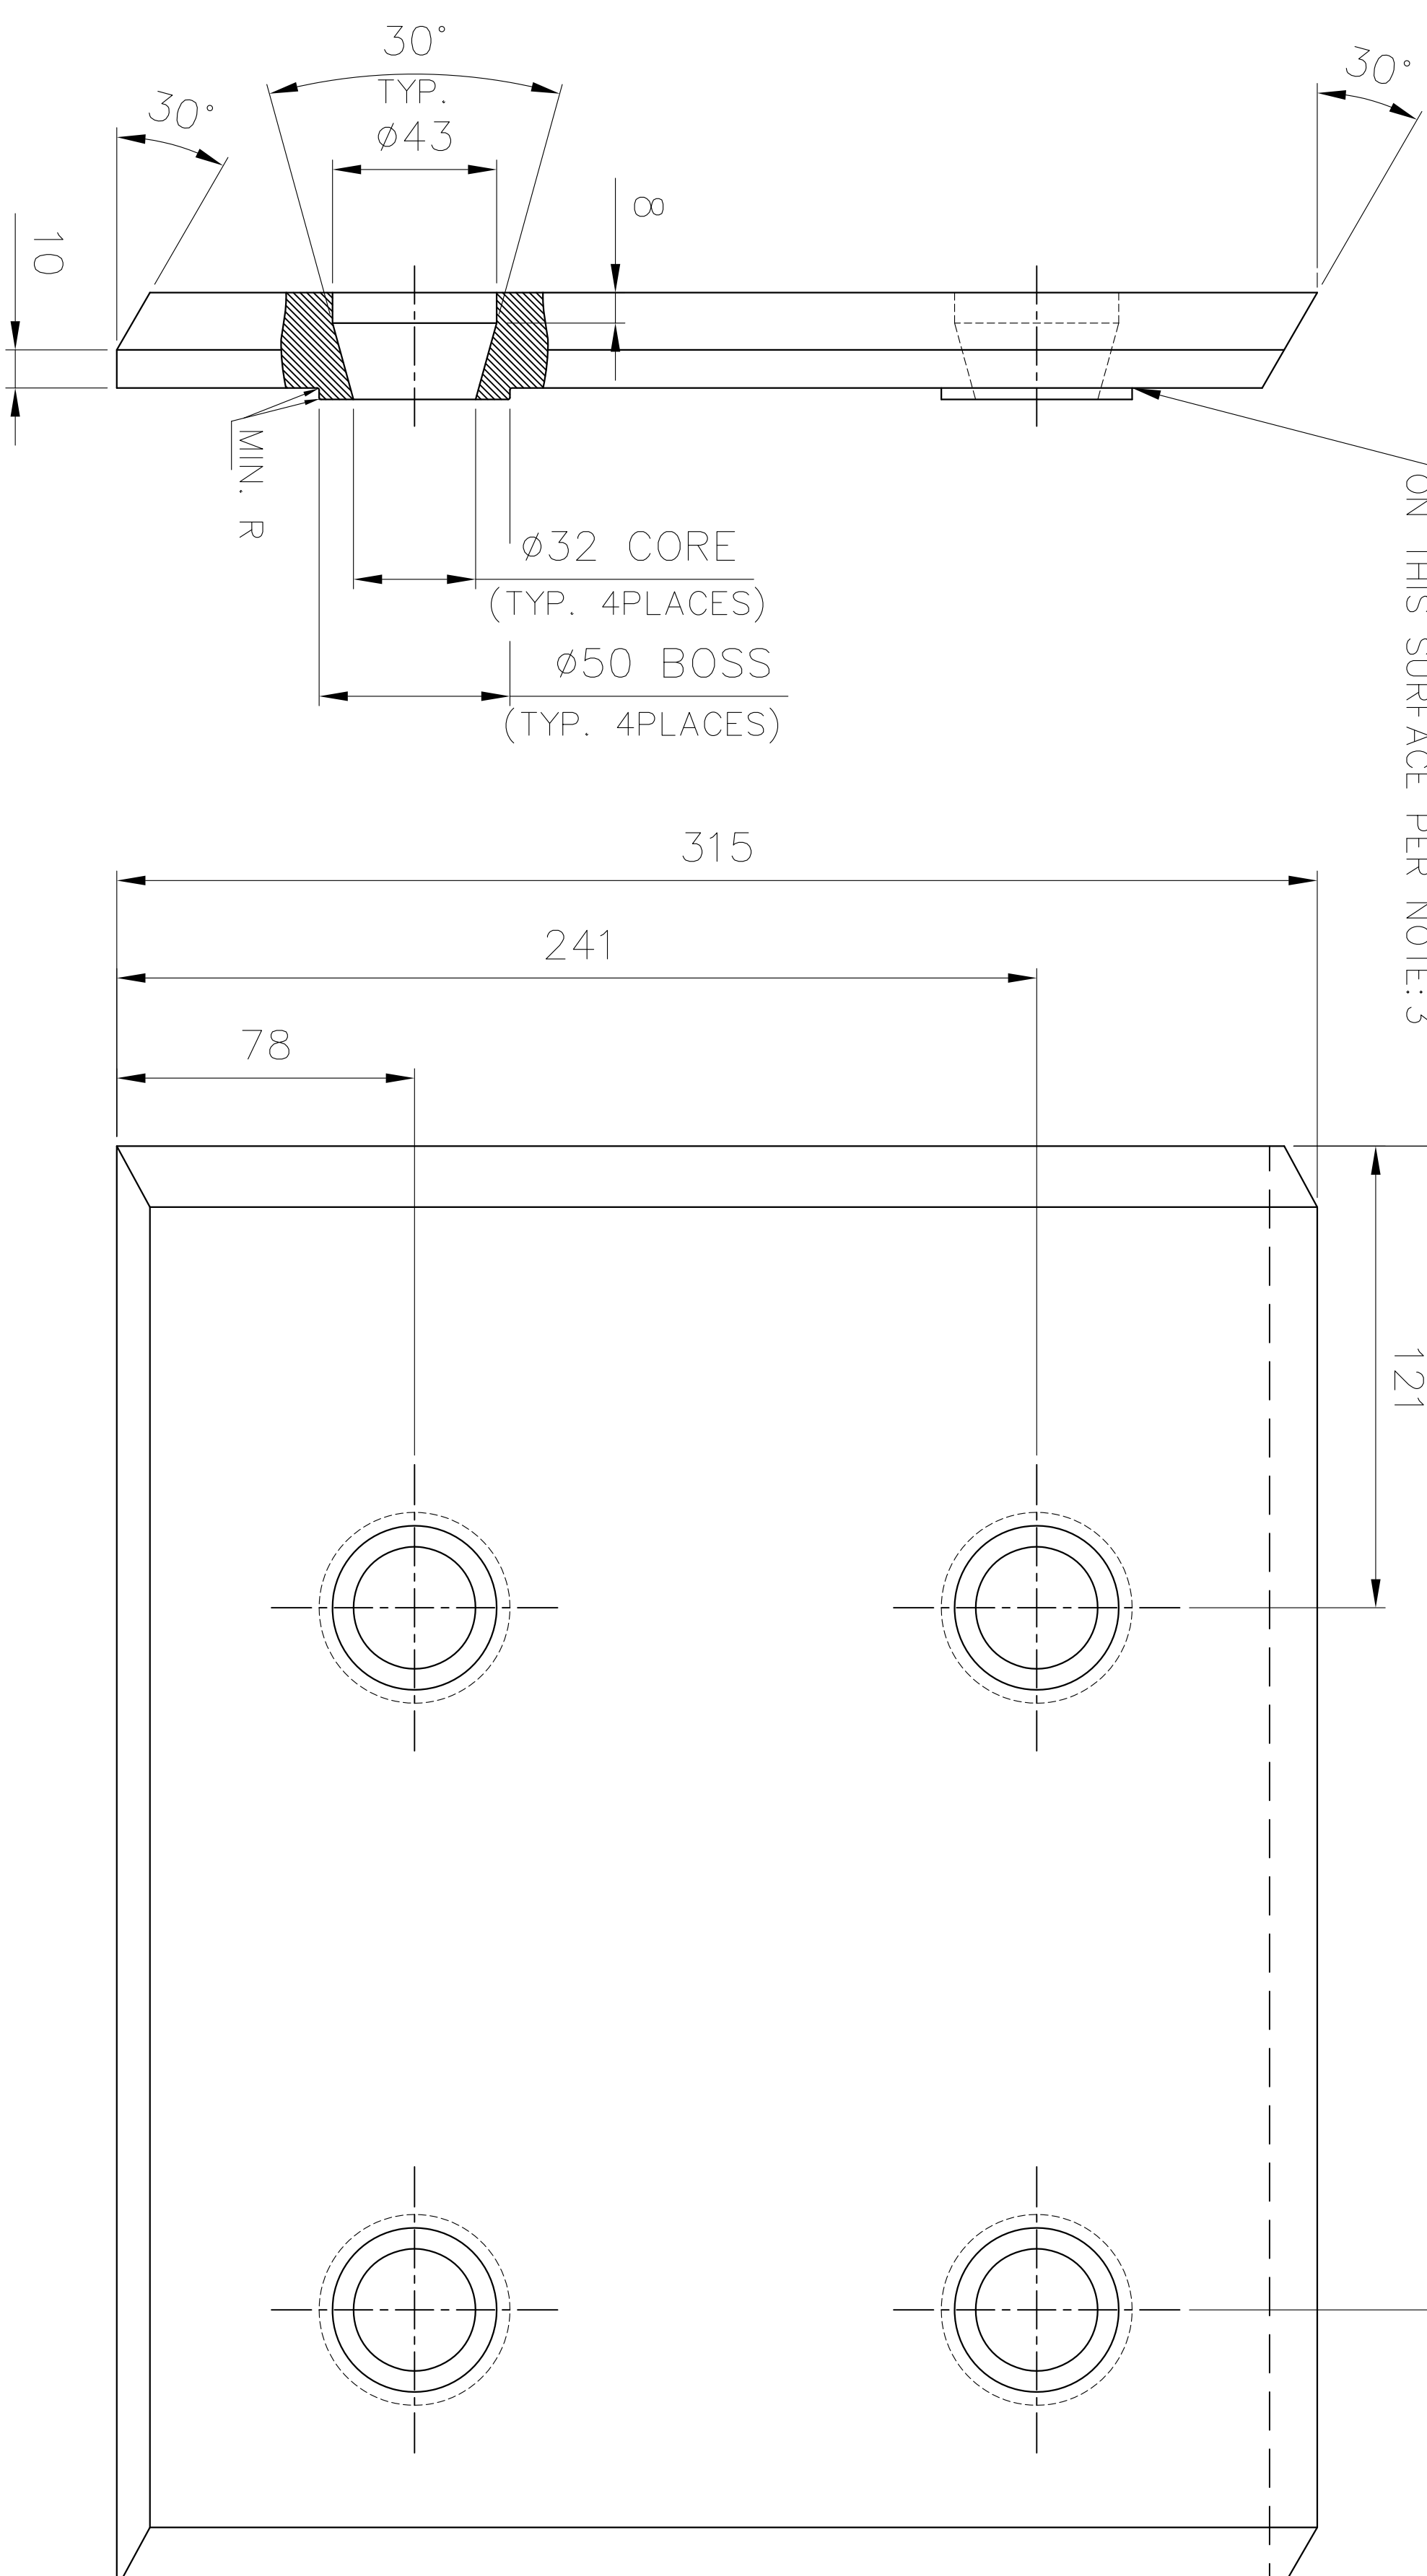

NOTES:

1. FOLLOWING INFORMATION TO BECAST INTO PART USING 3MM MAX. HEIGHT LETTERS: 26130402344.
2. BREAK ALL SHARP EDGES AND CORNERS UNLESS OTHERWISE NOTED.
3. TOLERANCES UNLESS OTHERWISE NOTED:  
CASTING:  $\pm 1.6$   
ANGULAR  $\pm 0.1^\circ$

01	CASTING			RAW MATERIAL SIZE OR CASTING DRG. NO. OR FORGING DRG. NO.	BA9114135540	23.00	23.00
					AA19741	1	
					MATERIAL CODE	NET WT.	GROSS WT.
ITEM NO.	DESCRIPTION	DRAWING NO.	VAR. NO.		MATERIAL SPECN.	QUANTITY	


TYPE OF PRODUCT		NAME OF CUSTOMER/PROJECT		NO.OF	
				VAR.	
	BHARAT HEAVY ELECTRICALS LIMITED	DRN.	NAME	SIGN.	DATE
	HYDERABAD	CHD.	EOL		15.07.93
		N.D.S			16.07.93
	APPD.Y.S.B.L.RAO				16.07.93

THE FOLLOWING CONDITIONS APPLY  
EXCEPT OTHERWISE STATED.

1. REF. TO HY0230261 FOR UNSPECIFIED TOLERANCES.
2. CHAMFER M/CD. SHARP EDGES 1.2 TO 1.0 AT 45°.

INTERNAL M/CD. CORNER RADI 1 TO 0.7

[illegible]

DEPT. PULV. ENGG	INTOL. DIMS. GR.		SCALE	WEIGHT (KG)	REF. TO ASSY DRG.	ITEM NO.	NO. OF ITEMS
	CODE 446		d/M/Y	1:2			
TITLE <b>JOURNAL OPENING FRAME LINER</b>					DRAWING NO. <b>2-61-304-02344</b>		
SHEET NO. 01		REV. 01					
		NO OF SHEETS 01					

1001

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1000

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7



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	C

INVENTORY NO. SIGN. AND DATE REF. DRG. NO. COMPUTER FILE NAME THE INFORMATION ON THIS DOCUMENT IS THE PROPERTY OF BHARAT HEAVY ELECTRICALS LIMITED. IT MUST NOT BE USED DIRECTLY OR INDIRECTLY IN ANY WAY DETRIMENTAL TO THE INTEREST OF THE COMPANY

FIRST ANGLE PROJECTION


(ALL DIMENSIONS ARE IN mm)

2-61-362-00714.DWG

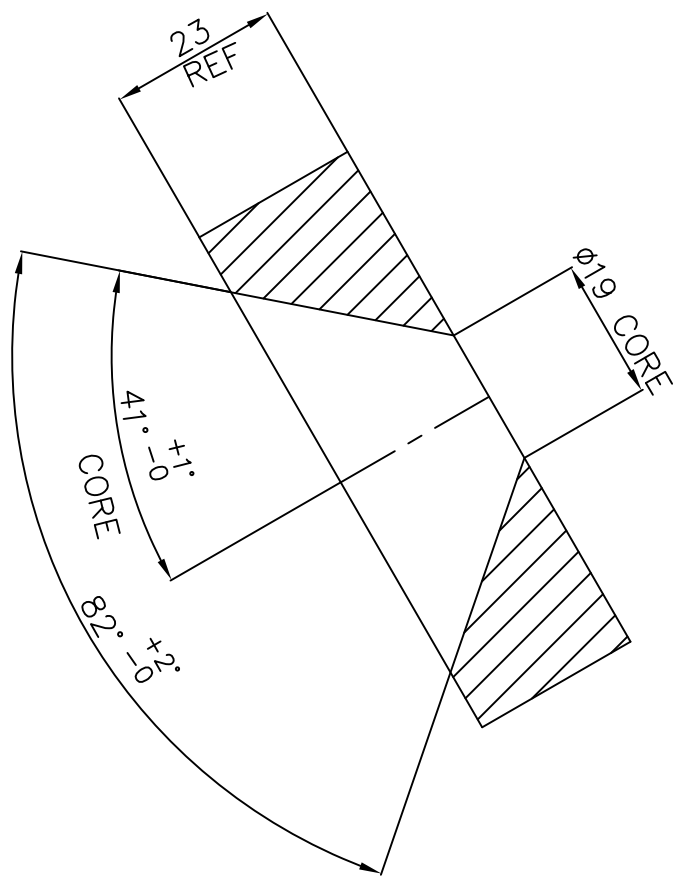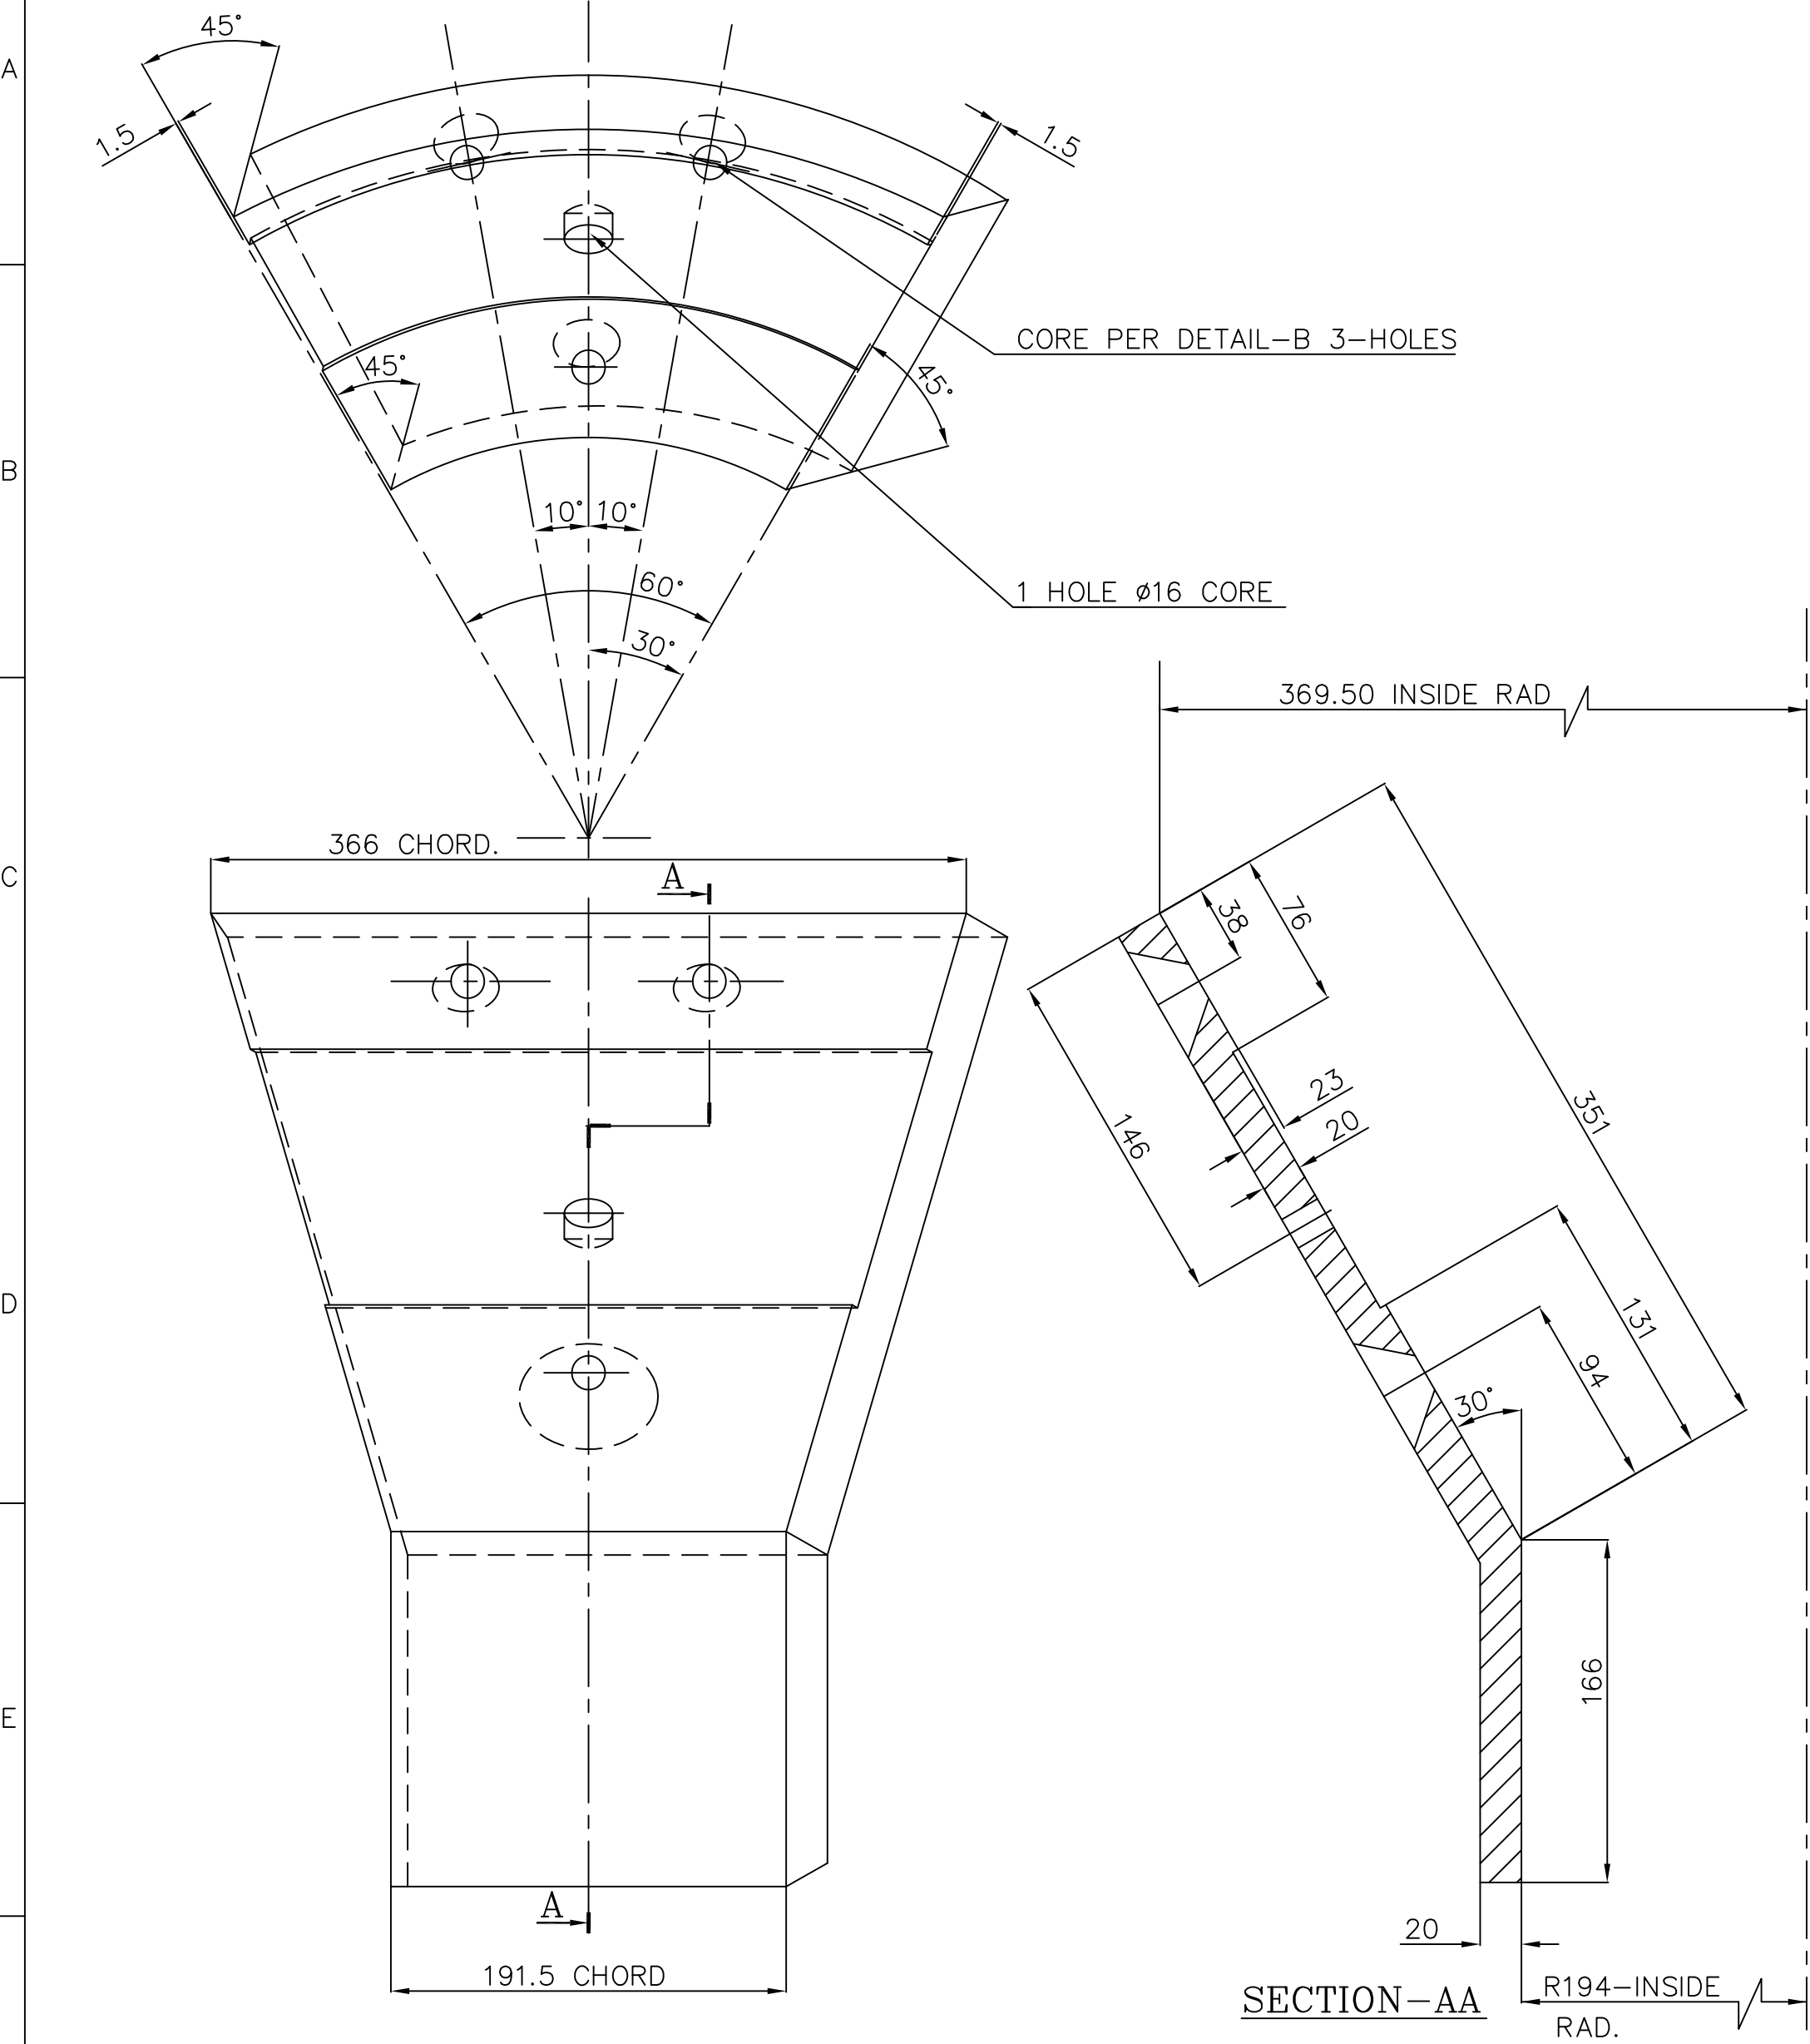

DETAIL-B

VAR-01

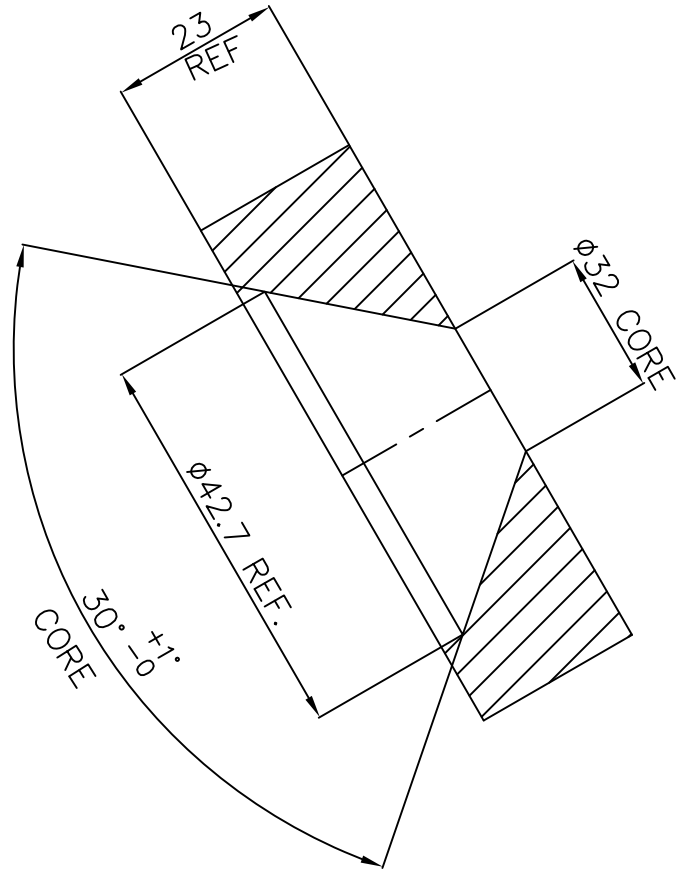

DETAIL-B

VAR-02

NOTE

1. BREAK ALL SHARP EDGES AND CORNERS UNLESS OTHERWISE NOTED,

01	CASTING		01		BA9114153513	21.8	
					AA19741		1
ITEM NO.	DESCRIPTION	DRAWING NO.	VAR. NO.	RAW MATERIAL SIZE OR CASTING DRG. NO. OR FORGING DRG. NO.	MATERIAL CODE	NET WT.	GROSS WT.
					MATERIAL SPECN.	QUANTITY	

THE FOLLOWING CONDITIONS APPLY EXCEPT OTHERWISE STATED.

- REF. TO HY0230261 FOR UNSPECIFIED TOLERANCES.
- CHAMFER M/CD. SHARP EDGES 1.2 TO 1.0 AT 45°.
- INTERNAL M/CD. CORNER RADII 1 TO 0.7
- THE SURFACE ROUGHNESS WHERE-EVER NOT SHOWN SHALL BE TAKEN FROM THE SURFACE ROUGHNESS SHOWN OUT SIDE THE BACK SLASH GIVEN OR THE TOP MOST RIGHT CORNER OF THE DRG.

TYPE OF PRODUCT

NAME OF CUSTOMER/PROJECT

623 XRPBM




BHARAT HEAVY ELECTRICALS LIMITED

HYDERABAD

DEPT. PULV ENGG. CODE 446

UNTOL. DIMS. GR. Ø/M/F

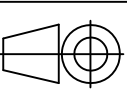

SCALE 1:3

WEIGHT (KG) 21.8

NAME	SIGN.	DATE	NO.OF VAR.
RAZVI		19.11.02	
NDSAMUEL		19.11.02	
S.GHATGE		19.11.02	

TITLE

INNER CONE SPOUT SEGMENT

DRAWING NO.	REV.
2-61-362-00714	03.A
SHEET NO. 01	NO OF SHEETS 01

INVENTORY NO.

REF.DRG.NO.

COMP. FILE NAME  
26100715.DWG

THE INFORMATION ON THIS DOCUMENT IS THE PROPERTY OF BHARAT HEAVY ELECTRICALS LIMITED. IT MUST NOT BE USED DIRECTLY OR INDIRECTLY IN ANY WAY DETRIMENTAL TO THE INTEREST OF THE COMPANY.

FIRST ANGLE PROJECTION

(ALL DIMENSIONS ARE IN mm)

POORNIMA CAD

DRG.NO. 2-61-362-00715

23

34

45

56

67

78

89

TOP

72

115

115

25

63.5

71

32

25

32

25

15

3

ø8

450

LINE OF TANGENCY

36°

9°30'

W.P

W.P (WORKING POINT)

30.5 REF.

10

18

50°30'

35.5

REF.

REF.

R73

R55

CURVE AT TOP

CURVE AT BOTTOM

141

31

46.35

25

03

04

05

05

04

03

02

01

REV.

DATE

ALTERED

CHECKED

APPD.

REV.

DATE

ALTERED

CHECKED

APPD.

REV.

DATE

ALTERED

CHECKED

APPD.

REV.

DATE

ALTERED

CHECKED

APPD.

01

28.06.04

CHECKED

APPD.

ZONE

1

2

3

4

THE FOLLOWING CONDITIONS APPLY EXCEPT OTHERWISE STATED...

1. REF.TO HY0230261 FOR UNSPECIFIED TOLERANCES.

2. CHAMFER M/CD SHARP EDGES 1.2 TO 1.0 AT 45°.

3. INTERNAL M/CD CORNER RADII 1 TO 0.7.

4. THE SURFACE ROUGHNESS WHEREVER NOT SHOWN SHALL BE TAKEN FROM THE SURFACE ROUGHNESS SHOWN OUT SIDE BACK SLASHES GIVEN AT THE TOP MOST RIGHT CORNER OF THE DRG.

TYPE OF PRODUCT OR NAME OF CUSTOMER/PROJECT

DEPT.

PULV-ENG

CODE

4460

SCALE

1:1

WEIGHT(Kg)

3.880

REF. TO ASSY DRG.

NA

ITEM NO.

NA

NO.OF ITEMS

NA

TITLE

DEFLECTOR ASSEMBLY

DRAWING NO.

2-61-362-00715

REV.

01

SHEET NO.

01


NO OF SHEETS

01

TD-150/REV.NO.03

SIZE A2

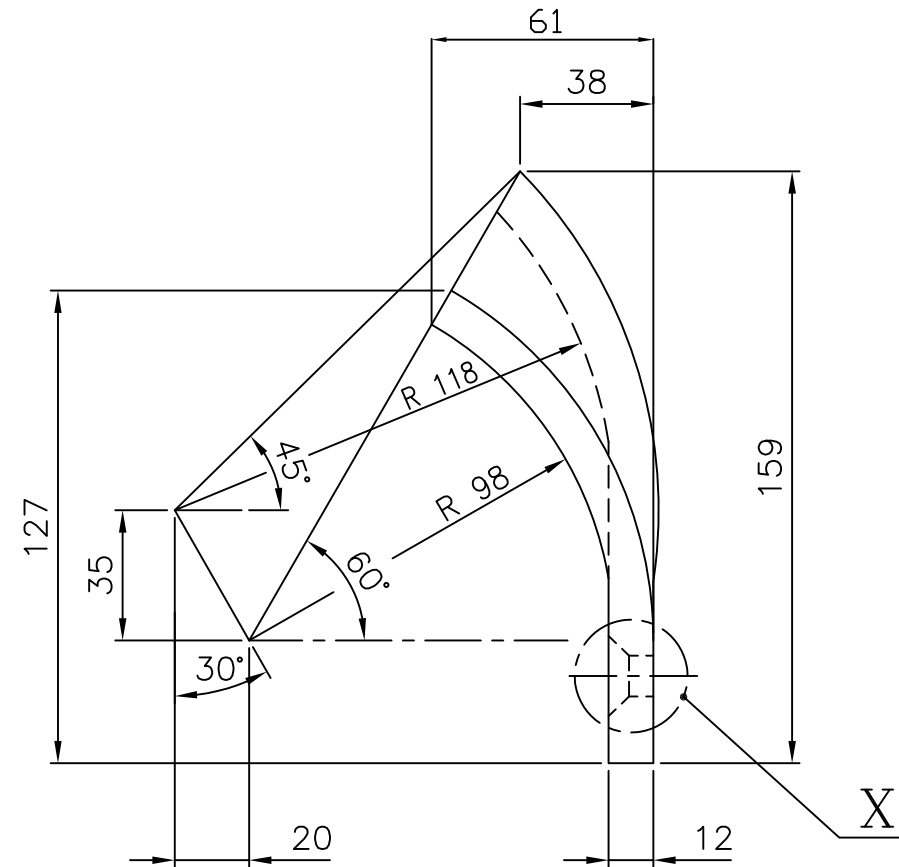

GENERAL DIMENSIONAL LIMITS, FITS & TOLERANCES AS PER HY0230261		D	C
F7			



01. MATERIAL: ~~— ALLOY CASTING CE CROWN 700.~~

02. PATTERN No. 2-61-370-00880.

03. BREAK ALL SHARP EDGES AND CORNERS  
UNLESS OTHERWISE SPECIFIED.

THE FOLLOWING CONDITIONS APPLY EXCEPT OTHERWISE STATED.  1. REF. TO HY0230261 FOR UNSPECIFIED TOLERANCES.  2. CHAMFER M/CD. SHARP EDGES 1.2 TO 1.0 AT 45°.  3. INTERNAL M/CD. CORNER RADII 1 TO 0.7  4. THE SURFACE ROUGHNESS WHERE-EVER NOT SHOWN SHALL BE TAKEN FROM THE SURFACE ROUGHNESS SHOWN OUT SIDE THE BACK SLASH GIVEN ON THE TOP MOST RIGHT CORNER OF THE DRG.	TYPE OF PRODUCT							
	NAME OF CUSTOMER/PROJECT							
		BHARAT HEAVY ELECTRICALS LIMITED  HYDERABAD		DRN.	NAME	SIGN.	DATE	NO.OF VAR.
					UNIC		20.02.97	/  /  /
				CHD.	B.M.R		08.10.97	
				APPD.			08.10.97	
	DEPT. PULV ENGG CODE 446	UNTOL. DIMS. GR.  Q/M/φ		SCALE 1:2 1:1	WEIGHT (KG)  5.000	REF. TO ASSY DRG.  C-GP-3500/01		ITEM NO.  /
TITLE  <u>DEFLECTOR BLADE</u>				CARD CODE  UD-1	DRAWING NO.  2-61-370-00880			REV.  03
				SHEET NO. 01		NO OF SHEETS 01		





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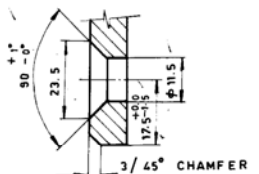
FIRST ANGLE PROJECTION (ALL DIMENSIONS IN MILLIMETRES)

2-61-376-00706


DRAWING NO.

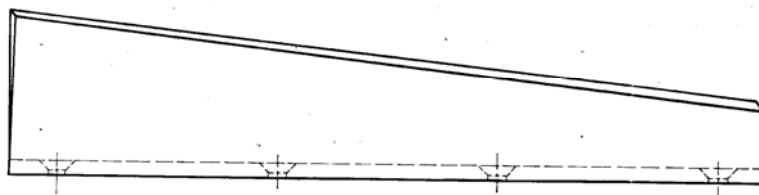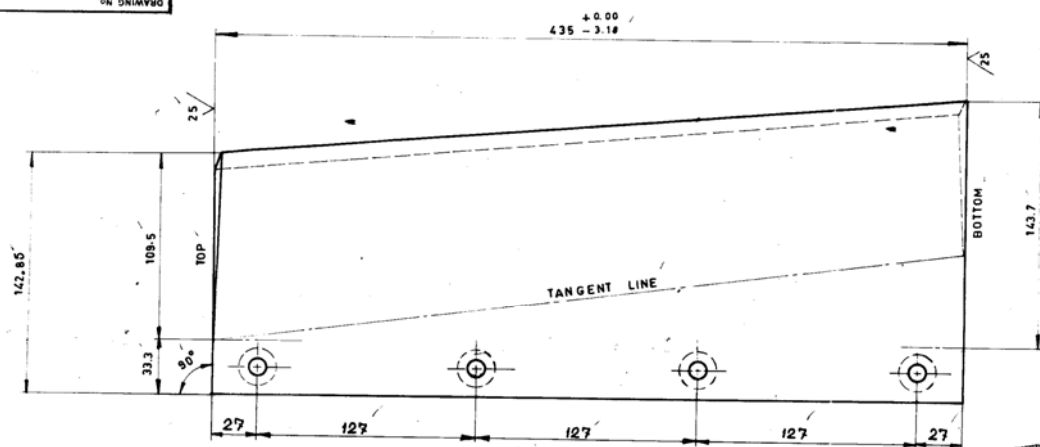

NOTE:-  
BREAK ALL SHARP EDGES AND  
CORNERS UNLESS OTHERWISE NOTED.



DETAIL - A

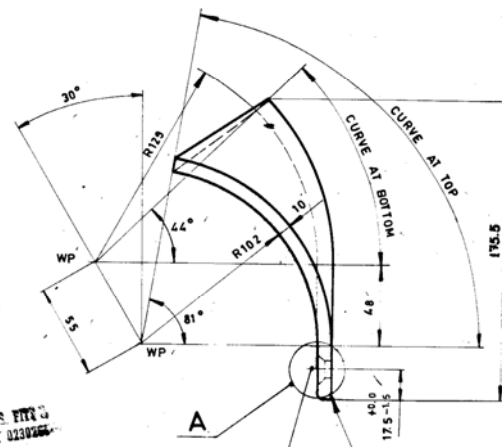

GENERAL DIMENSIONS, LIMITS, FITS &  
TOLERANCES AS PER PS. HY 023025

4 CORED CSK HOLES AS SHOWN  
IN DETAIL - 'A'


ENSURE THE FLATNESS ON THE  
STRAIGHT PORTION ON THE  
CASTING

[illegible]TYPE OF PRODUCT  
OR NAME OF  
CUSTOMER/PROJECT

**Bharat Heavy Electricals Ltd.,**  
BOILER PLANT UNIT  
TIRUCHIRAPALLI-620 014

DRN	NAME	SIGN	DATE	NO. G VAR
	EC-002/WH	W. W. Lh.	29-11-85	
END	T. SOOSAKUTHA	<i>[Signature]</i>	29-11-85	

REV 01	DATE 25-9-86	ALTERED S. SHANKAR
ZONE BI		CHECKED Y. S. R.
		MAT. SPEC. WAS NIHARD. MAT. CODE ADDED.

DEPT	GRADE OF		SCALE	WEIGHT (kg)	REF TO ASSY / OLD DRG	ITEM NO.
MILLS	UNTOL DIM		1:2			
CODE	4/M/P		1:1	6.200	2-61-176 - 00357	02

TITLE		CARD CODE	DRAWING NO.	REV.
DEFLECTOR BLADE		U 01	2-61-376-00706	01

CORE CODE NO 61380186

EC-002 Size A2

12020-888-19-2

2 JO SH

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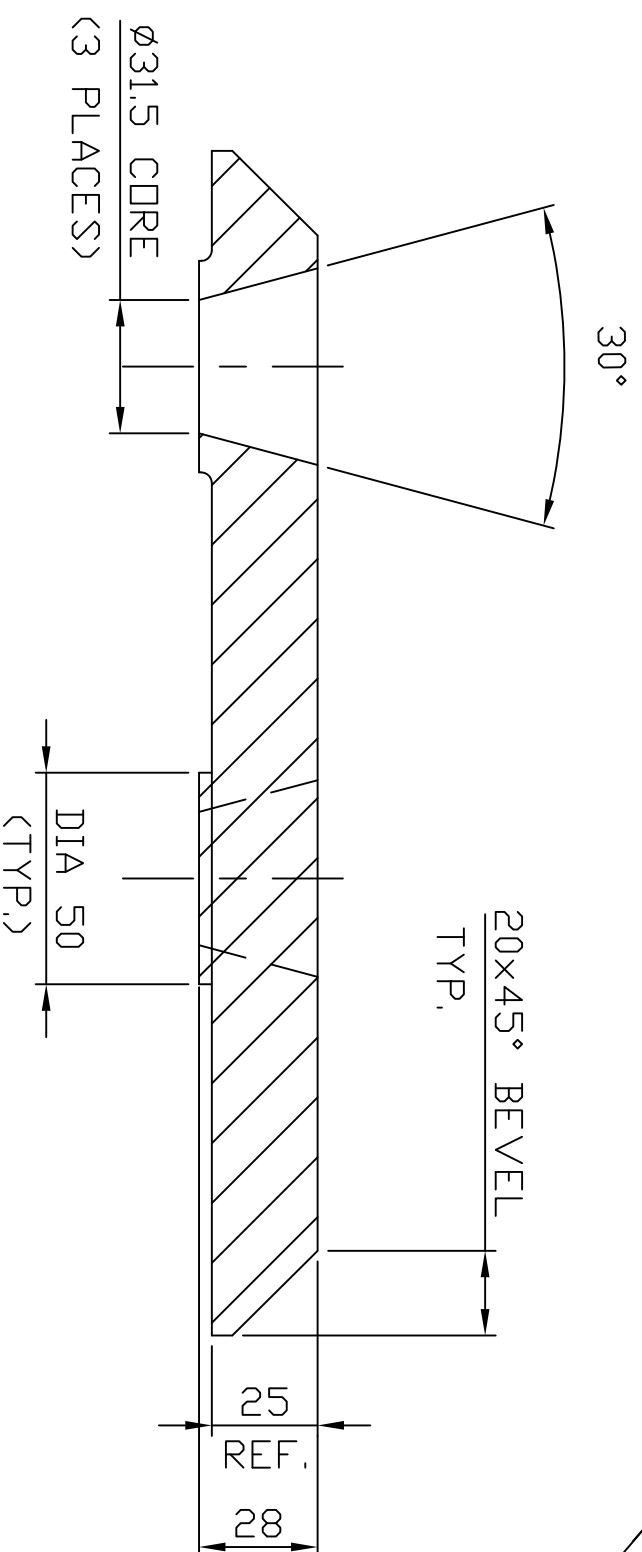
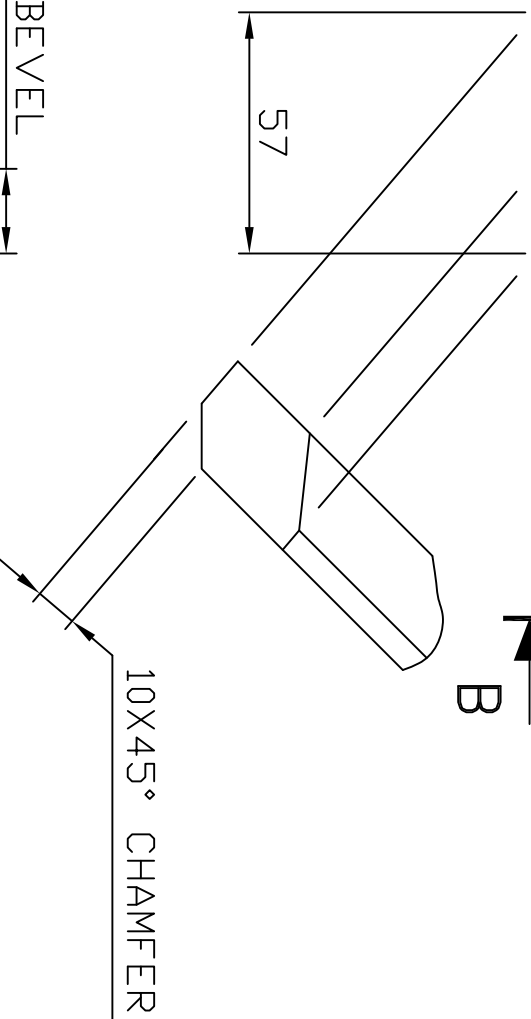
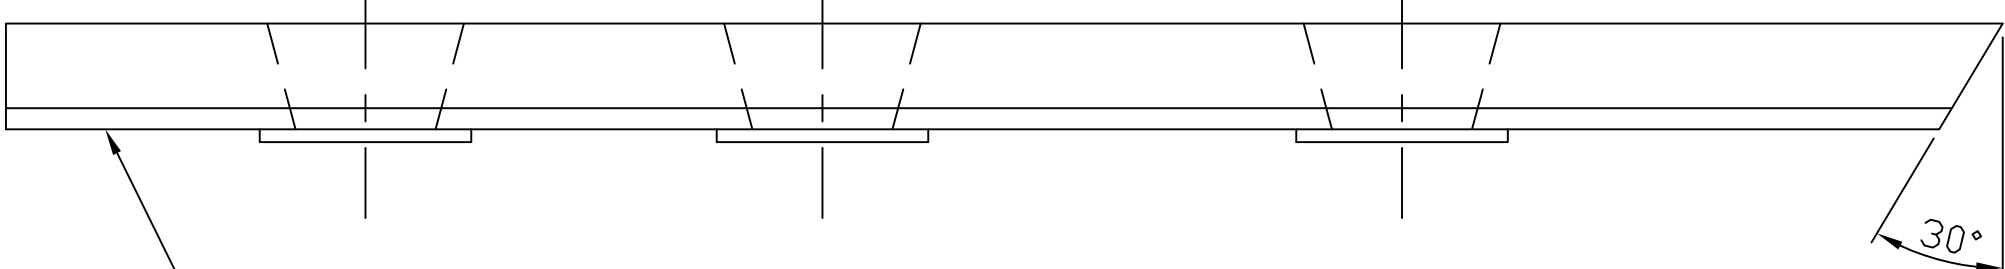
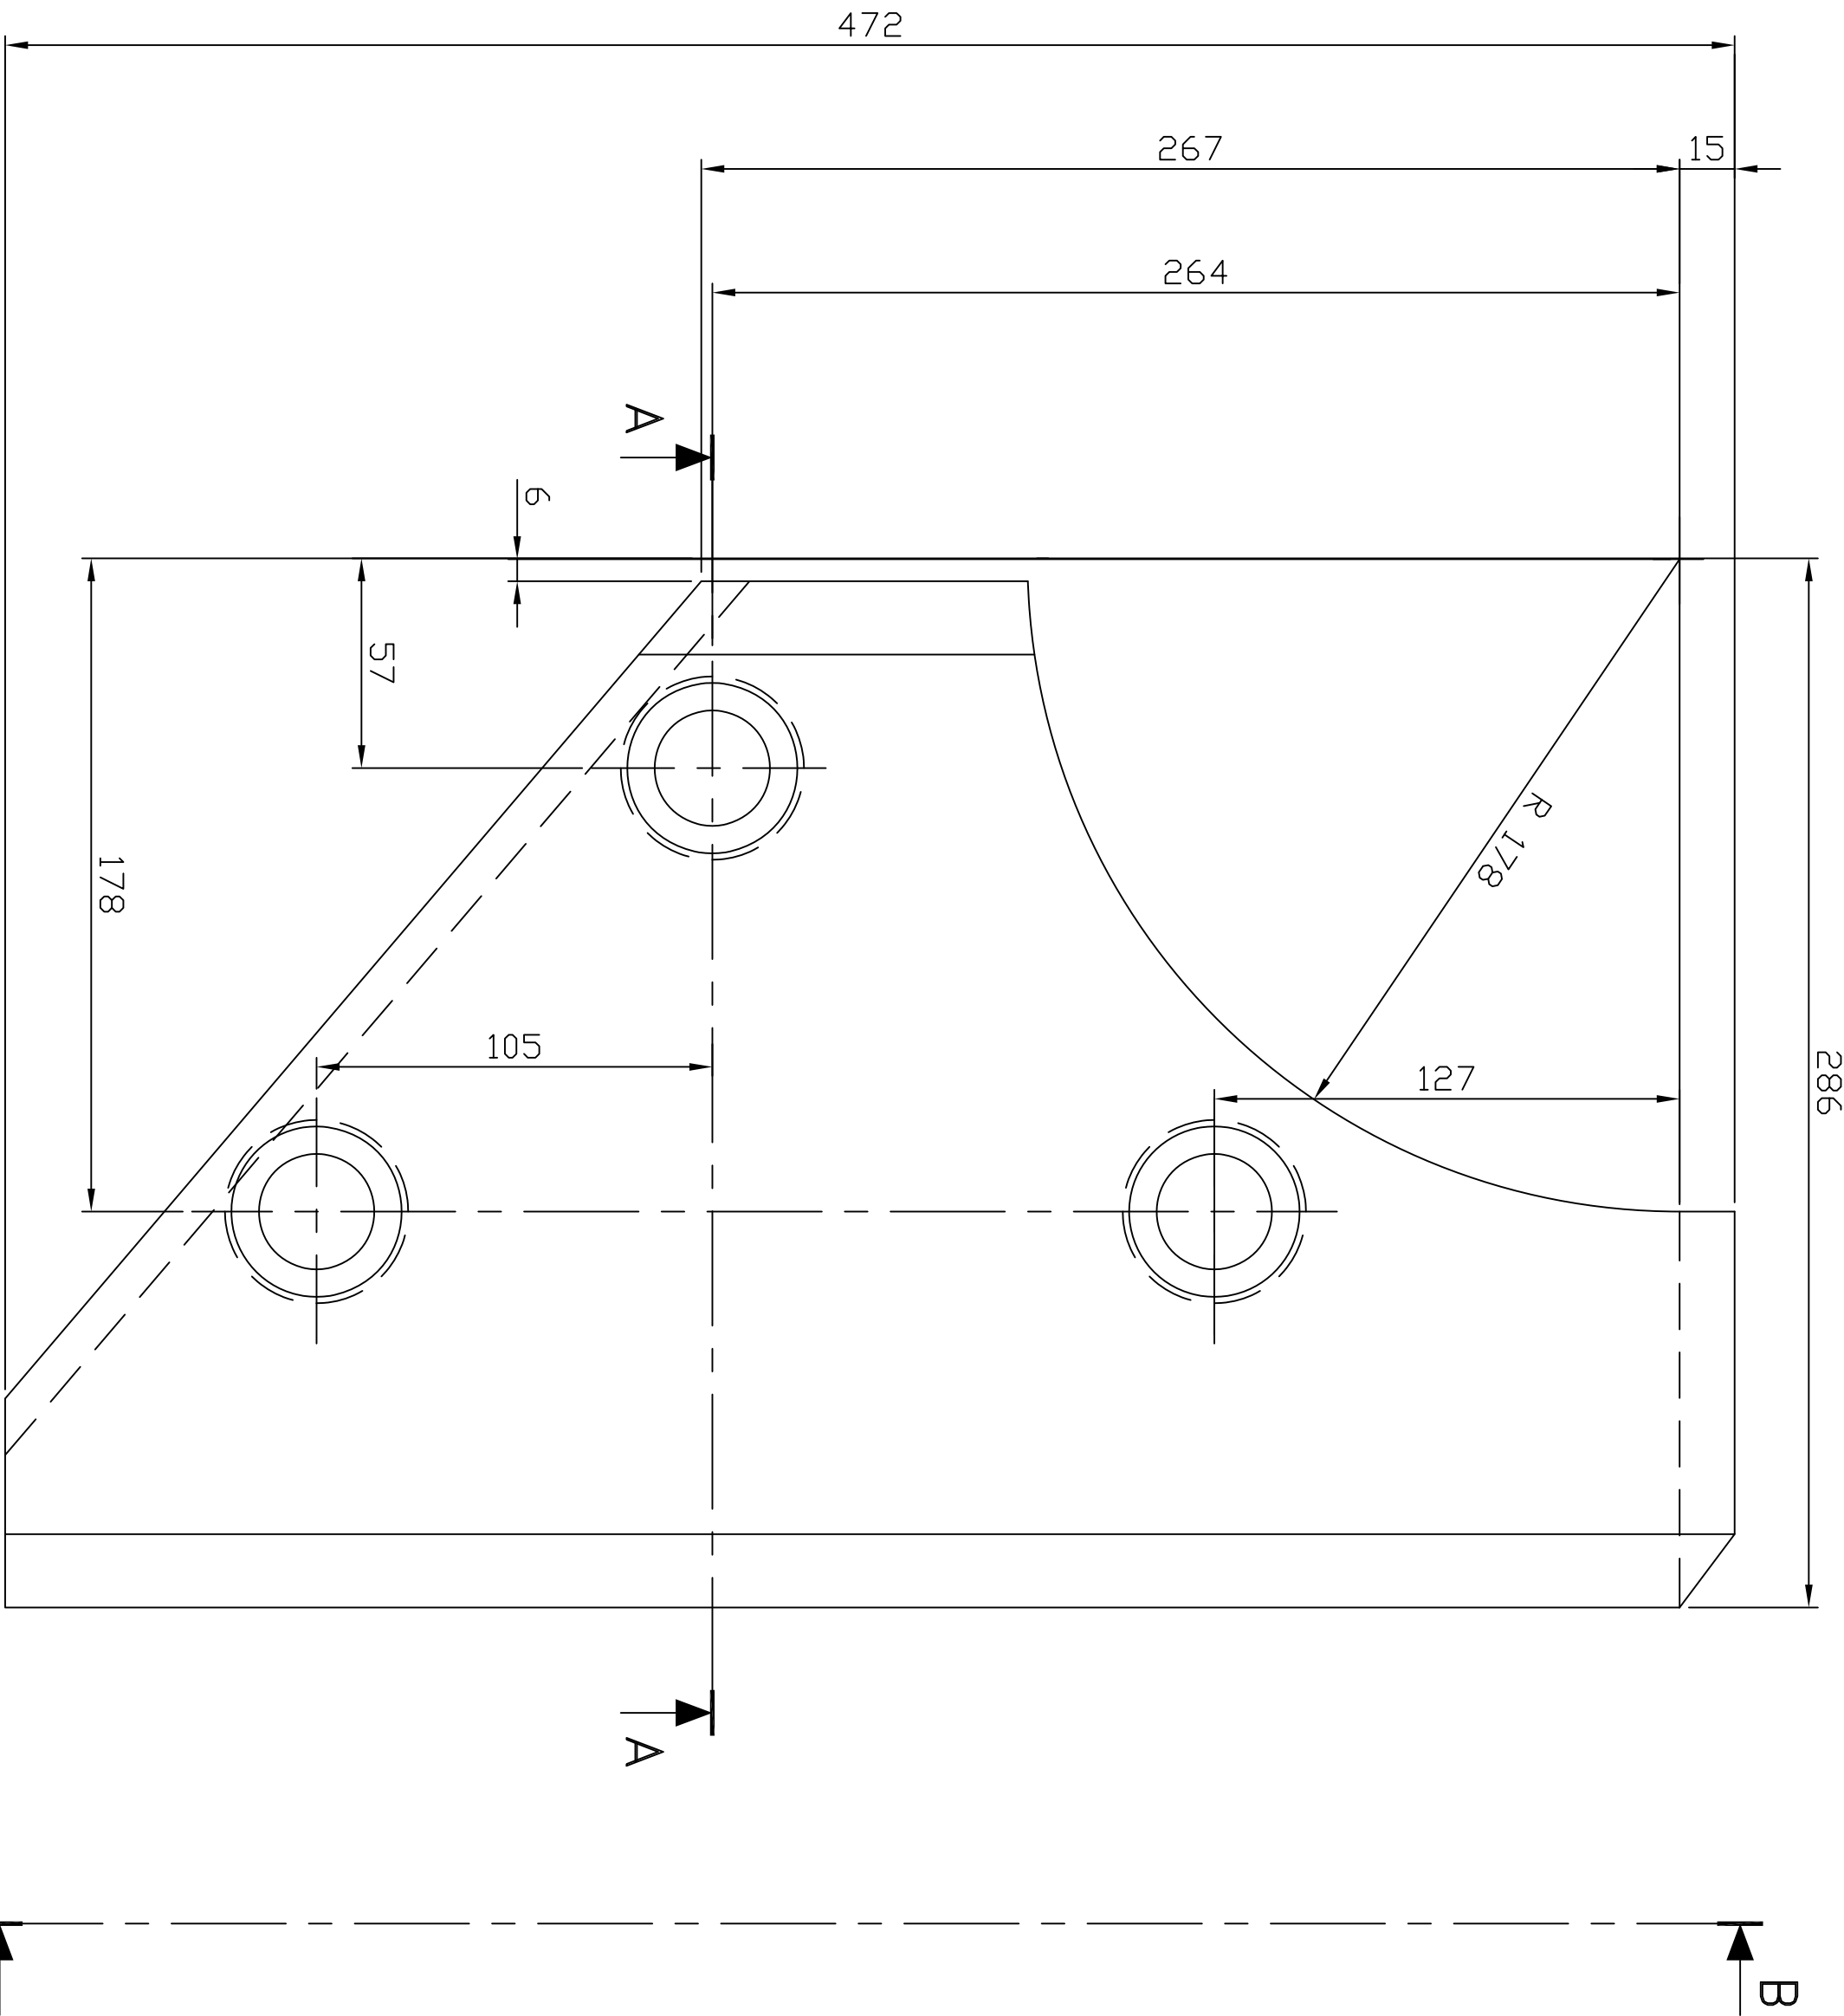
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CAST PART INFORMATION  
ON THIS SURFACE

NOTES:-

1. PATTERN No. 2-61-388-02031.
2. CASTING TOL. SHOULD BE WITHIN  
+0.0  
-1.6  
ANGULAR 0° 6'
3. BREAK ALL SHARP EDGES & CORNERS UNLESS OTHERWISE NOTED.

GENERAL DIMENSIONAL LIMITS,FITS & TOLERANCES AS PER HY0230261

INVENTORY NO		SIGN. AND DATE		REF. DRG. NO.		COMPUTER FILE NAME		THE INFORMATION ON THIS DOCUMENT IS THE PROPERTY OF BHARAT HEAVY ELECTRICALS LIMITED. IT MUST NOT BE USED DIRECTLY OR INDIRECTLY IN ANY WAY DETRIMENTAL TO THE INTEREST OF THE COMPANY																																																																																																																																																																																																																																																																																																																																																																																																																																																																																																																																																																																																																																																																																																																																																																																																																																																																																																																																																											
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22020-882-19-2 ON GRD

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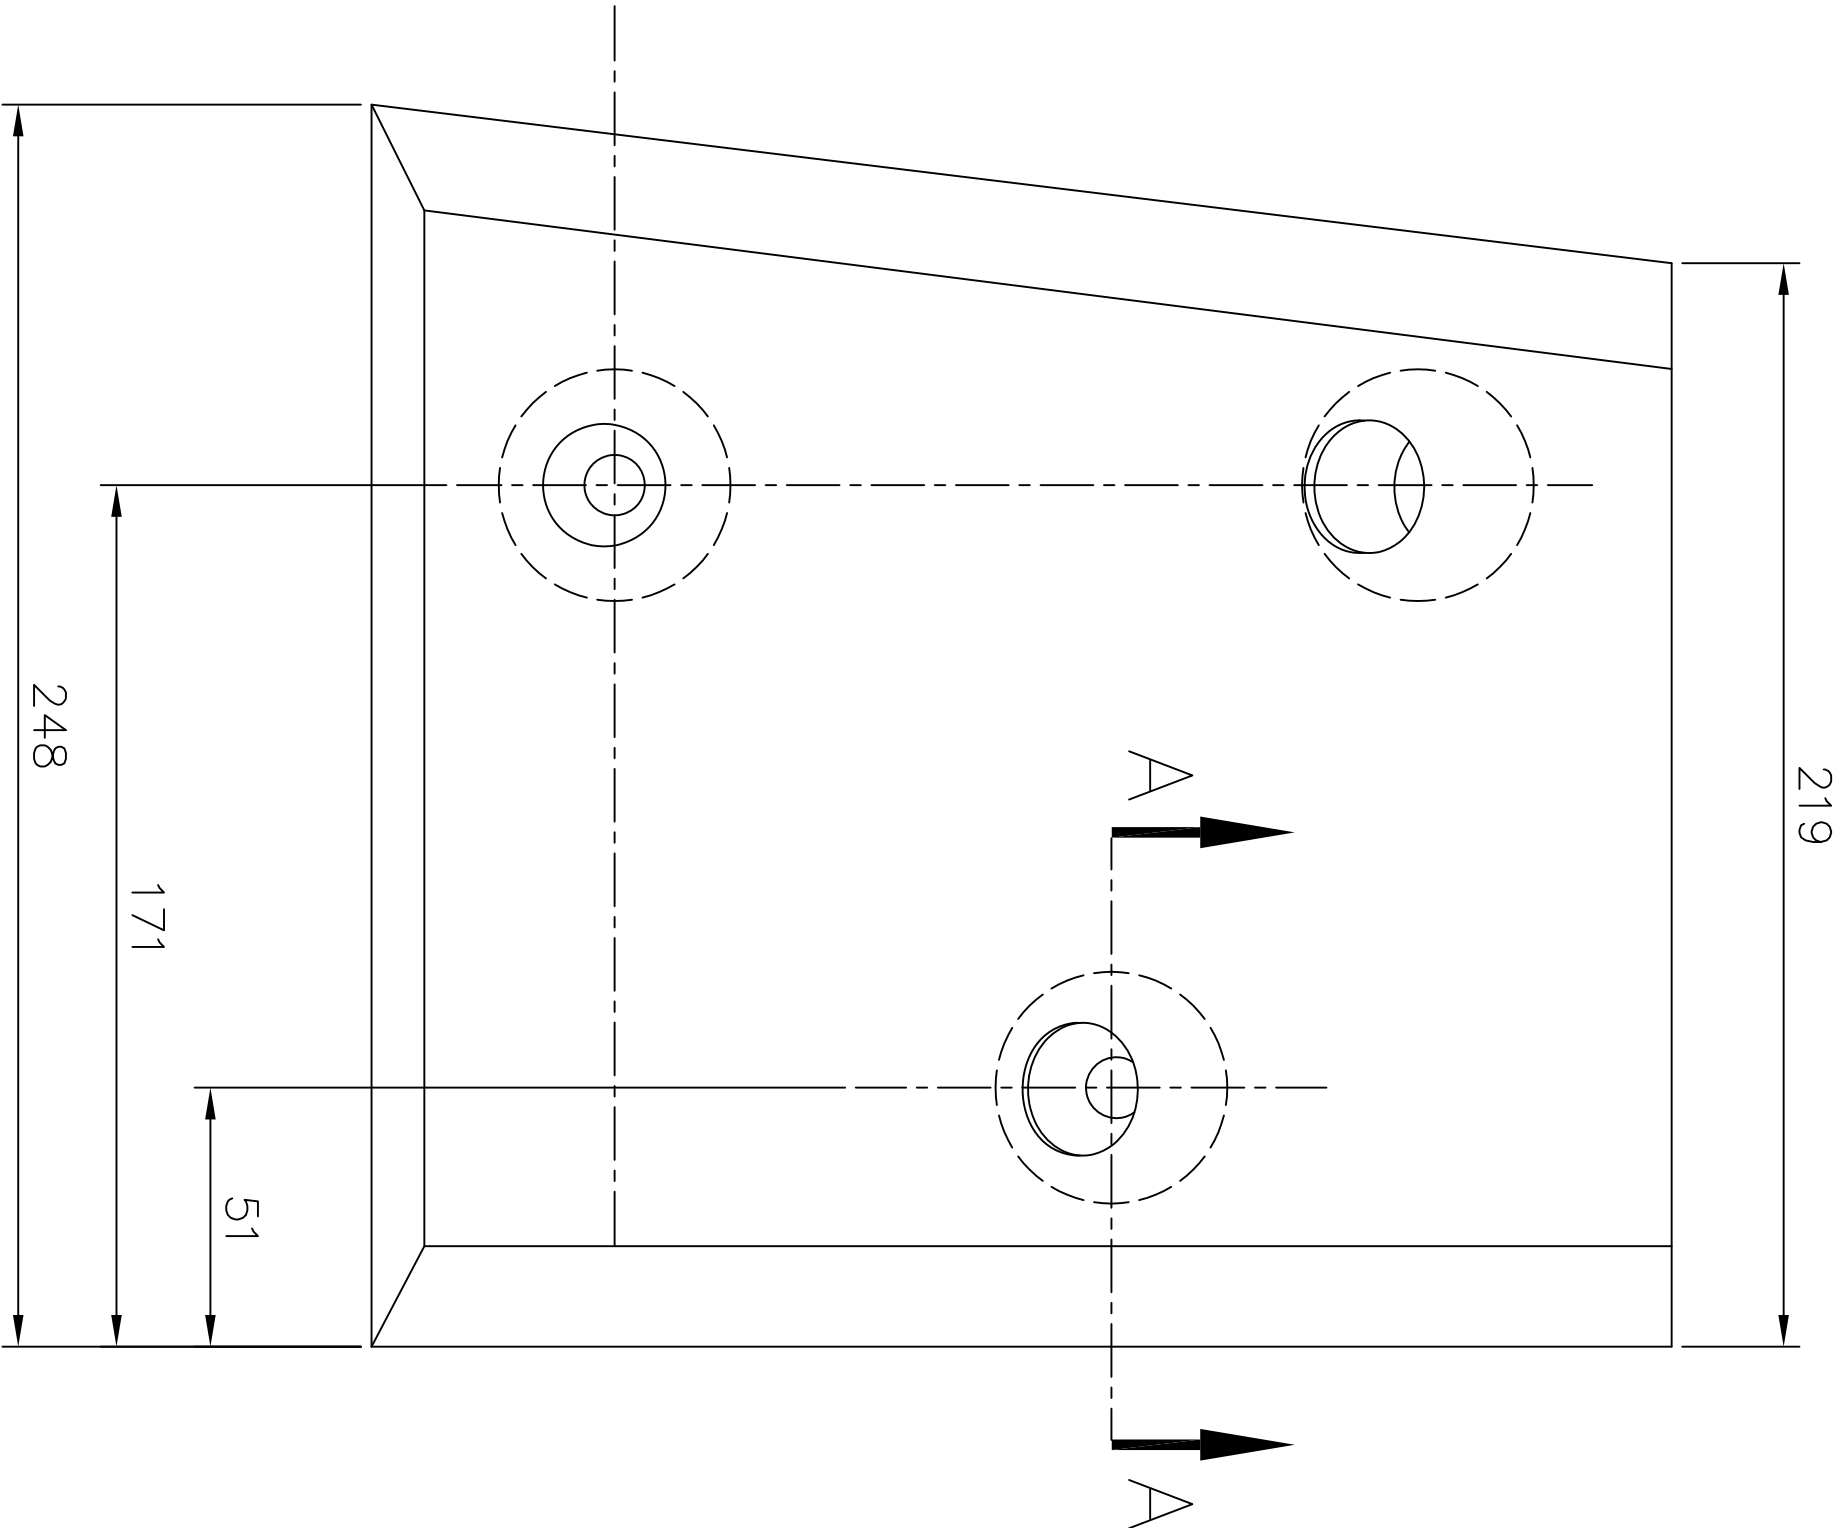
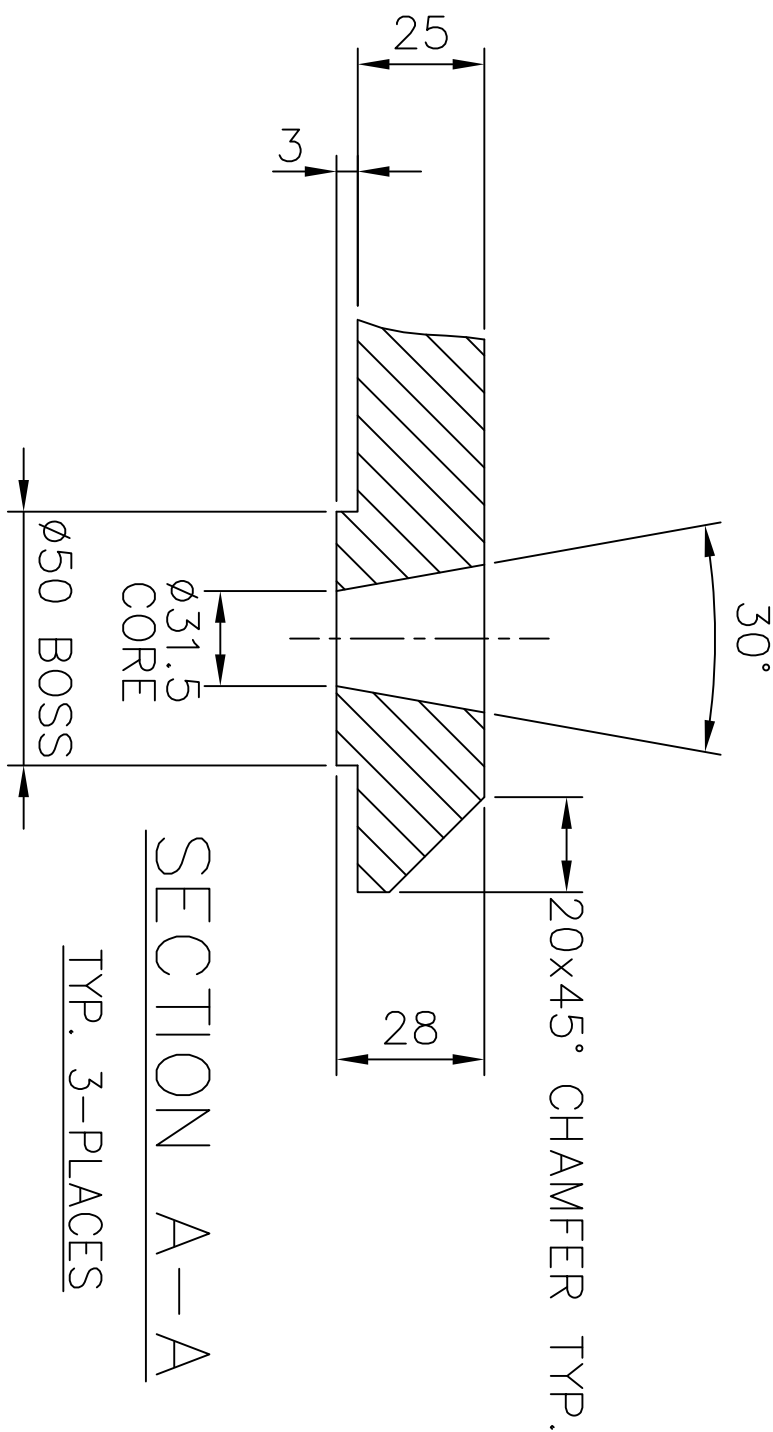
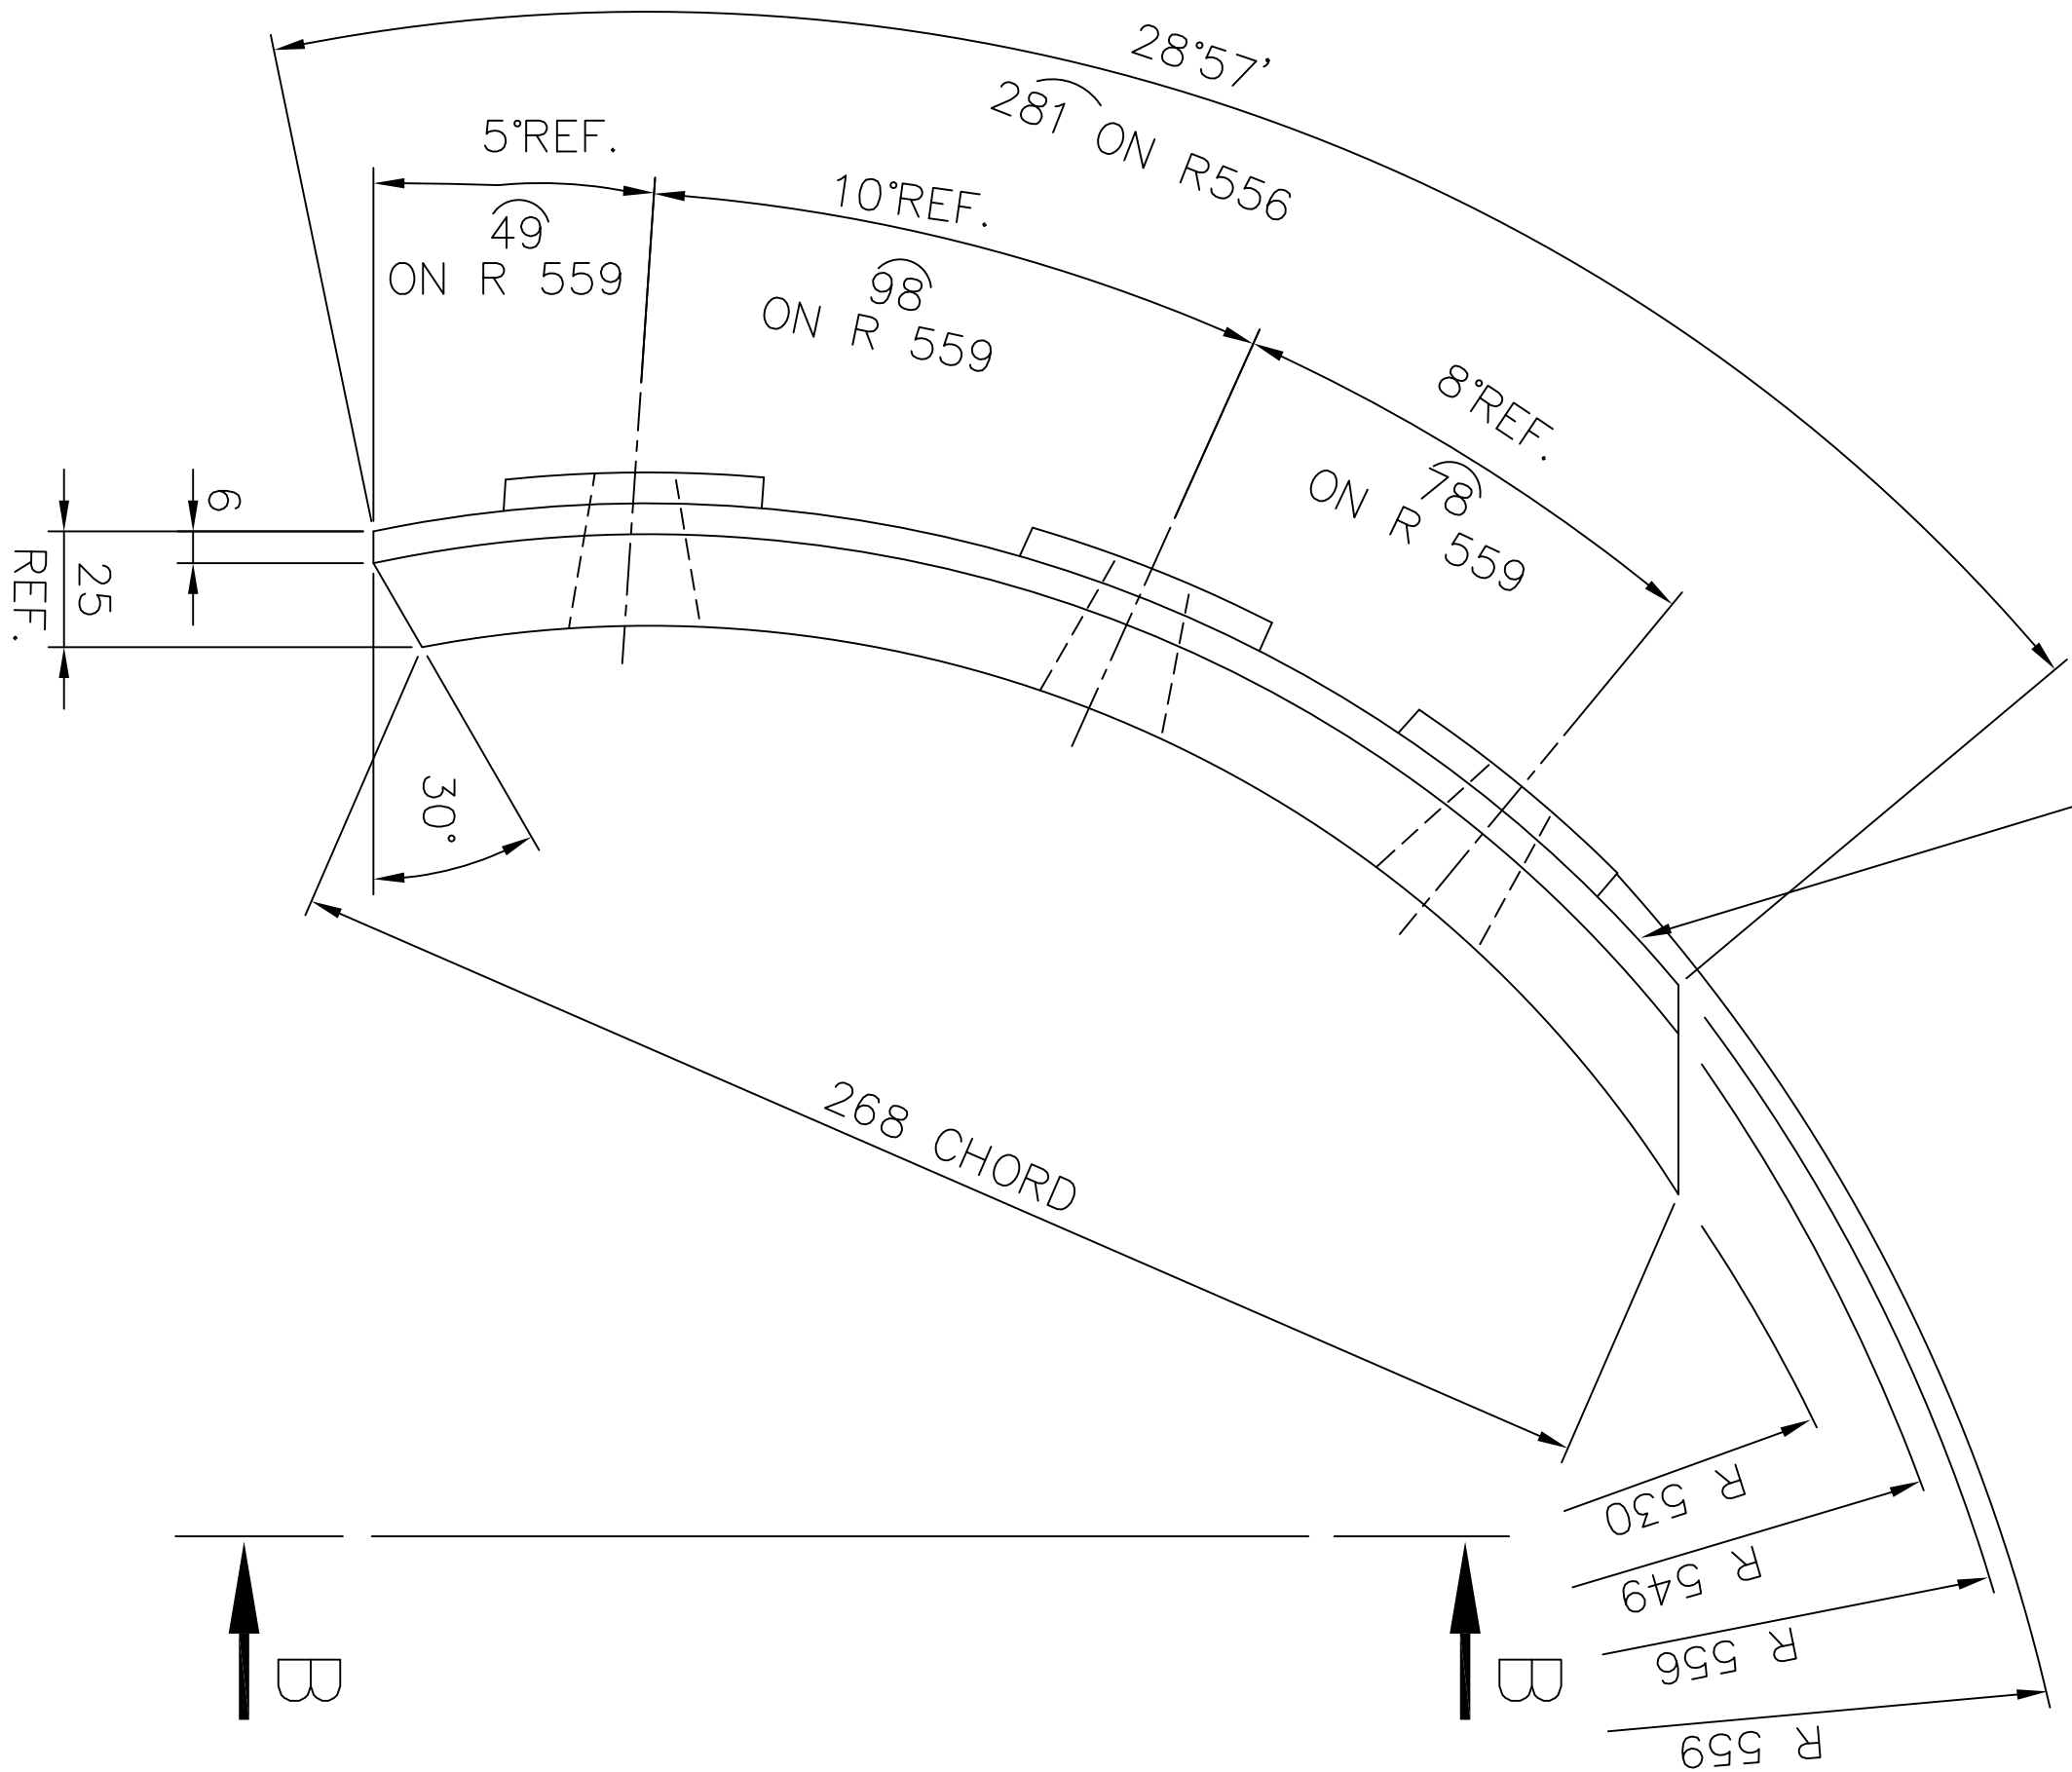
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CAST PART INFORMATION AT  
THIS SIDE WITH 10MM. HEIGHT  
OF RAISED LETTERS (SEE NOTE4)




VIEW B-B

NOTE:-

1. ALL RADII TO BE 1.5 UNLESS OTHERWISE SPECIFIED. +0.0 -1.6
2. CASTING TOL. SHOULD BE WITHIN ANGULAR 0.6°
3. PATTERN NO. 2-61-388-02033
4. CAST PART INFORMATION(VENDOR NAME,MELT NO.,HEAT NO., DRAWING NO.)ON THIS SURFACE

INVENTORY NO.		REF.DRG.NO.		COMP. FILE NAME		THE INFORMATION ON THIS DOCUMENT IS THE PROPERTY OF BHARAT HEAVY ELECTRICALS LIMITED. IT MUST NOT BE USED DIRECTLY OR INDIRECTLY IN ANY WAY DETRIMENTAL TO THE INTEREST OF THE COMPANY.											
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REV.		DATE		REV.		DATE		REV.		DATE		REV.		DATE		REV.	
ZONE		CHECKED		APPD.		CHECKED		APPD.		CHECKED		APPD.		CHECKED		APPD.	
1																	
2																	
3																	
4																	
5																	
6																	
7																	
8																	
REV.		DATE		REV.		DATE		REV.		DATE		REV.		DATE		REV.	
ZONE		CHECKED		APPD.		CHECKED		APPD.		CHECKED		APPD.		CHECKED		APPD.	
1																	
2																	
3																	
4																	
5																	
6																	



[illegible]

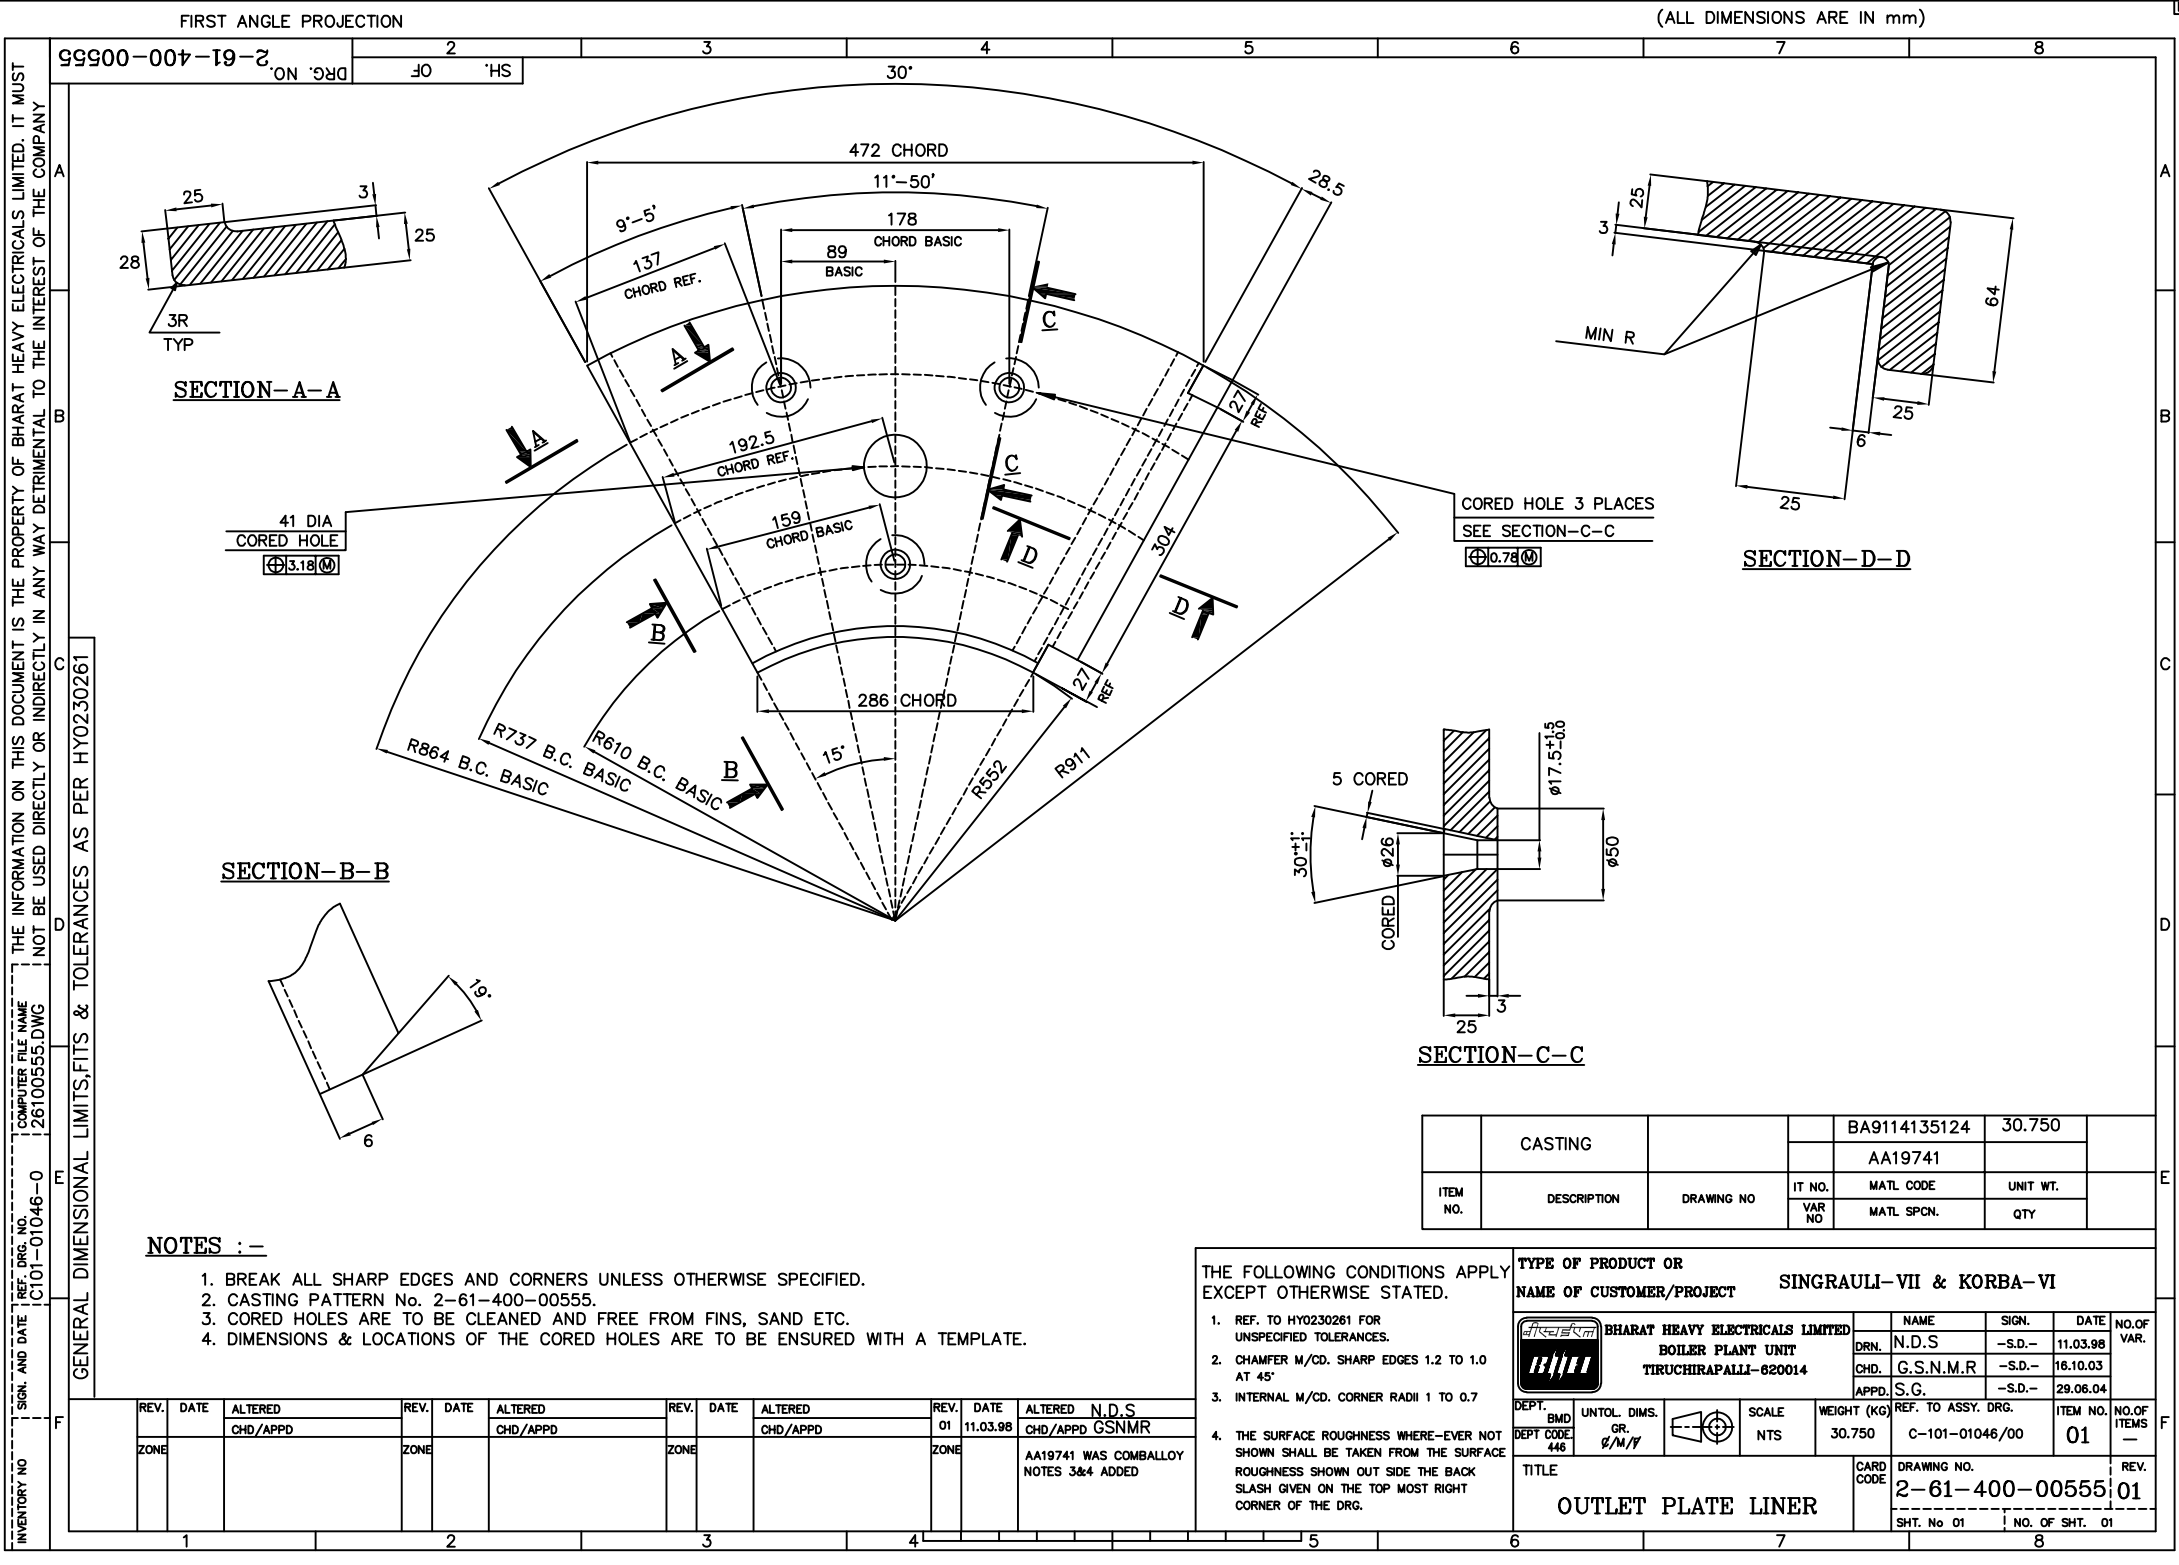


FIRST ANGLE PROJECTION

(ALL DIMENSIONS ARE IN mm)


DRG. NO. 2-61-400-02467

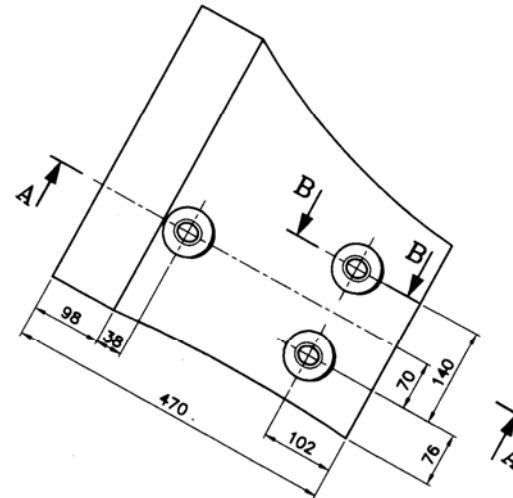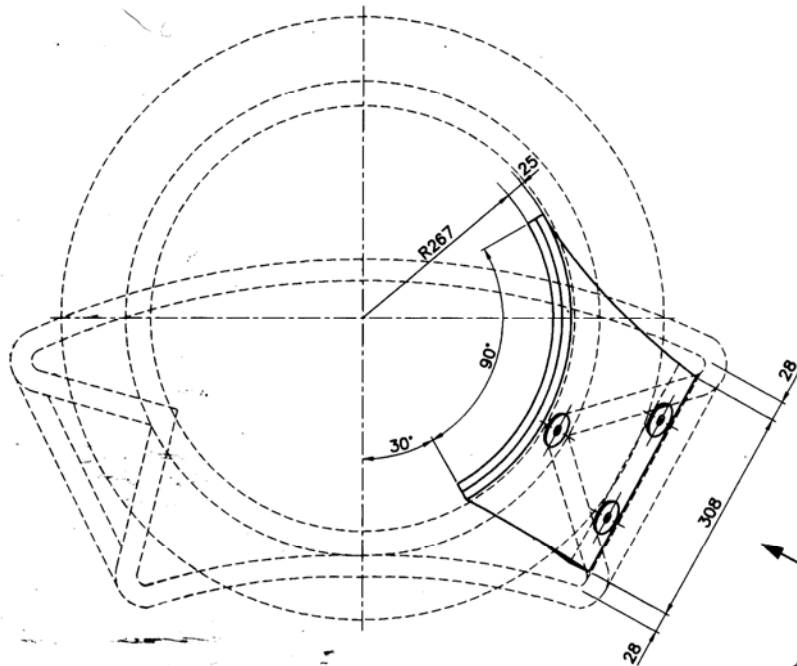

VIEW - C

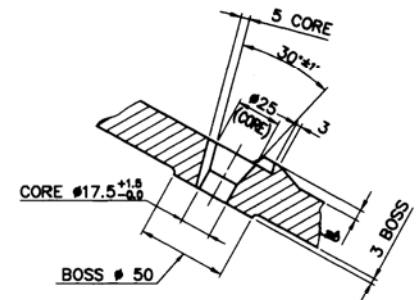


SECTION - BB

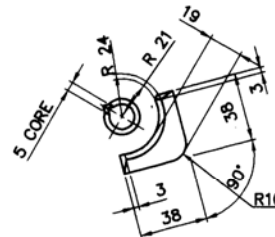

## NOTES: -

1. MAKE PATTERN SO THAT FINISHED LINER WILL CONFORM TO INSIDE SURFACE OF CASTING MULT. PORT OUTLET.
2. INSPECTION SHALL BE ON THE BASIS OF CONFORMITY TO CASTING MULT. PORT OUTLET DRG. NO. 1-61-400-00251 (RANDOM SELECTION)
3. CORED HOLES ARE TO BE CLEANED AND FREE FROM FINIS, SAND ETC.
4. DIMENSIONS & LOCATIONS OF THE CAST CORED HOLES ARE TO BE ENSURED WITH A TEMPLATE.
5. PATTERN NO - M-67-483 FOR NTPC SIMHADRI ONLY AND THE MATCHING M.P.O PATTERN NO IS M-67-710

3 TO 6 (MAX) SPACE BETWEEN  
LINER & OUTLET CASTING AT ANY  
POINT ON BACK SURFACE.

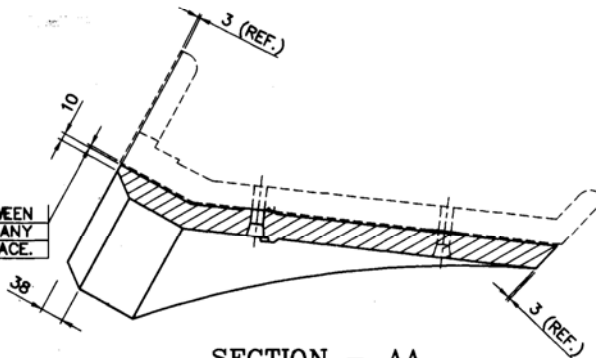


SECTION - AA

THE FOLLOWING CONDITIONS  
APPLY EXCEPT OTHERWISE  
STATED.

1. REFER TO HY0230281 FOR UNSPECIFIED TOLERANCES.
2. CHAMFER MACHINED SHARP EDGES 1.2 TO 1.0 AT 45°
3. INTERNAL MACHINE RADI 1 TO 0.7
4. THE SURFACE ROUGHNESS WHERE-EVER NOT SHOWN SHALL BE TAKEN FROM THE SURFACE ROUGHNESS SHOWN OUT SIDE THE BACKSLASH GIVEN AT THE TOP MOST RIGHT CORNER OF THE DRAWING.

CASTING		BA9114133393		35.00
ITEM NO.	DESCRIPTION	DRAWING NO.	MATL CODE	UNIT WT.
			MATL SPECN	QTY
TYPE OF PRODUCT OR NAME OF CUSTOMER/PROJECT		1003 XRP BOWL MILL		
BHARAT HEAVY ELECTRICALS LIMITED HYDERABAD		DRG. NAME	DATE	NO. OF
		AC/S/PAVAN	15.1.97	VAR.
		CHD. R. JAGANNATH	15.1.97	NA
		APPROV. K. S. NATH	15.1.97	
DEPT. ENGRS	GRADE OF TOL. DIA	SCALE	WEIGHT (KG)	REF. TO ASSY DRG.
4480	4/14/7	1:5	35.00	2-61-400-00528
TITLE		CARD CODE	DRAWING NO.	REV.
MULTIPLE PORT OUTLET LINER			2-61-400-02467	01
			SHEET NO. 01	NO OF SHEETS 01

REV.	DATE	ALTERED	CHECKED	APPROVED	REV.	DATE	ALTERED	CHECKED	APPROVED	REV.	DATE	ALTERED	CHECKED	APPROVED	REV.	DATE	ALTERED	CHECKED	APPROVED
01	15.05.97																		
NOTE - 5 ADDED																			

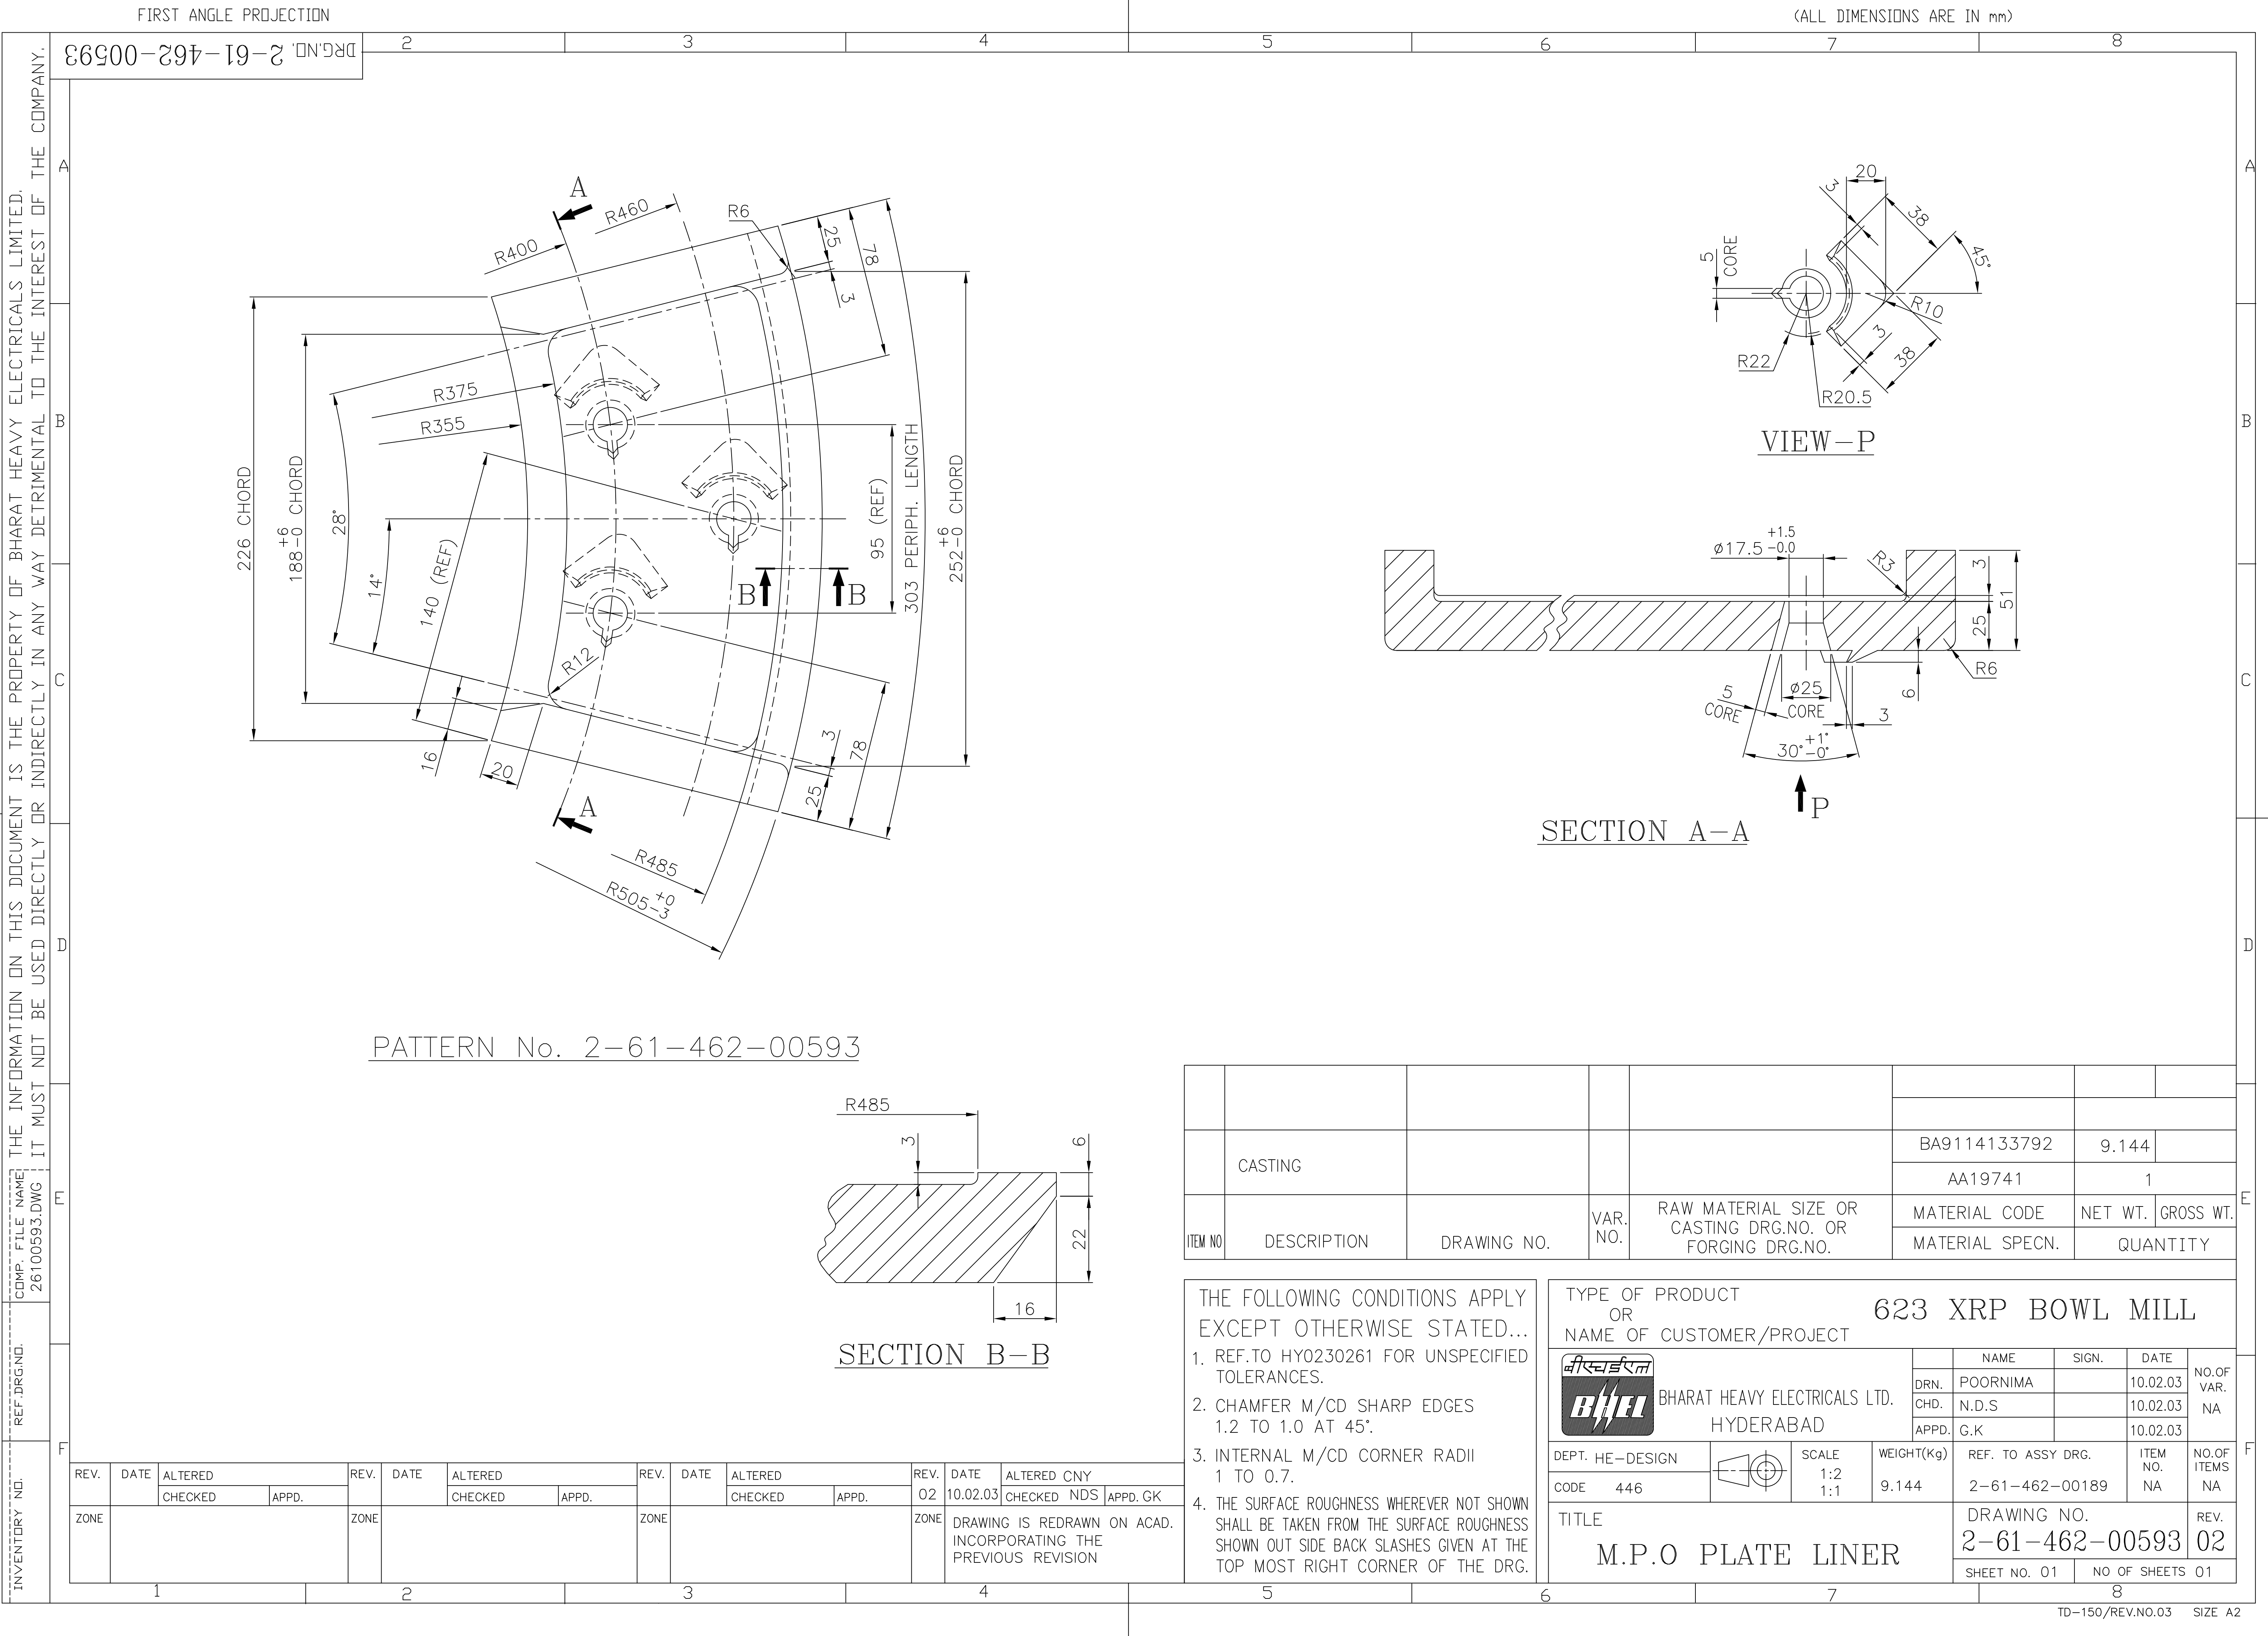





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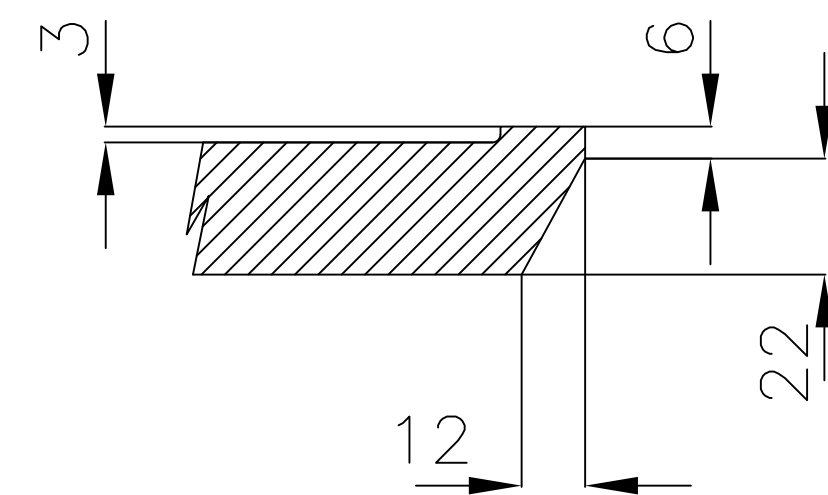
INVENTORY NO	SIGN.	AND DATE	REF. DRG. NO.
			26100118

THE INFORMATION ON THIS DOCUMENT IS THE PROPERTY OF BHARAT HEAVY ELECTRICALS LIMITED. IT MUST NOT BE USED DIRECTLY OR INDIRECTLY IN ANY WAY DETRIMENTAL TO THE INTERESTS OF THE COMPANY.

INVENTORY NO	SIGN.	AND DATE	REF. DRG. NO.
			26100118

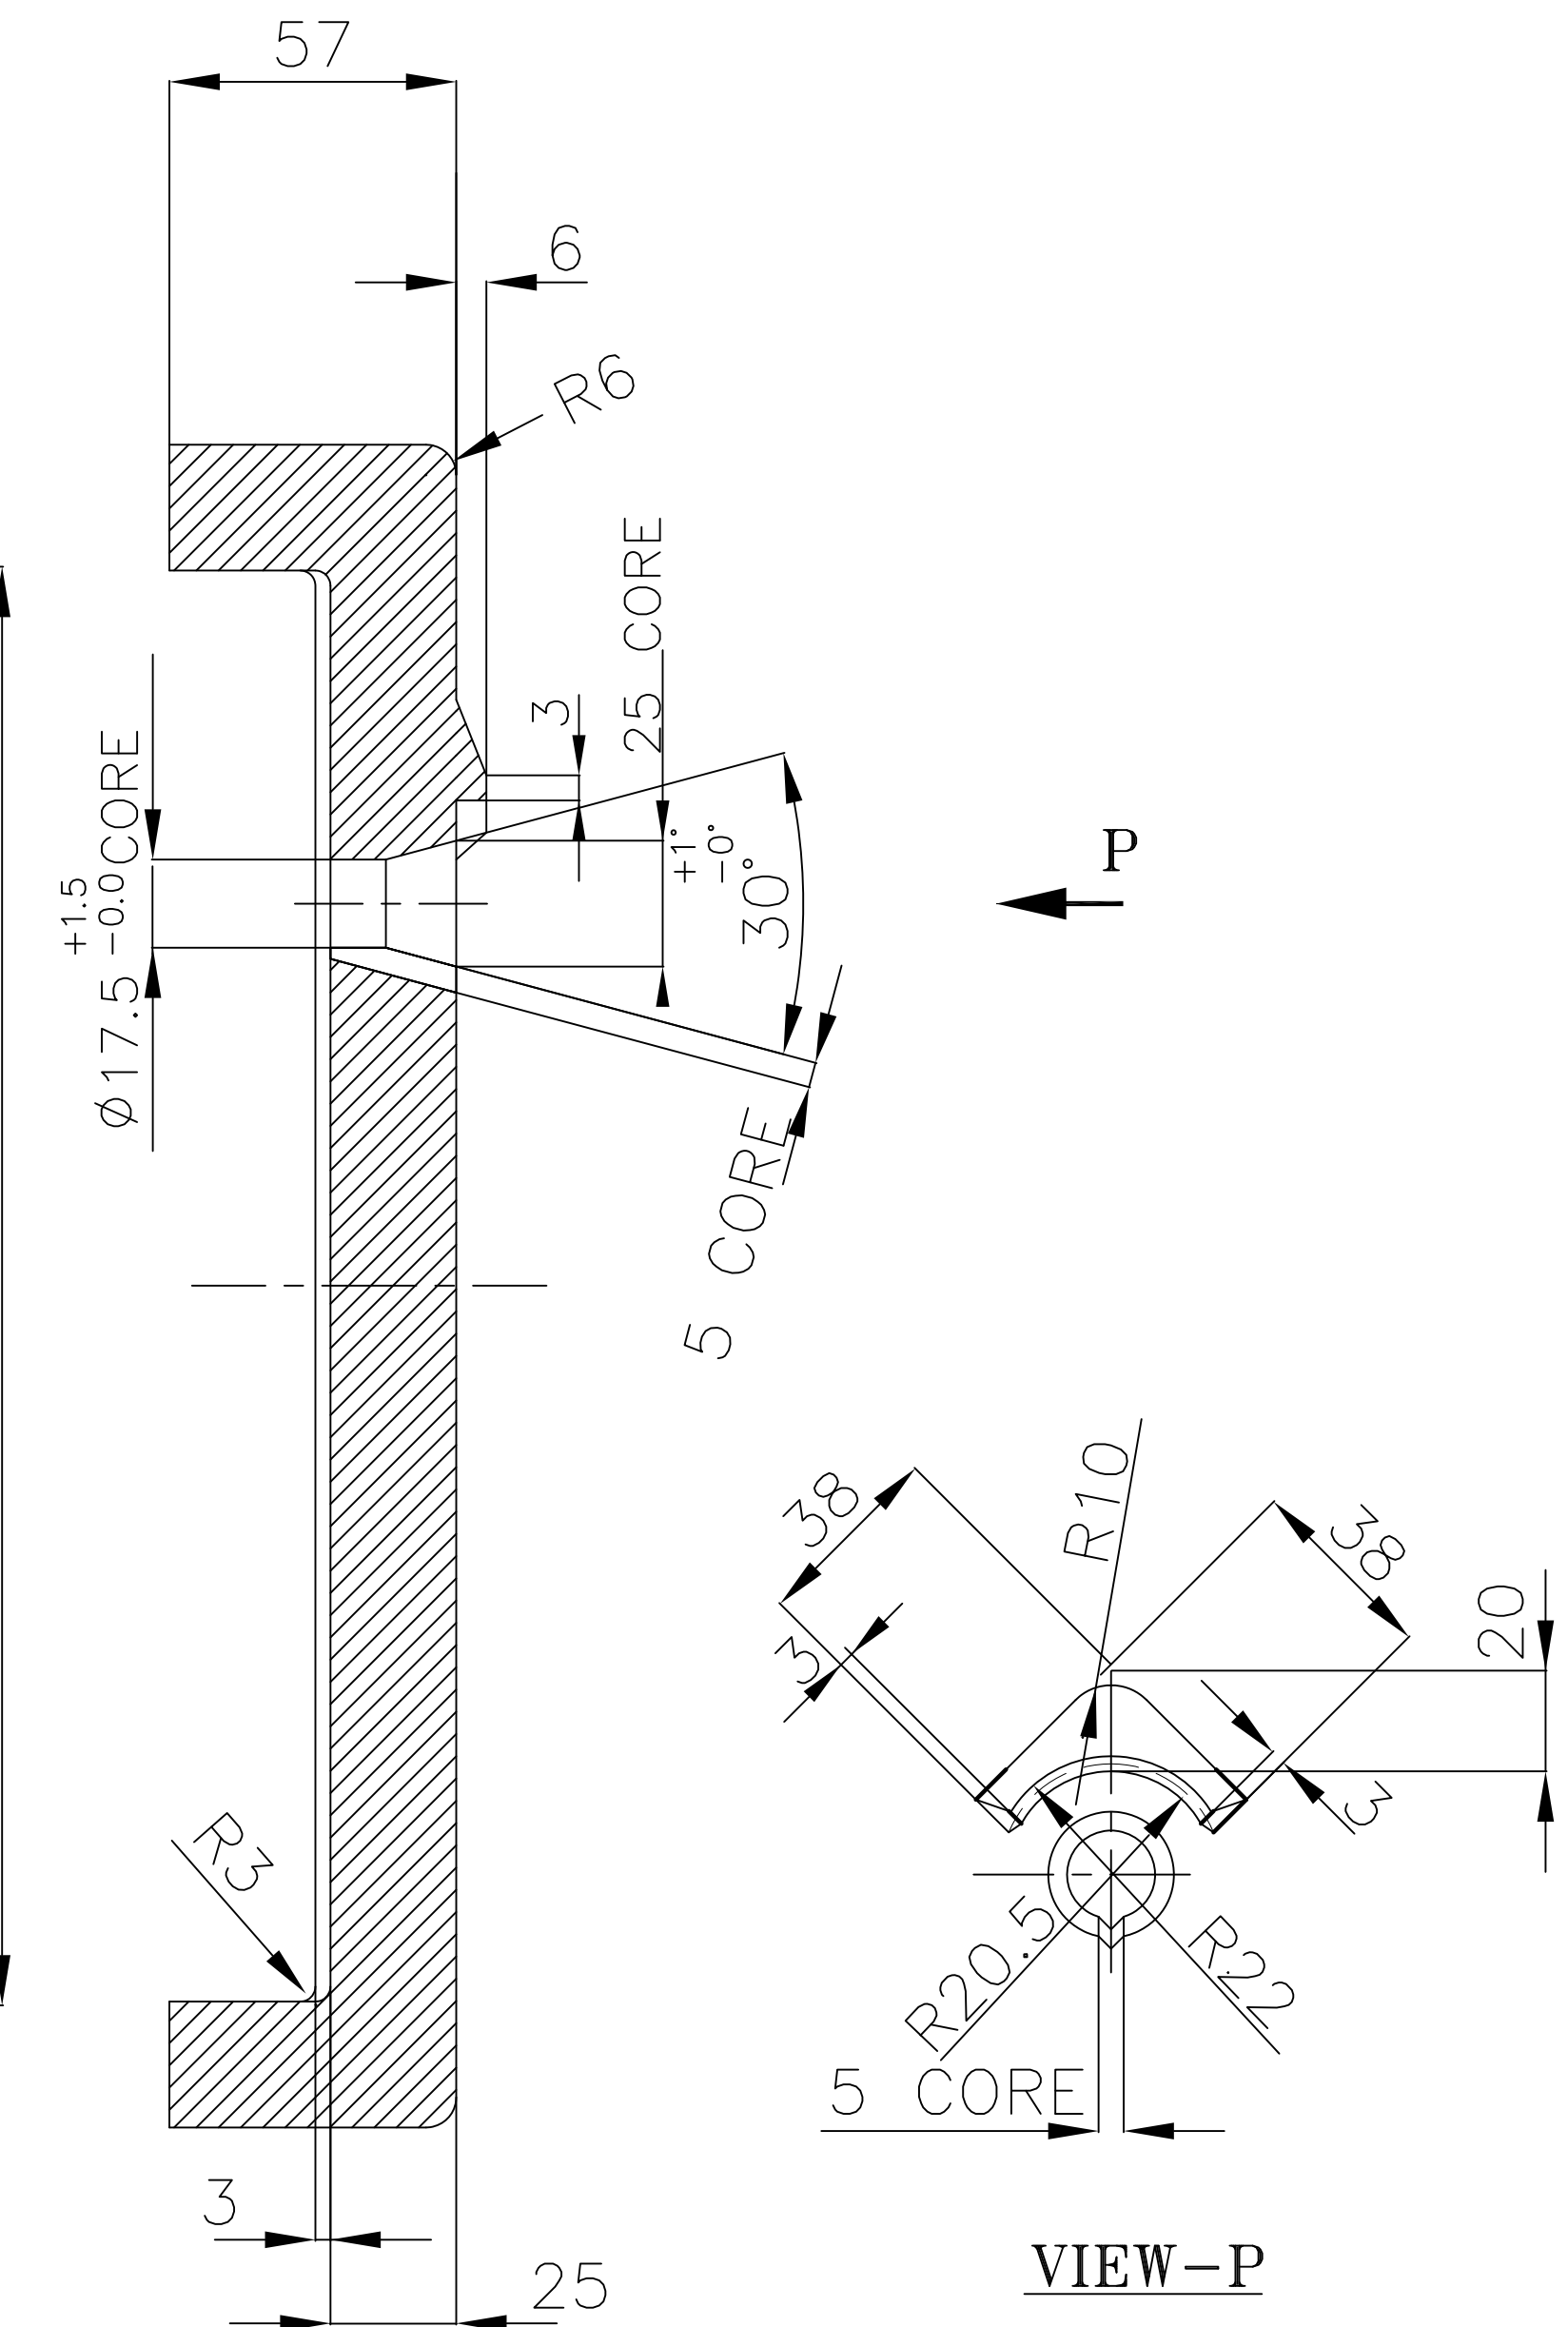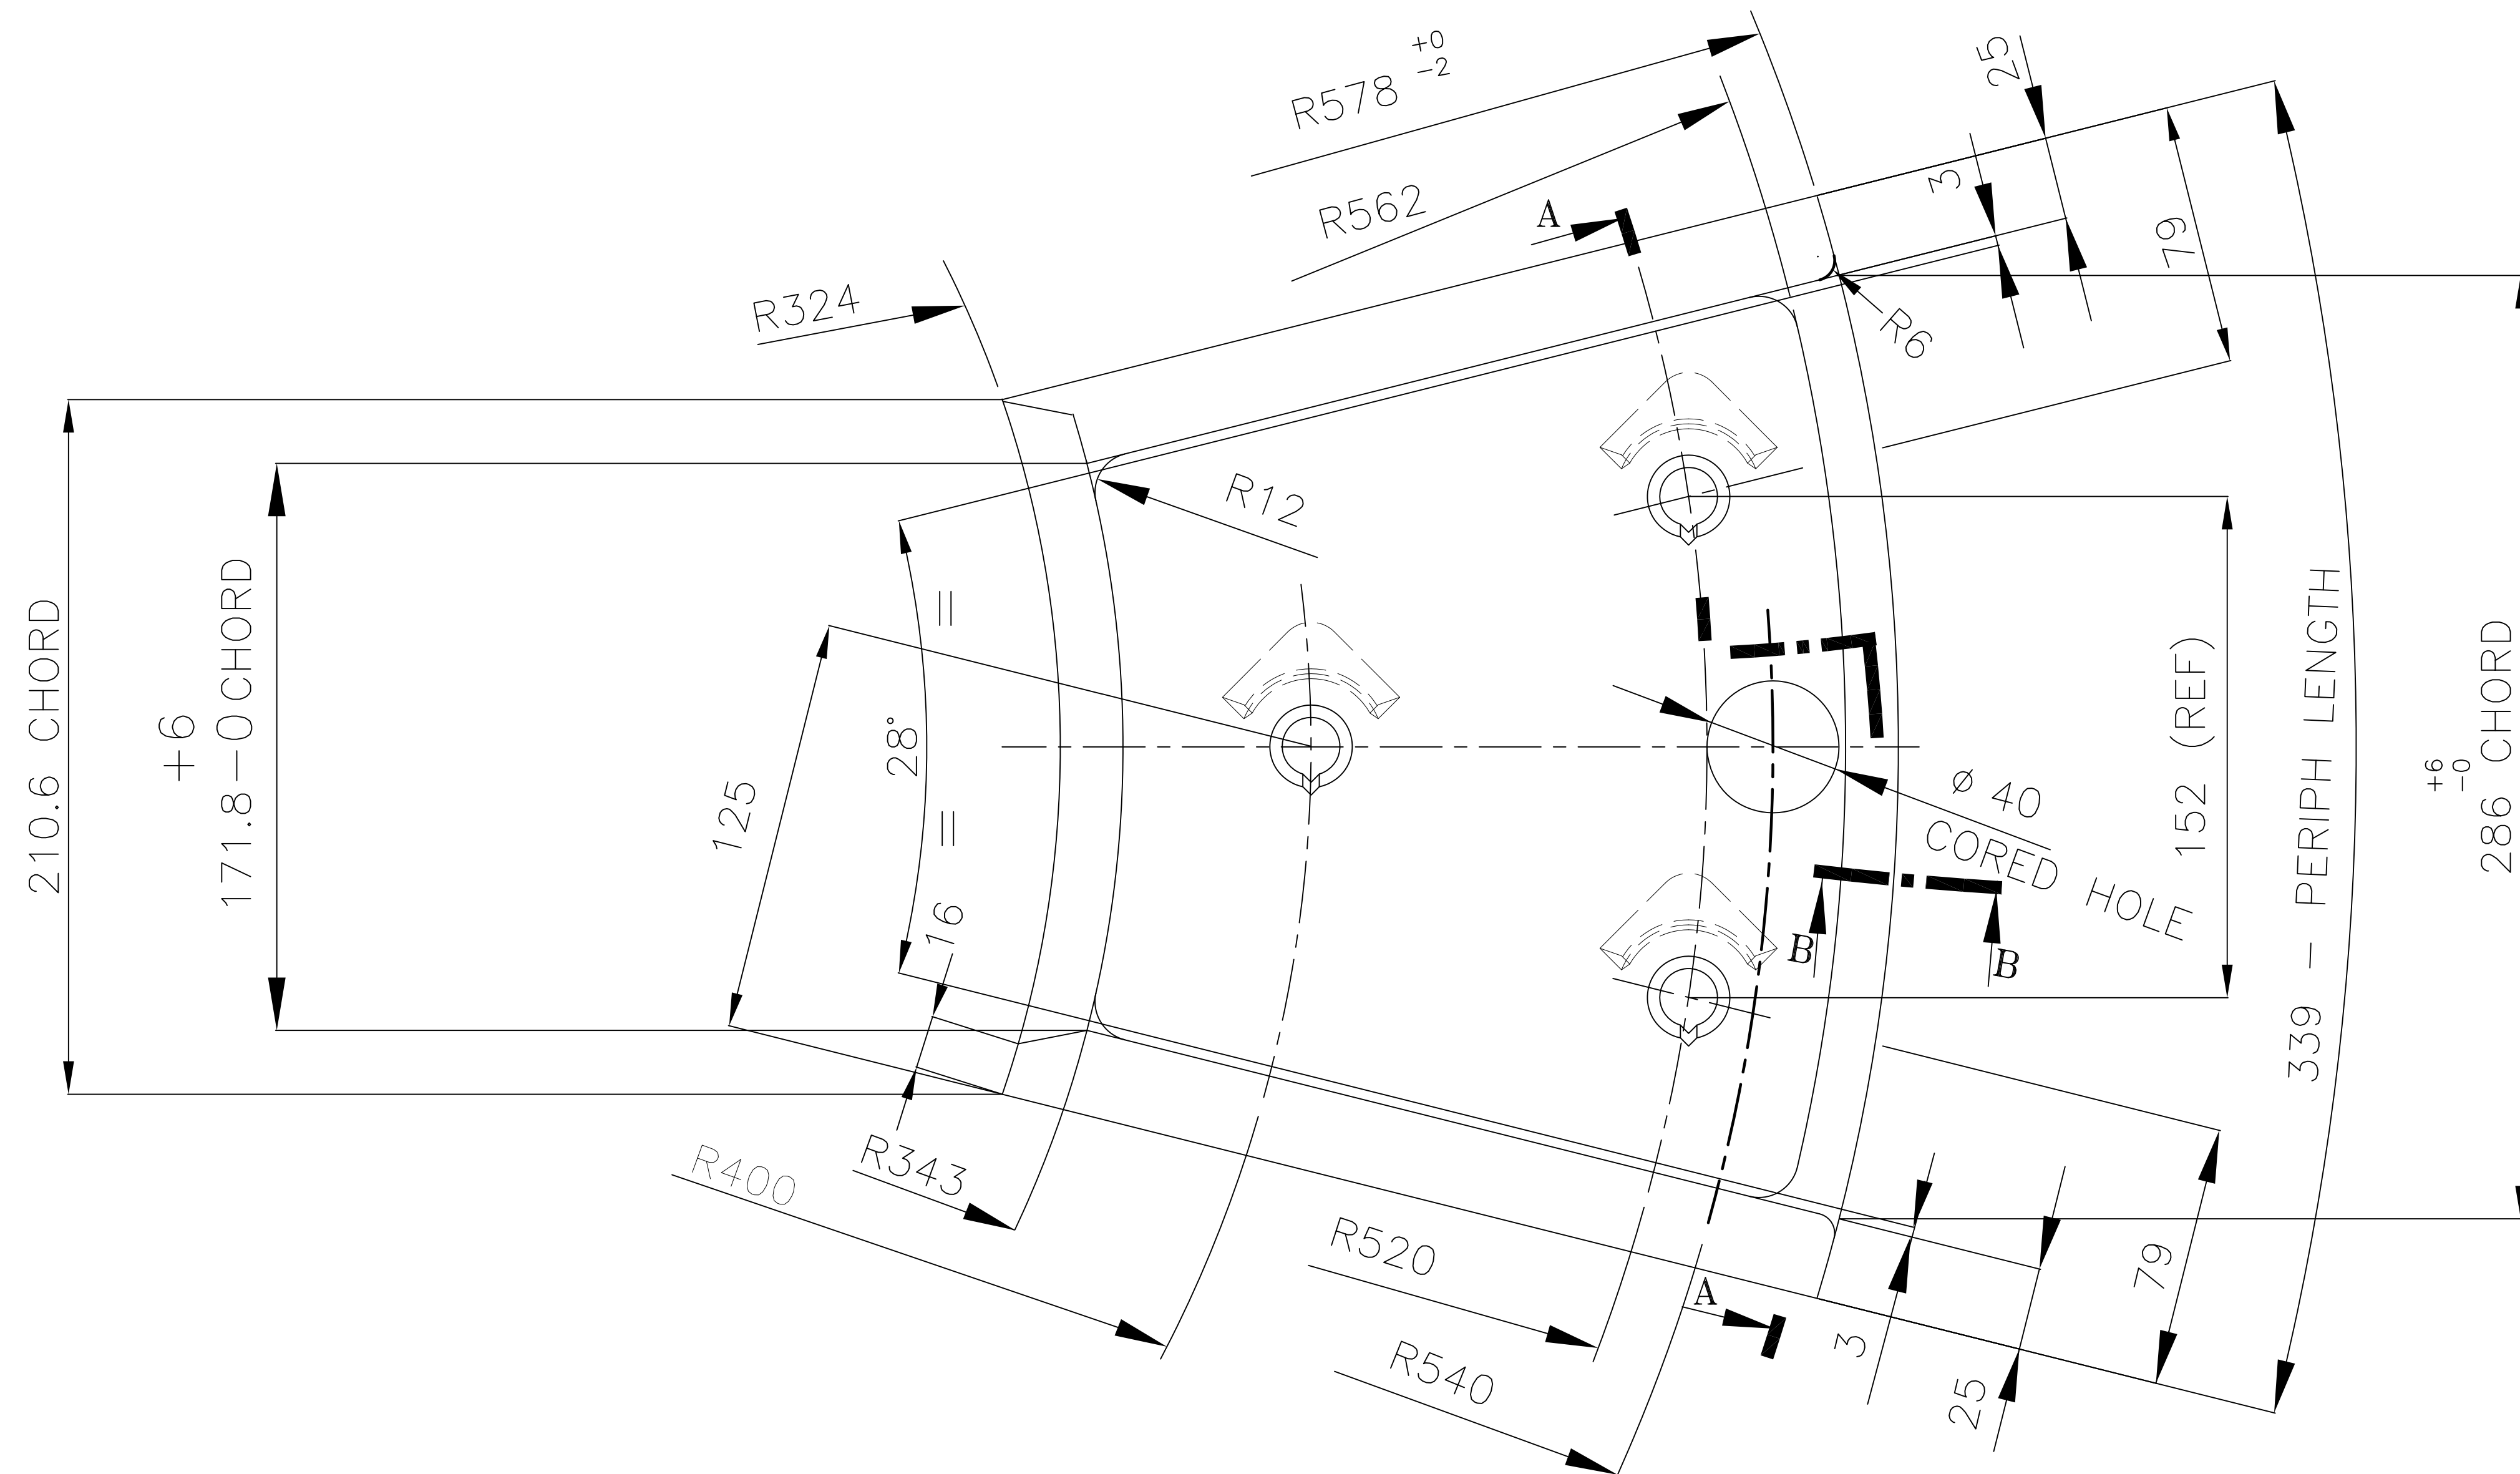

SECTION-AA



## SECTION-BB

	CASTING				BA9114133091		15.00
					AA19741	1	
ITEM NO.	DESCRIPTION	DRAWING NO.	VAR. NO.	RAW MATERIAL SIZE OR CASTING DRG. NO. OR FORGING DRG. NO.	MATERIAL CODE	NET WT.	GROSS WT.
					MATERIAL SPECN.	QUANTITY	


THE FOLLOWING CONDITIONS APPLY  
EXCEPT OTHERWISE STATED.

1. REF. TO HY0230261 FOR UNSPECIFIED TOLERANCES.
2. CHAMFER M/CD. SHARP EDGES 1.2 TO 1.0 AT 45°.
3. INTERNAL M/CD. CORNER RADII 1 TO 0.7
4. THE SURFACE ROUGHNESS WHERE-EVER NOT SHOWN SHALL BE TAKEN FROM THE SURFACE ROUGHNESS SHOWN OUT SIDE THE BACK SLASH GIVEN OR THE TOP MOST RIGHT CORNER OF THE DRG.

TYPE OF PRODUCT

NAME OF CUSTOMER/PROJECT

803 XRP BOWL MILL

 BHARAT HEAVY ELECTRICALS LIMITED HYDERABAD		NAME	SIGN.	DATE	NO.OF VAR.
	DRN.	E.M.ASHOK		27-9-97	
	CHD.	S.GHATGE	<i>[Signature]</i>	28-9-97	
	APPD.	K.M.RAO	<i>[Signature]</i>	28-9-97	

DEPT.	446
CODE	PULV.

UNTOL. DIMS. GR	
Q/M/V	

SCALE	WEIGHT (KG)
1:2	15.00

d)	REF. TO ASSY DRG.	ITEM NO.	NO.OF ITEMS
----	-------------------	----------	-------------

TITLE	OUTLET PLATE LINER
-------	--------------------

	CAR.
	CODI

DRAWING NO.	REV.
2-61-476-00118	04


SHEET NO. 01	NO OF SHEETS 01
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REV.	DATE	ALTERED	REV.	DATE	ALTERED	REV.	DATE	ALTERED
		CHD./APPD.			CHD./APPD.	04	27-9-97	E.M.ASHOK KUMAR CHD./APPD. S.GHATGE
ZONE			ZONE			ZONE		DRG RETRACED WITH ALL PREVIOUS REVISIONS.




INVENTORY NO. \_\_\_\_\_ SIGN. AND DATE \_\_\_\_\_ REF. DRG. NO. \_\_\_\_\_ COMPUTER FILE NAME \_\_\_\_\_  
26102055.DWG  
THE INFORMATION ON THIS DOCUMENT IS THE PROPERTY OF BHARAT HEAVY ELECTRICALS LIMITED. IT MUST NOT BE USED DIRECTLY OR INDIRECTLY IN ANY WAY DETRIMENTAL TO THE INTEREST OF THE COMPANY

GENERAL DIMENSIONAL LIMITS, FITS & TOLERANCES AS PER HY0230261

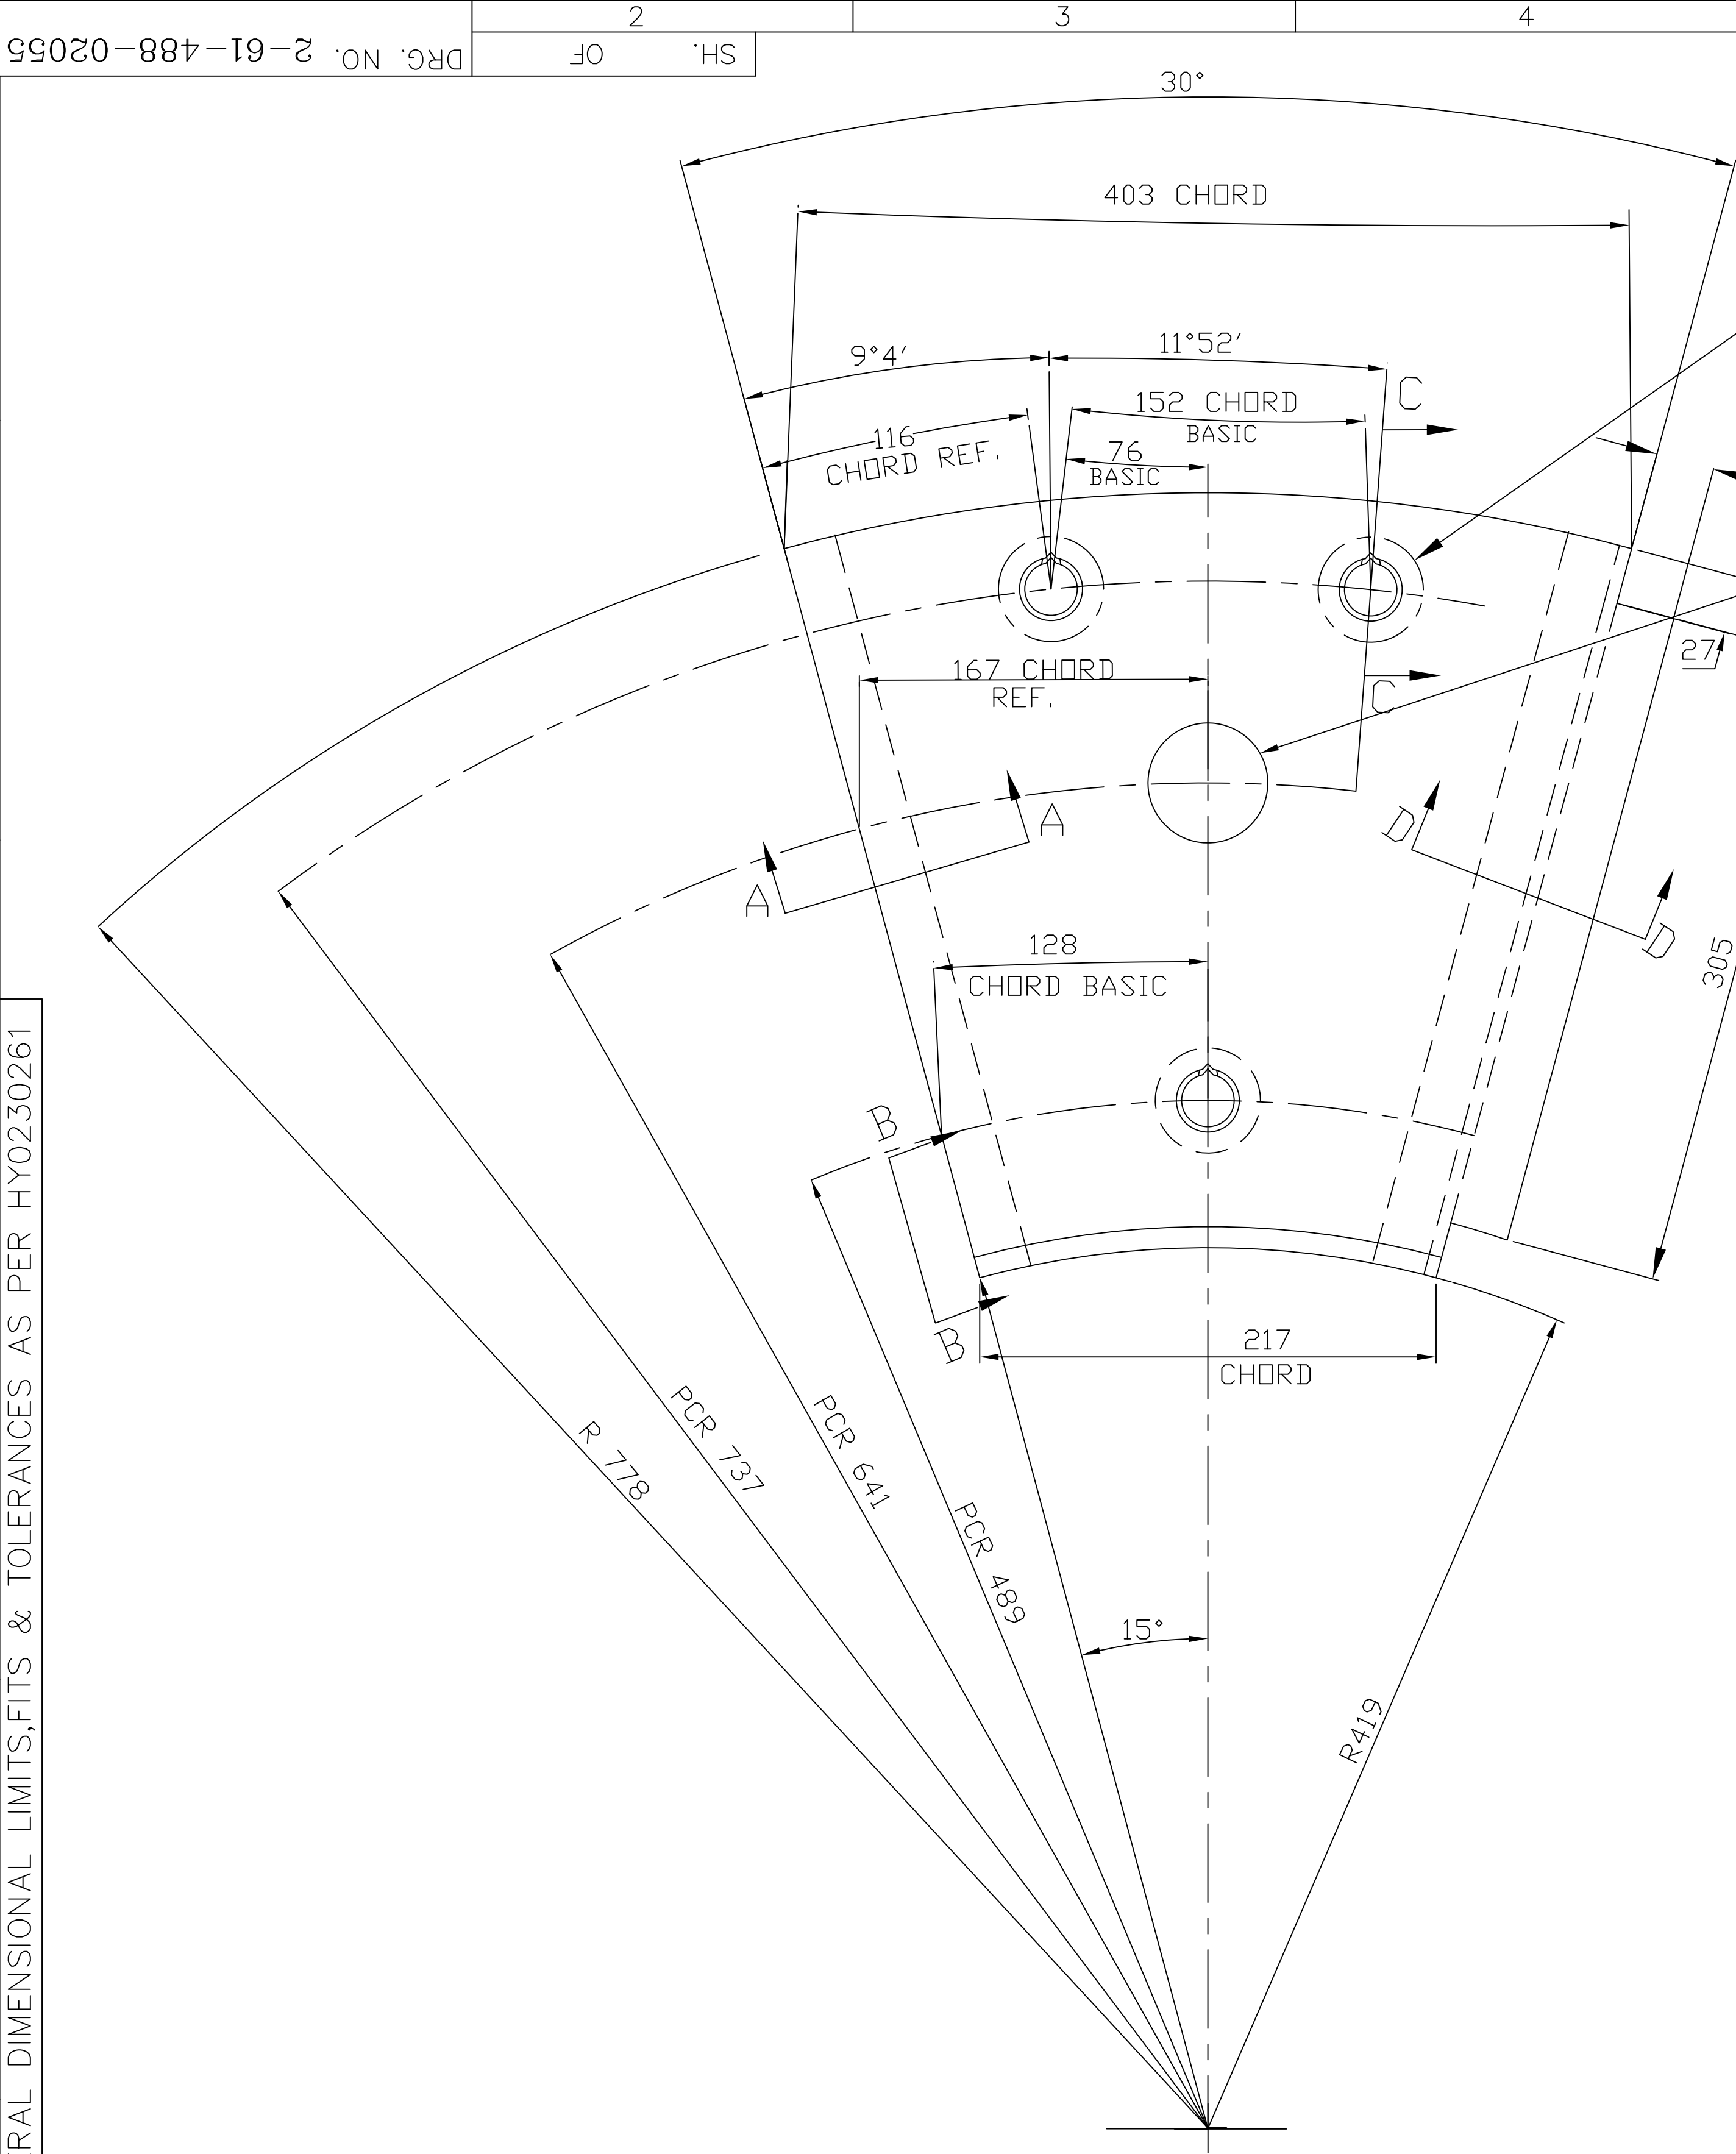


CORED HOLE 3 PLACES (SEE SEC-CC)  
⌀0.800M


DIA 57 CORED HOLE  
⌀3.00M

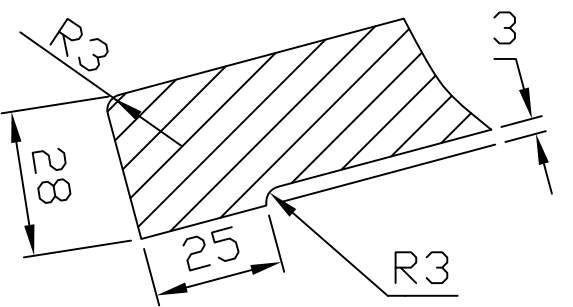


SECTION-AA

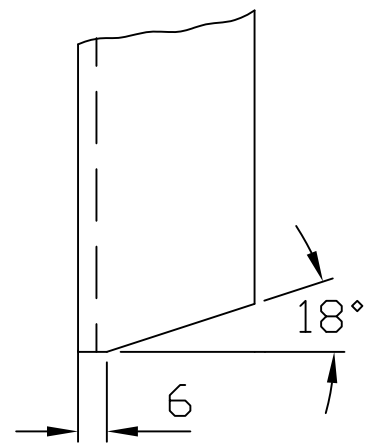

VIEW-BB

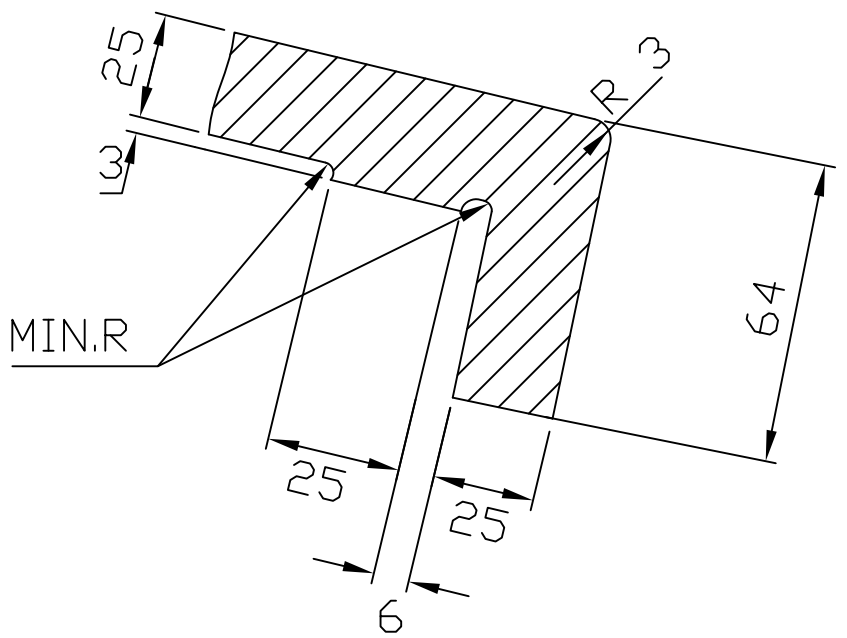

SECTION-DD

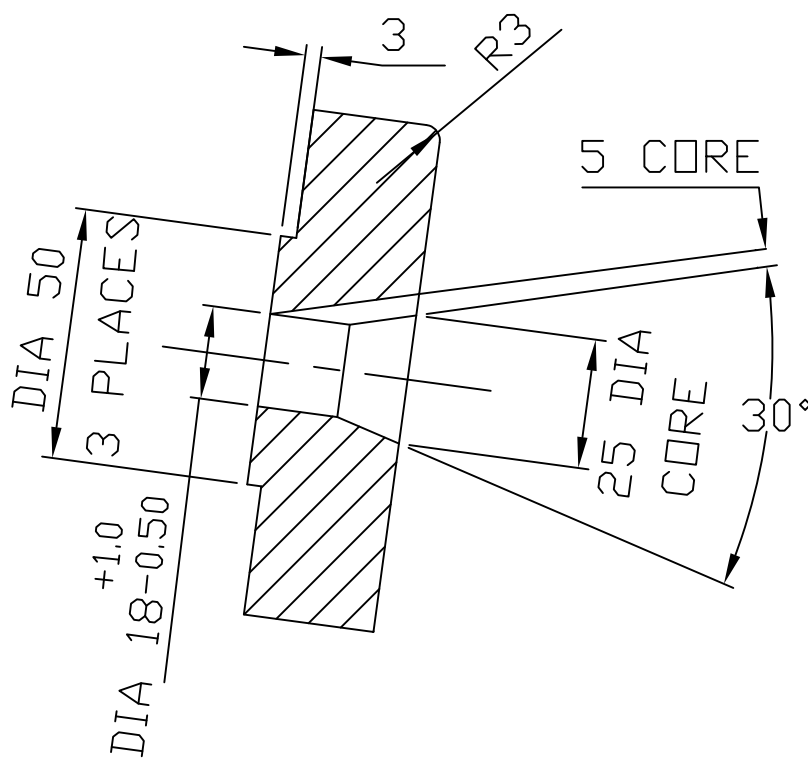


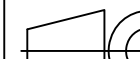
SECTION-CC

		CASTING				BA9114135035				25.000		
						AA19741						
VAR. NO.	ITEM NO.	DESCRIPTION	UTS	DRG.NO.	ITEM NO. VAR. NO.	MATL. CODE	A	UNIT D1	UNIT WT.	GS	ZONE	
						MATL. SPECN	C		QTY.			

THE FOLLOWING CONDITIONS APPLY EXCEPT OTHERWISE STATED.

- REF. TO HY0230261 FOR UNSPECIFIED TOLERANCES.
- CHAMFER M/CD. SHARP EDGES 1.2 TO 1.0 AT 45°
- INTERNAL M/CD. CORNER RADII 1 TO 0.7
- THE SURFACE ROUGHNESS WHERE-EVER NOT SHOWN SHALL BE TAKEN FROM THE SURFACE ROUGHNESS SHOWN OUT SIDE THE BACK SLASH GIVEN ON THE TOP MOST RIGHT CORNER OF THE DRG.


TYPE OF PRODUCT OR NAME OF CUSTOMER/PROJECT 883 XRP BOWL MILL

		BHARAT HEAVY ELECTRICALS LIMITED HYDERABAD				NAME	SIGN.	DATE	NO.OF VAR.
					DRN.	ANURADHA		21.10.02	
					CHD.	N.D.SAMUEL		21.10.02	
					APPD.	G.KISTAIAH		21.10.02	
DEPT. PULV.ENG DEPT CODE. 446	UNTOL. DIMS. GR. /M/		SCALE NTS	WEIGHT (KG) 25.000	REF. TO ASSY. DRG. 0-61-488-0515 (C-94-810/0)		ITEM NO.	NO.OF ITEMS	
TITLE OUTLET PLATE LINER					CARD CODE	DRAWING NO. 2-61-488-02055		REV. 01	
					SHT. No		NO. OF SHT.		

REV. 01	DATE	ALTERED
		CHD/APPD
ZONE		DRG. REDRAWN

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IT MUST NOT BE USED DIRECTLY OR INDIRECTLY IN ANY WAY DETRIMENTAL TO THE INTEREST OF THE COMPANY

INVENTORY NO. 26100706  
SIGN. AND DATE  
REF. DRG. NO. 26100706

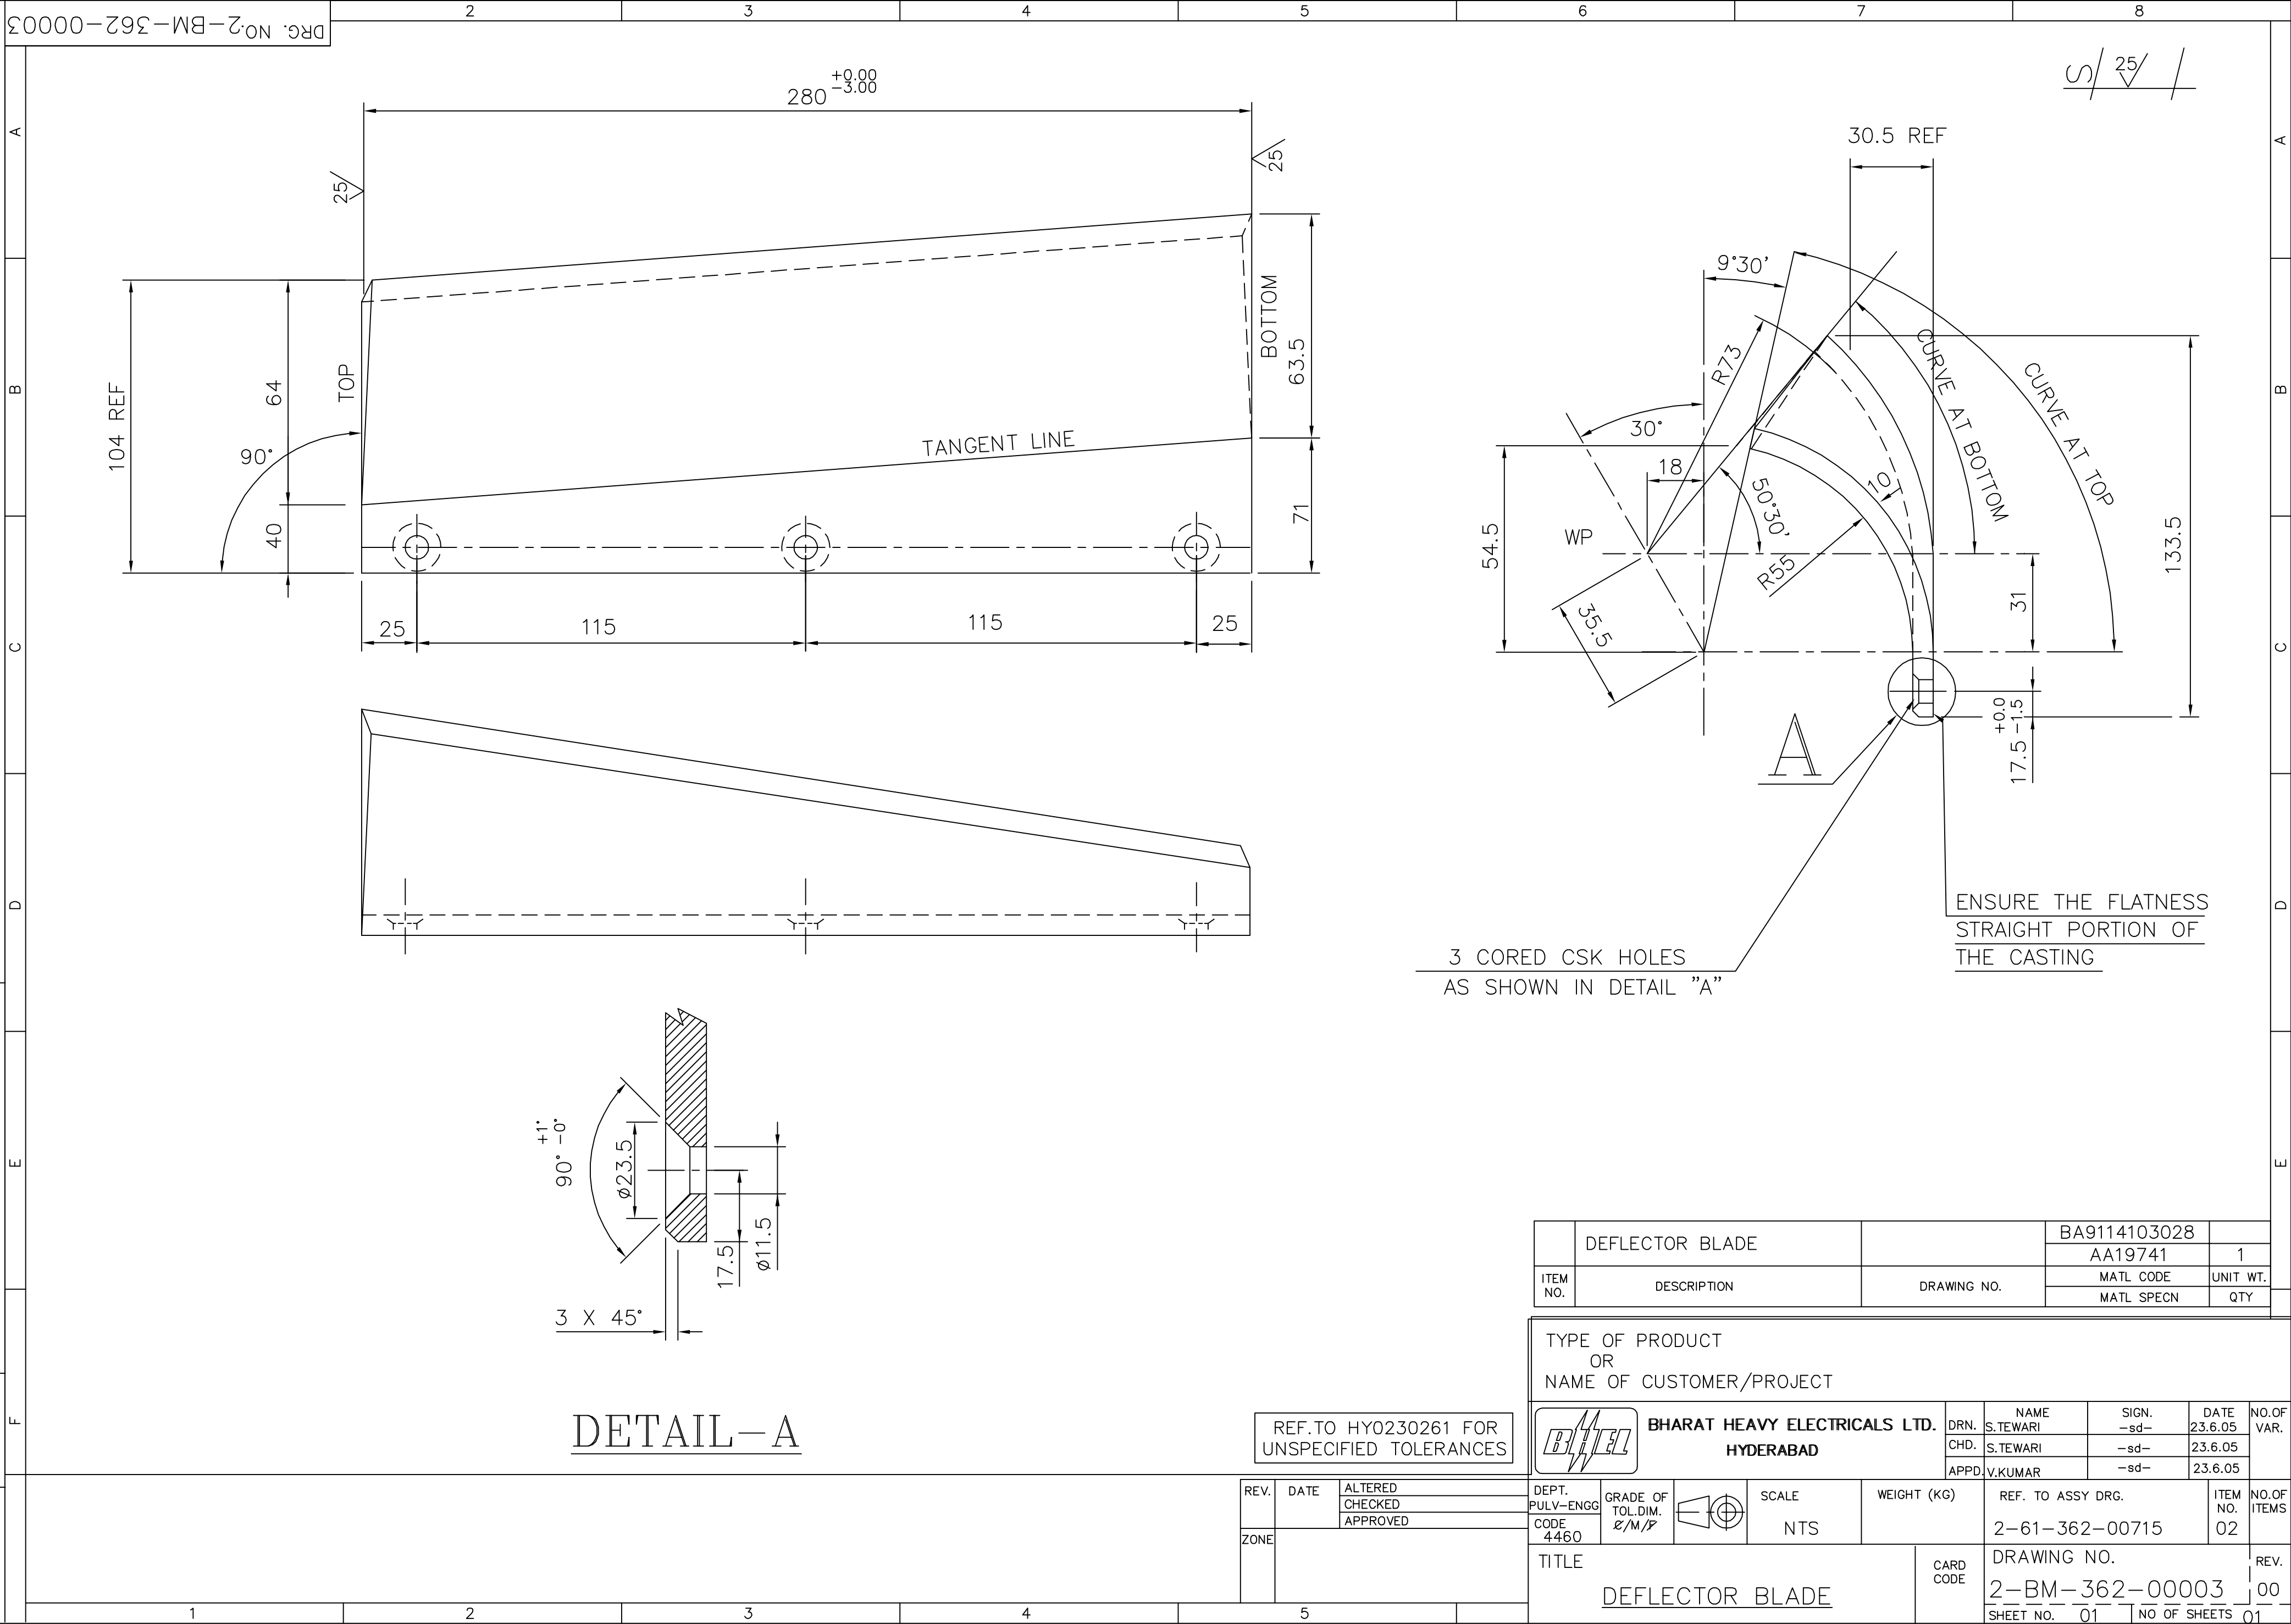


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COMP. FILE NAME  
36100579.DWG



REF.DRG.NO.

INVENTORY NO.

DRG.NO.3-61-062-00579

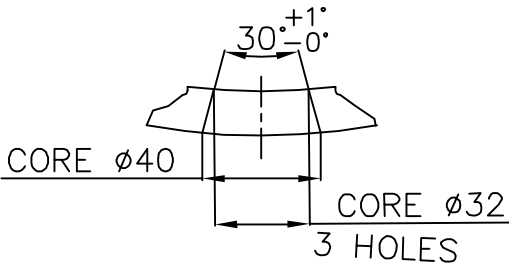

DETAIL-B

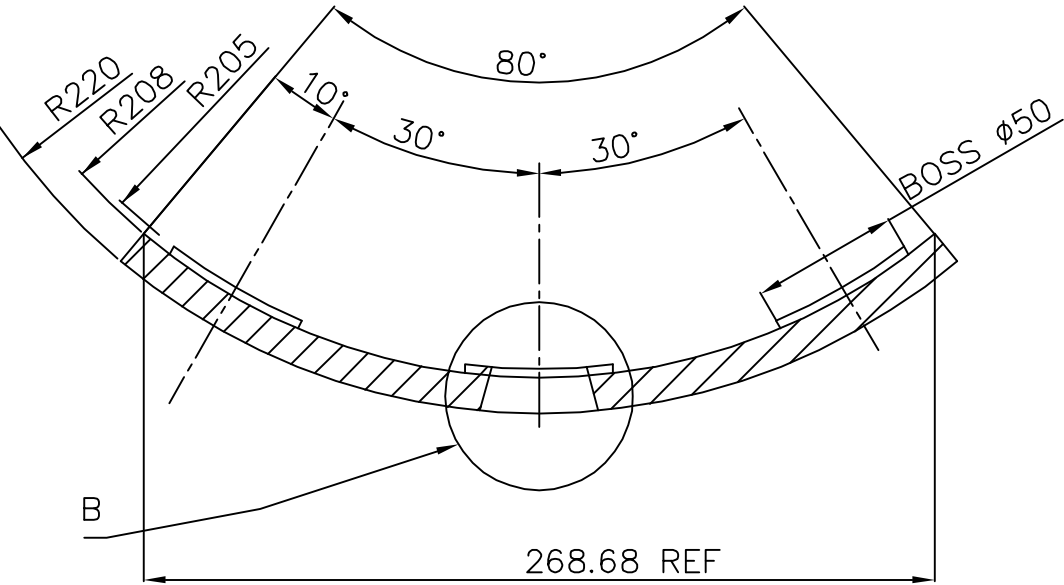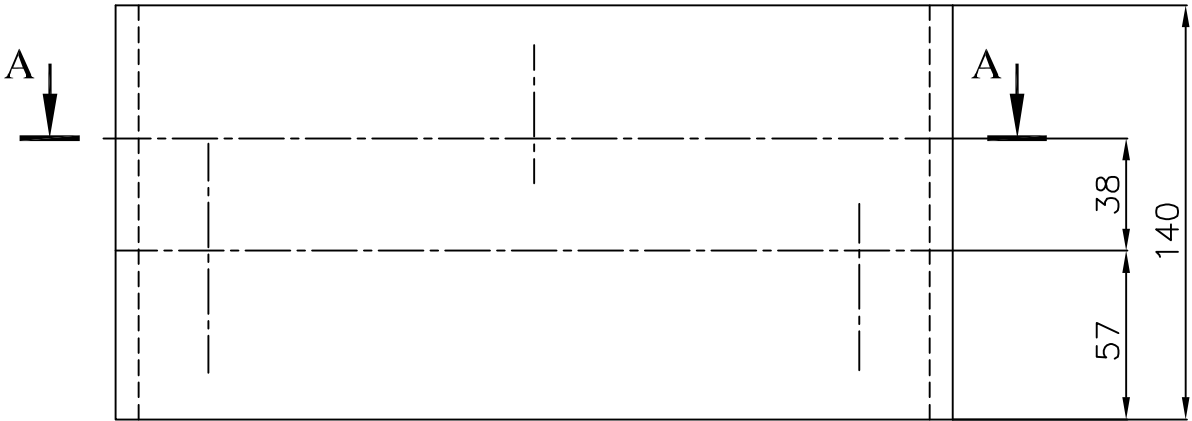

SECTION - AA


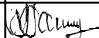

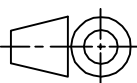
NOTES

- 1. BREAK ALL SHARP EDGES UNLISS OTHERWISE NOTED
- 2. PATTERN NO.3-61-062-00579
- 3. CASTING TOLERANCE UNLESS OTHERWISE NOTED ±1.6

01	CASTING				—	3.95	
					COMBALLOY		1
ITEM NO	DESCRIPTION	DRAWING NO.	VAR. NO.	RAW MATERIAL SIZE OR CASTING DRG.NO. OR FORGING DRG.NO.	MATERIAL CODE	NET WT.	GROSS WT.
					MATERIAL SPECN.	QUANTITY	

THE FOLLOWING CONDITIONS APPLY EXCEPT OTHERWISE STATED...

1. REF.TO HY0230261 FOR UNSPECIFIED TOLERANCES.
2. CHAMFER M/CD SHARP EDGES 1.2 TO 1.0 AT 45°.
3. INTERNAL M/CD CORNER RADII 1 TO 0.7.
4. THE SURFACE ROUGHNESS WHEREVER NOT SHOWN SHALL BE TAKEN FROM THE SURFACE ROUGHNESS SHOWN OUT SIDE BACK SLASHES GIVEN AT THE TOP MOST RIGHT CORNER OF THE DRG.

TYPE OF PRODUCT OR NAME OF CUSTOMER/PROJECT								
	भारत हेवी इलेक्ट्रिकल्स लिमिटेड हैदराबाद BHARAT HEAVY ELECTRICALS LTD. HYDERABAD			NAME	SIGN.	DATE	NO.OF VAR.	
			DRN.	RAZVI		9.11.02		
			CHD.	NDSAMUEL		9.11.02		
			APPD.	S.GHATGE		9.11.02		
DEPT.	PULVE		SCALE	WEIGHT (KG)	REF. TO ASSY DRG.	ITEM NO.	NO.OF ITEMS	
CODE	443		1: 2.5	3.95	—	—	—	
TITLE <u>JOURNAL HEAD LINER-I</u>					DRAWING NO.		REV.	
					3-61-062-00579		03	
					SHEET NO.	01	NO OF SHEETS	01



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36100580.DWG  
FILE NAME

REF.DRG.NO.

INVENTORY NO.

DRG.NO. 3-61-062-00580

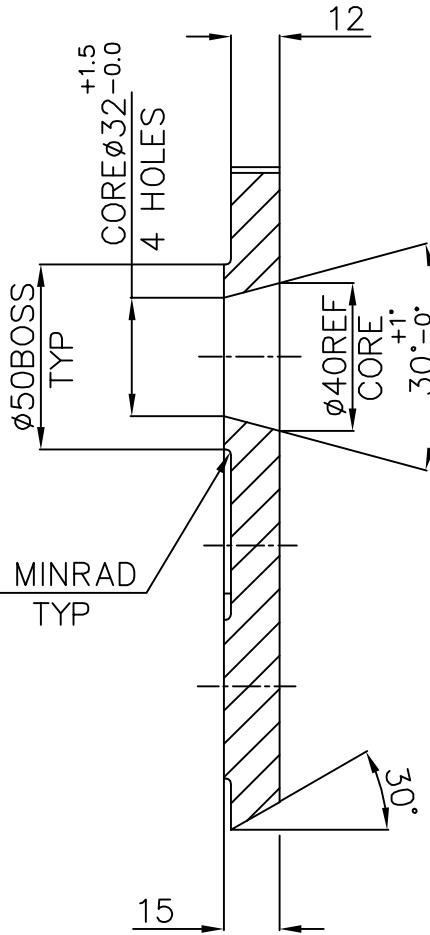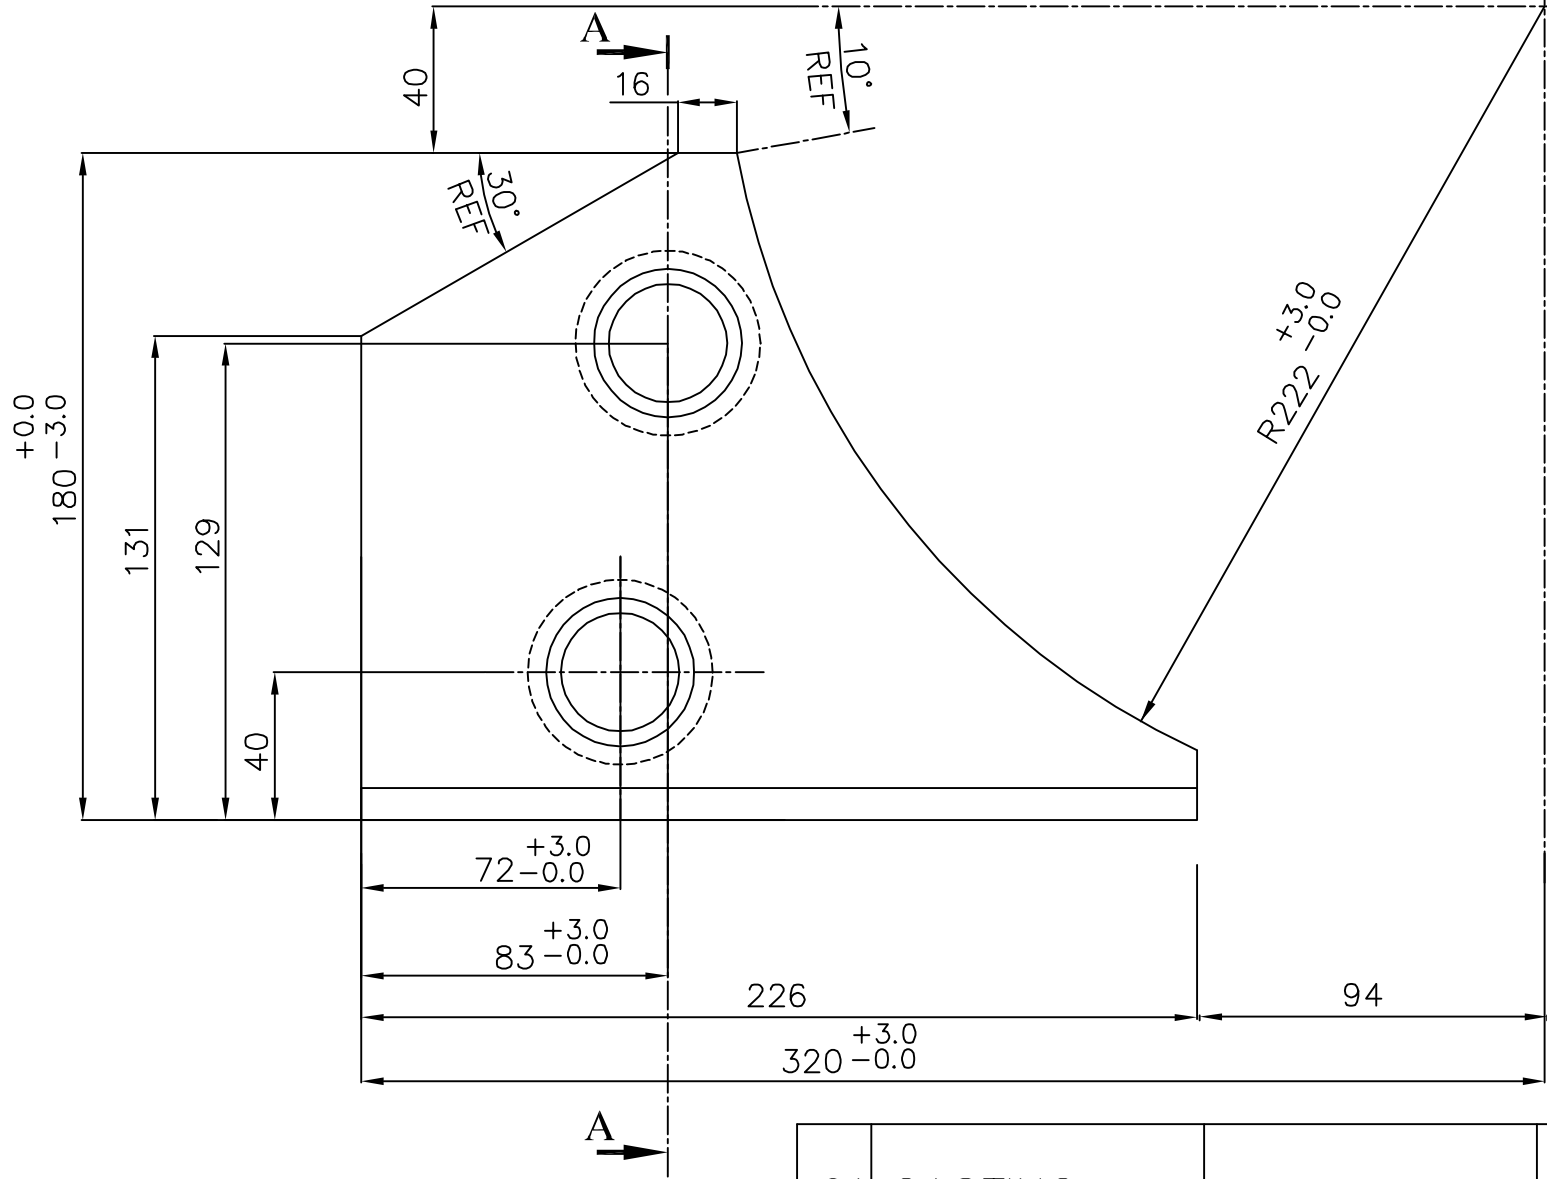


NOTE.

1. BREAK ALL SHARP EDGES UNLES OTHERWISE NOTED.
2. PATTERN NO.: 3-61-062-00580.
3. CASTING TOLERANCE UNLESS OTHERWISE NOTED  $\pm 1.6$ .

01	CASTING				BA9114133997	2.70	
					AA10741		1
ITEM NO	DESCRIPTION	DRAWING NO.	VAR. NO.	RAW MATERIAL SIZE OR CASTING DRG.NO. OR FORGING DRG.NO.	MATERIAL CODE	NET WT.	GROSS WT.
					MATERIAL SPECN.	QUANTITY	

THE FOLLOWING CONDITIONS APPLY EXCEPT OTHERWISE STATED...

1. REF.TO HY0230261 FOR UNSPECIFIED TOLERANCES.
2. CHAMFER M/CD SHARP EDGES 1.2 TO 1.0 AT 45°.
3. INTERNAL M/CD CORNER RADII 1 TO 0.7.
4. THE SURFACE ROUGHNESS WHEREVER NOT SHOWN SHALL BE TAKEN FROM THE SURFACE ROUGHNESS SHOWN OUT SIDE BACK SLASHES GIVEN AT THE TOP MOST RIGHT CORNER OF THE DRG.

TYPE OF PRODUCT OR NAME OF CUSTOMER/PROJECT				623 XRPBM			
 BHARAT HEAVY ELECTRICALS LTD. HYDERABAD				DRN.	NAME	SIGN.	DATE
				CHD.	RAZVI		11.11.02
				APPD.	NDSAMUEL		11.11.02
DEPT.	PULVE.ENG	SCALE	WEIGHT (KG)	REF. TO ASSY DRG.	ITEM NO.	NO.OF ITEMS	
CODE	446	1:2	2.70	1-61-062-00314	03	—	
TITLE				DRAWING NO.	REV.		
JOURNAL HEAD LINER-II				3-61-062-00580	04		
				SHEET NO. 01	NO OF SHEETS	01	


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36100581.DWG  
FILE NAME


REF.DRG.NO.

INVENTORY NO.

DRG.NO. 3-61-062-00581

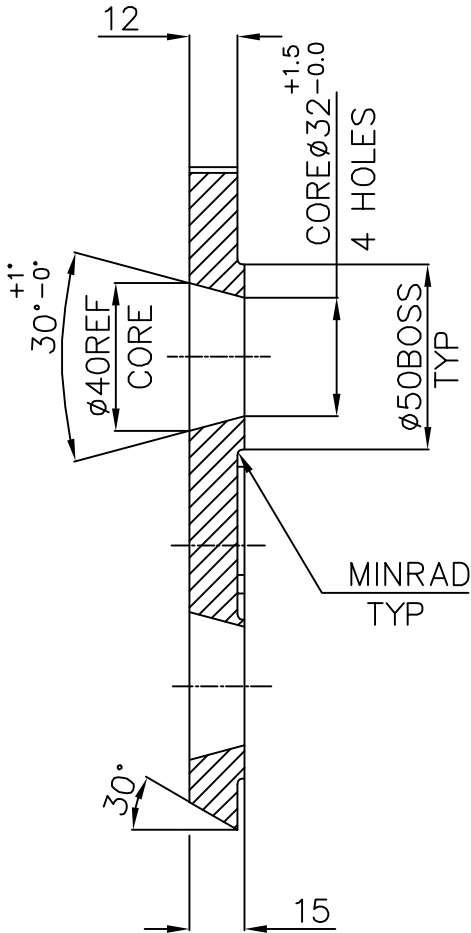

SECTION-AA

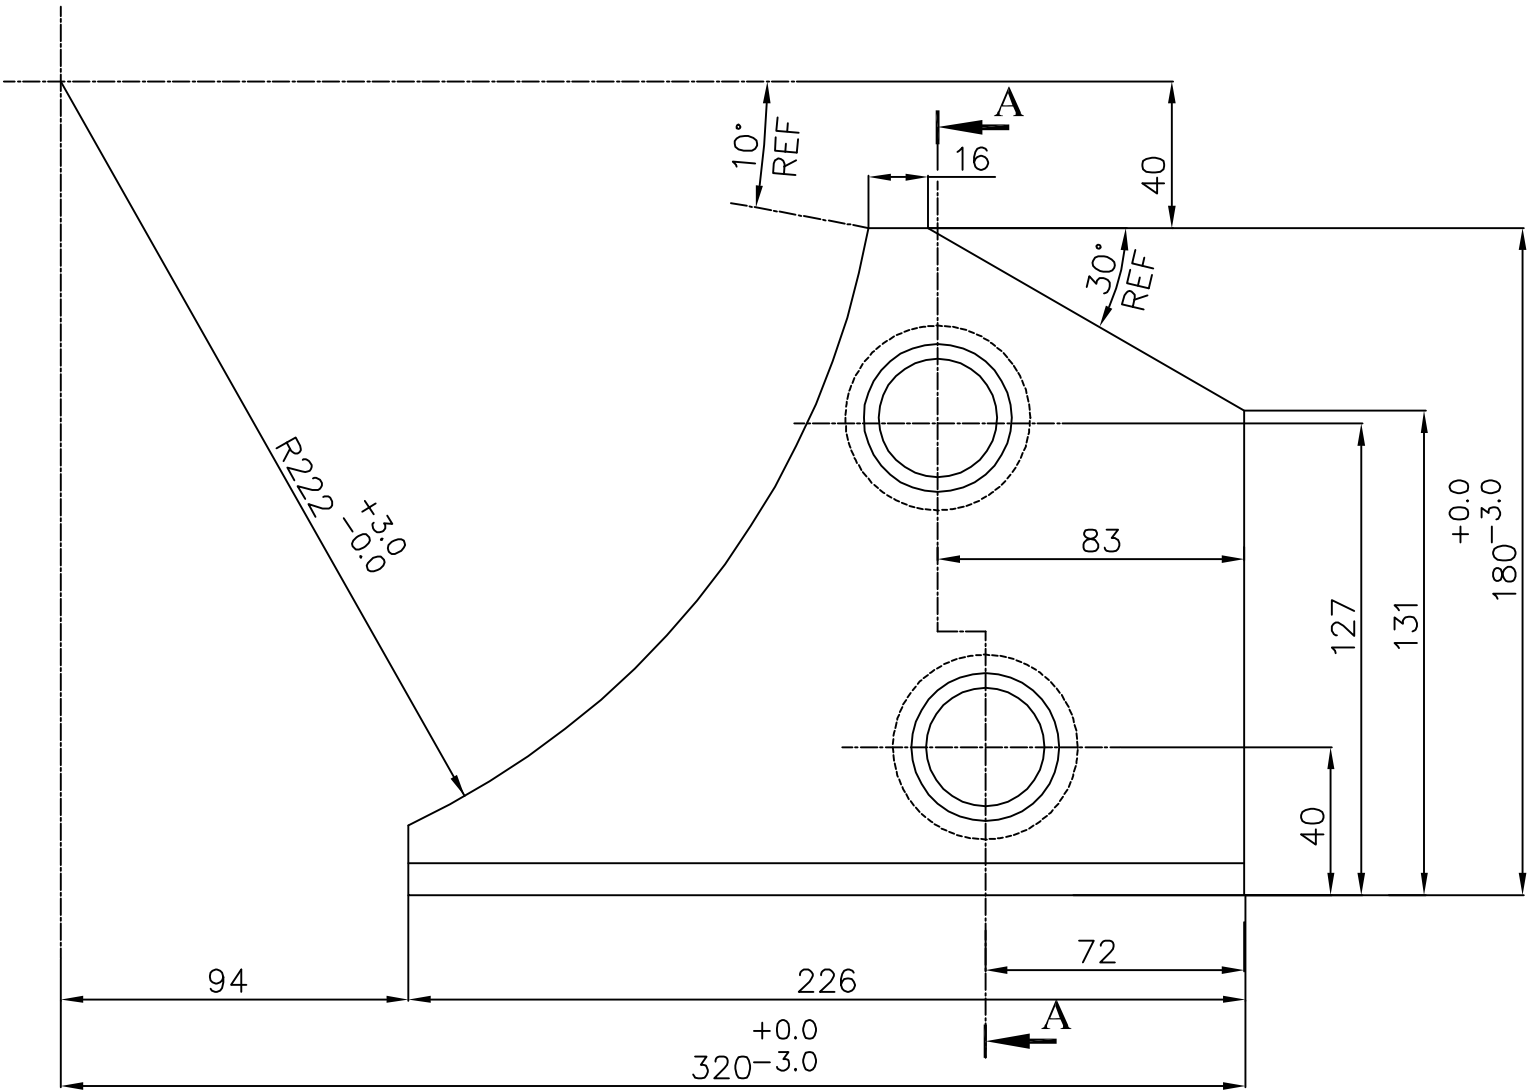

NOTE.

1. BREAK ALL SHARP EDGES UNLES OTHERWISE NOTED.
2. PATTERN NO.: 3-61-062-00581.
3. CASTING TOLERANCE UNLESS OTHERWISE. NOTED  $\pm 1.6$

01	CASTING				BA9114134004	2.70	
					AA19741		1
ITEM NO	DESCRIPTION	DRAWING NO.	VAR. NO.	RAW MATERIAL SIZE OR CASTING DRG.NO. OR FORGING DRG.NO.	MATERIAL CODE	NET WT.	GROSS WT.
					MATERIAL SPECN.	QUANTITY	

THE FOLLOWING CONDITIONS APPLY EXCEPT OTHERWISE STATED...

1. REF.TO HY0230261 FOR UNSPECIFIED TOLERANCES.
2. CHAMFER M/CD SHARP EDGES 1.2 TO 1.0 AT 45°.
3. INTERNAL M/CD CORNER RADII 1 TO 0.7.
4. THE SURFACE ROUGHNESS WHEREVER NOT SHOWN SHALL BE TAKEN FROM THE SURFACE ROUGHNESS SHOWN OUT SIDE BACK SLASHES GIVEN AT THE TOP MOST RIGHT CORNER OF THE DRG.

TYPE OF PRODUCT OR NAME OF CUSTOMER/PROJECT  
623 XRPBM



BHARAT HEAVY ELECTRICALS LTD.  
HYDERABAD

DEPT. PULVE.ENG	SCALE 1:2	WEIGHT (KG) 2.70	REF. TO ASSY DRG. 1-61-062-00314	ITEM NO. 04	NO.OF ITEMS —
CODE 446			DRAWING NO. 3-61-062-00581	REV. 04	
TITLE JOURNAL HEAD LINER-III			SHEET NO. 01	NO OF SHEETS 01	



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COMP. FILE NAME  
36100582.DWG

REF. DRG. NO.

INVENTORY NO.

DRG.NO. 3-61-062-00582

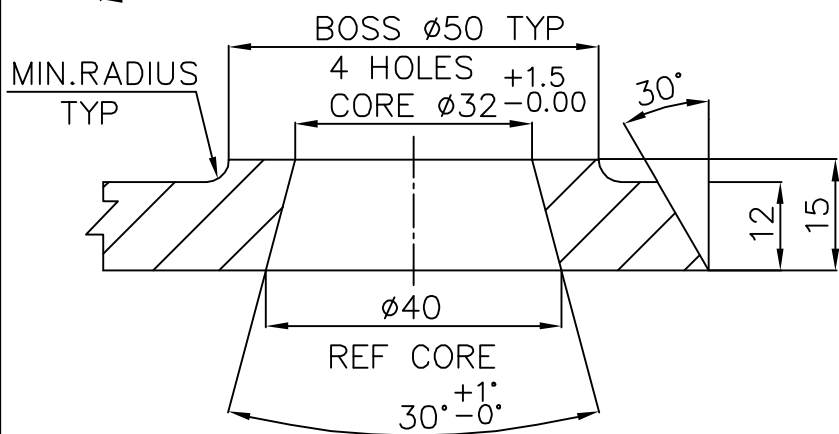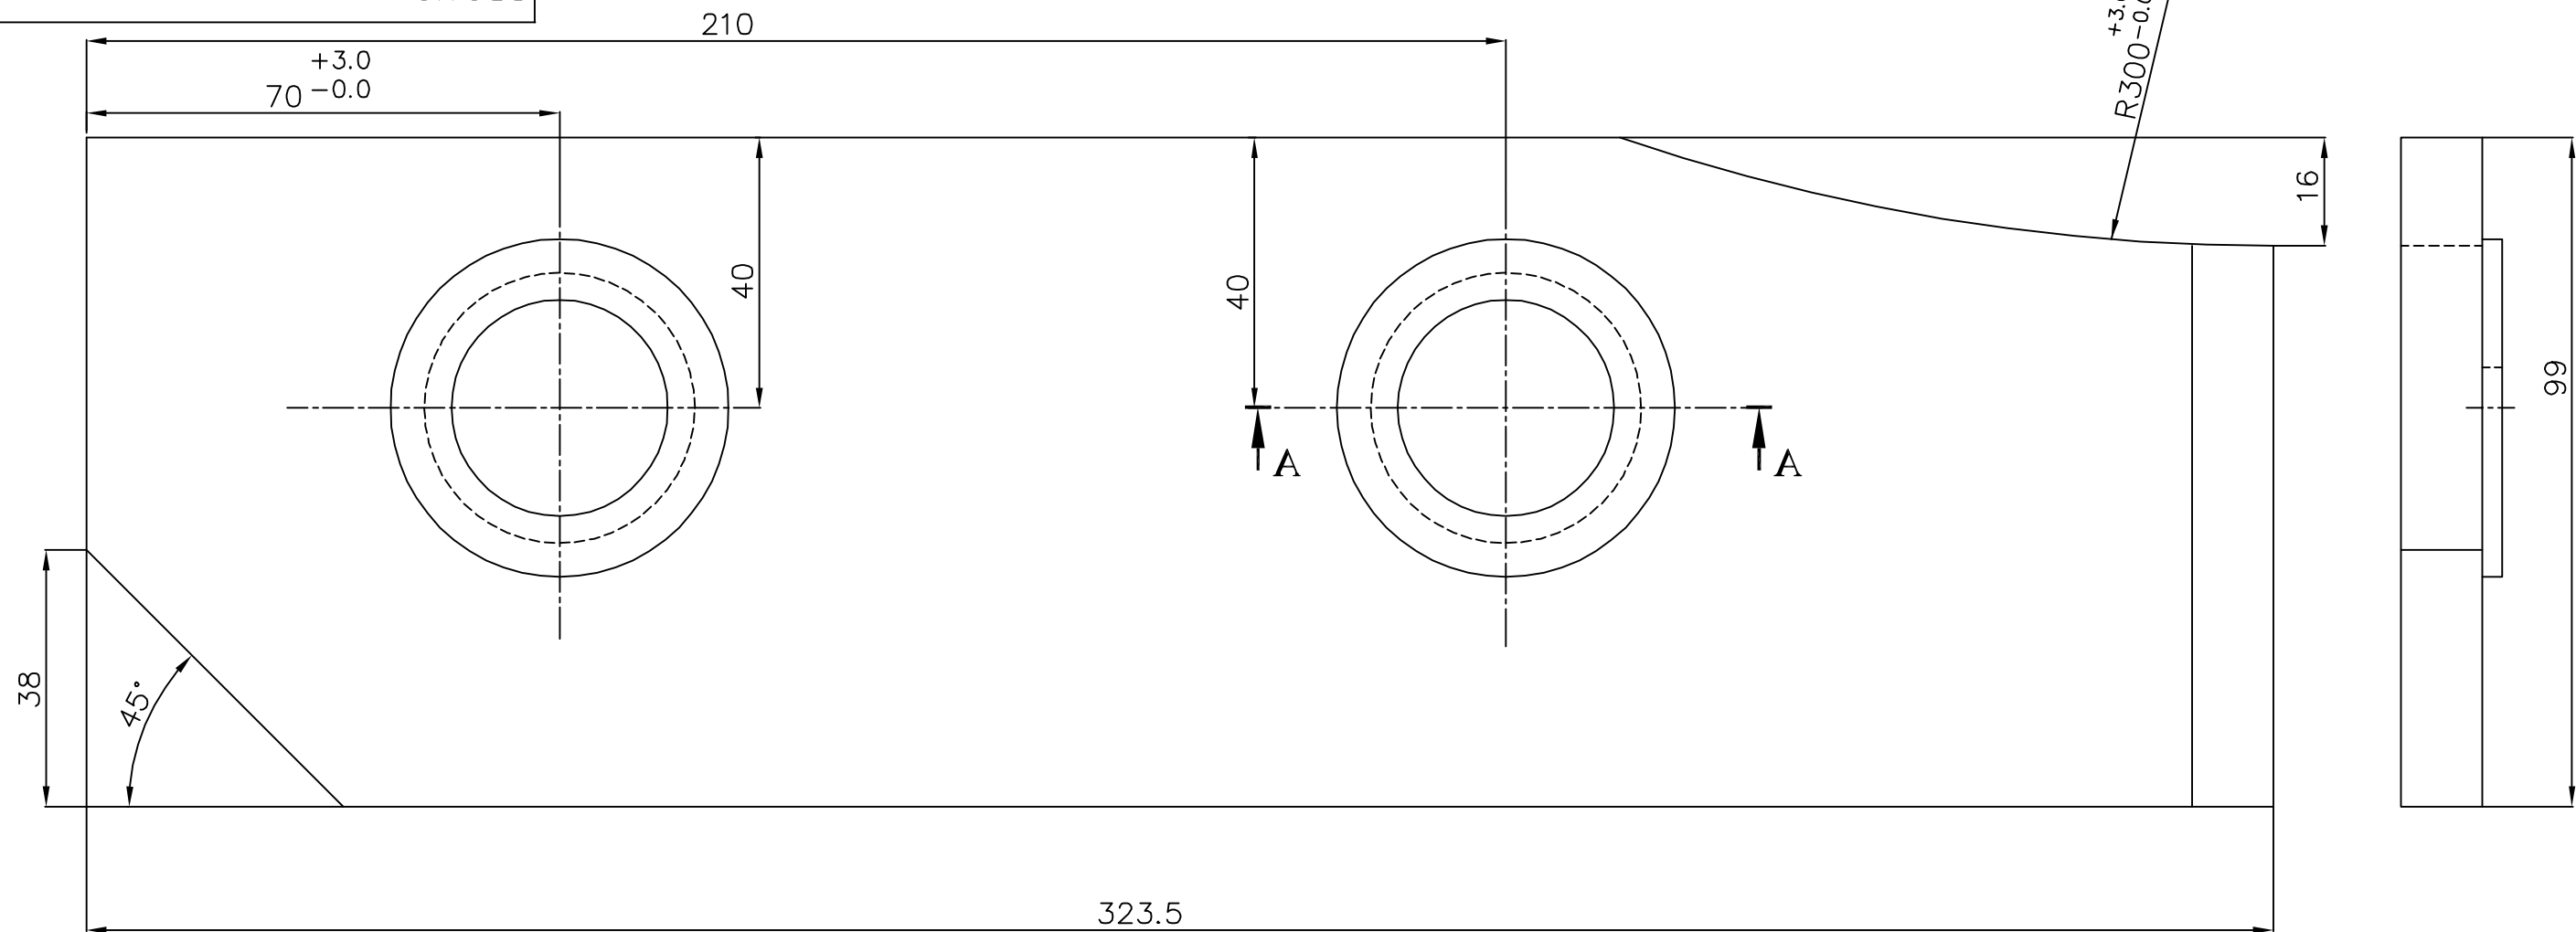

## SECTION-AA

NOTE

- 1.BREAK ALL SHARP EDGES UNLESS OTHERWISE NOTED.  
2.PATTERN NO.3-61-062-00582  
3.CASTING TOLERANCE UNLESS OTHERWISE NOTED  $\pm 1.6$

REV. 05	DATE 17.10.03	ALTERED		REV. 04	DATE 8.11.02	ALTERED	
		CHECKED	APPD.			CHECKED	APPD.
2 CORED HOLES DELETED				DRAWING REDRAWN.			


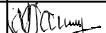

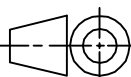
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					AA19741		1
ITEM NO	DESCRIPTION	DRAWING NO.	VAR. NO.	RAW MATERIAL SIZE OR CASTING DRG.NO. OR FORGING DRG.NO.	MATERIAL CODE	NET WT.	GROSS WT.
					MATERIAL SPECN.	QUANTITY	


THE FOLLOWING CONDITIONS APPLY  
EXCEPT OTHERWISE STATED...

1. REF.TO HY0230261 FOR UNSPECIFIED TOLERANCES.
2. CHAMFER M/CD SHARP EDGES  
1.2 TO 1.0 AT 45°.
3. INTERNAL M/CD CORNER RADII  
1 TO 0.7.
4. THE SURFACE ROUGHNESS WHEREVER NOT SHOWN  
SHALL BE TAKEN FROM THE SURFACE ROUGHNESS  
SHOWN OUT SIDE BACK SLASHES GIVEN AT THE  
TOP MOST RIGHT CORNER OF THE DRG.

TYPE OF PRODUCT  
OR  
NAME OF CUSTOMER/PROJECT

623 XRPBM

<div><div>बीएचईएल</div><div></div></div> <div>भारत हेवी इलेक्ट्रिकल्स लिमिटेड हैदराबाद BHARAT HEAVY ELECTRICALS LTD. HYDERABAD</div>		NAME		SIGN.	DATE	NO. OF VAR.	
		DRN.	RAZVI		8.11.02		
		CHD.	NDSAMUEL		8.11.02		
		APPD.	SGHATGE		8.11.02		
DEPT.		SCALE	WEIGHT (KG)	REF. TO ASSY DRG.		ITEM NO.	NO. OF ITEMS
CODE		1:1	2.60	1.61.062.00314			05
TITLE <u>JOURNAL HEAD LINER IV</u>				DRAWING NO. 3-61-062-00582			REV. 05
				SHEET NO.		NO OF SHEETS	

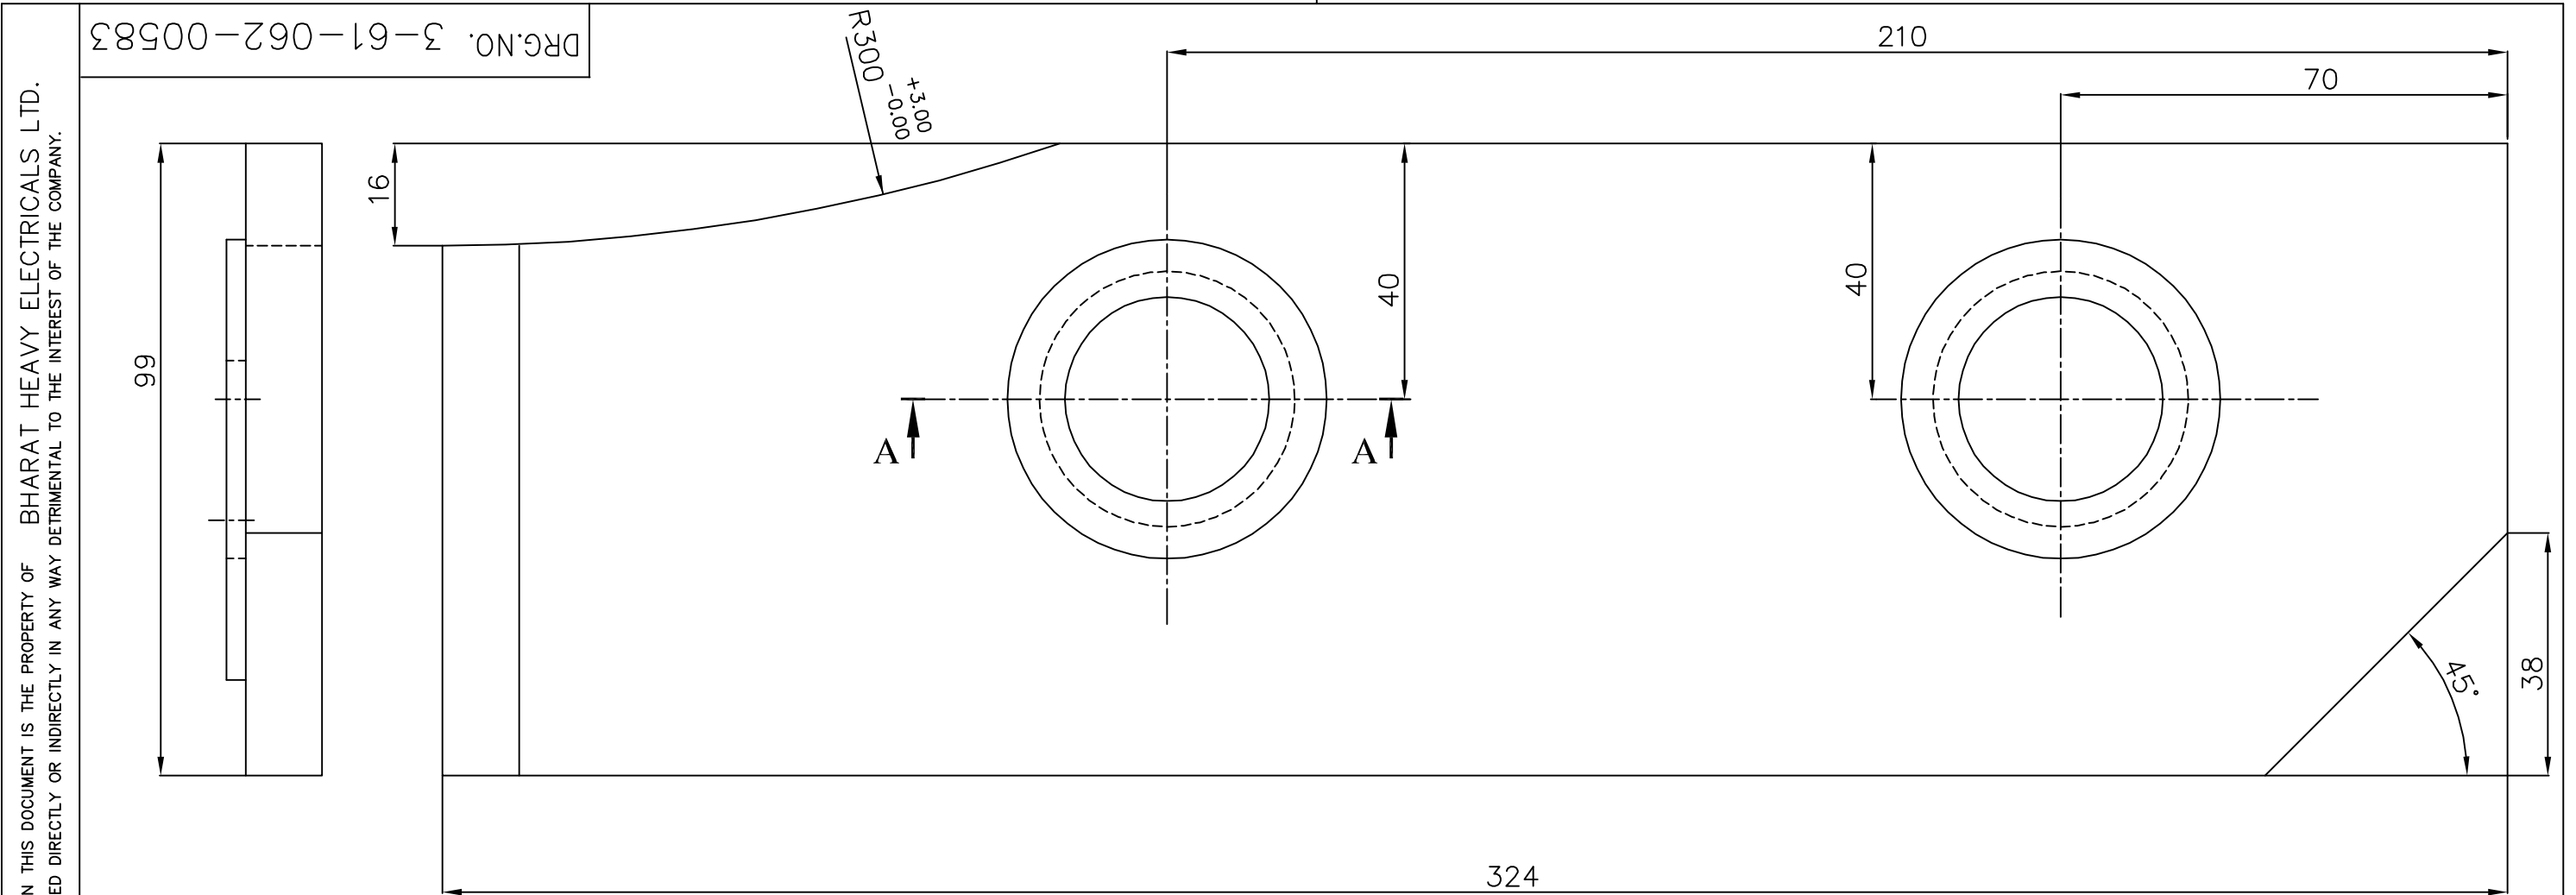


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COMP. FILE NAME  
36100583.DWG

REF.DRG.NO.

INVENTORY NO.

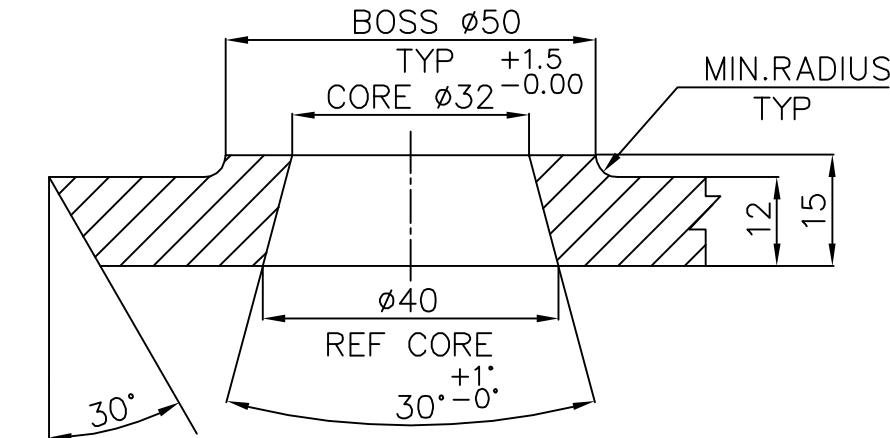


SECTION-AA


NOTE							
1.BREAK ALL SHARP EDGES UNLESS OTHERWISE NOTED.							
2.PATTERN NO.3-61-062-00583							
3.CASTING TOLERANCE UNLESS OTHERWISE NOTED ±1.6							
REV. 05	DATE 17.10.03	ALTERED		REV. 04	DATE 8.11.02	ALTERED	
		CHECKED	APPD.			CHECKED	APPD.
2 CORED HOLES DELETED.				DRAWING REDRAWN.			

01	CASTING			BA9114134020	2.60	
				AA19741		1
ITEM NO	DESCRIPTION	DRAWING NO.	VAR. NO.	RAW MATERIAL SIZE OR CASTING DRG.NO. OR FORGING DRG.NO.	MATERIAL CODE	NET WT. GROSS WT.
					MATERIAL SPECN.	QUANTITY

THE FOLLOWING CONDITIONS APPLY EXCEPT OTHERWISE STATED...

1. REF.TO HY0230261 FOR UNSPECIFIED TOLERANCES.
2. CHAMFER M/CD SHARP EDGES 1.2 TO 1.0 AT 45°.
3. INTERNAL M/CD CORNER RADII 1 TO 0.7.
4. THE SURFACE ROUGHNESS WHEREVER NOT SHOWN SHALL BE TAKEN FROM THE SURFACE ROUGHNESS SHOWN OUT SIDE BACK SLASHES GIVEN AT THE TOP MOST RIGHT CORNER OF THE DRG.

TYPE OF PRODUCT OR NAME OF CUSTOMER/PROJECT							
 भारत हेवी इलेक्ट्रिकल्स लिमिटेड हैदराबाद BHARAT HEAVY ELECTRICALS LTD. HYDERABAD				DRN.	NAME RAZVI	SIGN.	DATE 8.11.02
				CHD.	NDSAMUEL		8.11.02
				APPD.	SGHATGE		8.11.02
DEPT.		SCALE	WEIGHT (KG)	REF. TO ASSY DRG.	ITEM NO.	NO.OF ITEMS	
CODE		1:1	2.60	1.61.062.00314		06	
TITLE JOURNAL HEAD LINER V					DRAWING NO. 3-61-062-00583		REV. 05
					SHEET NO.	NO OF SHEETS	

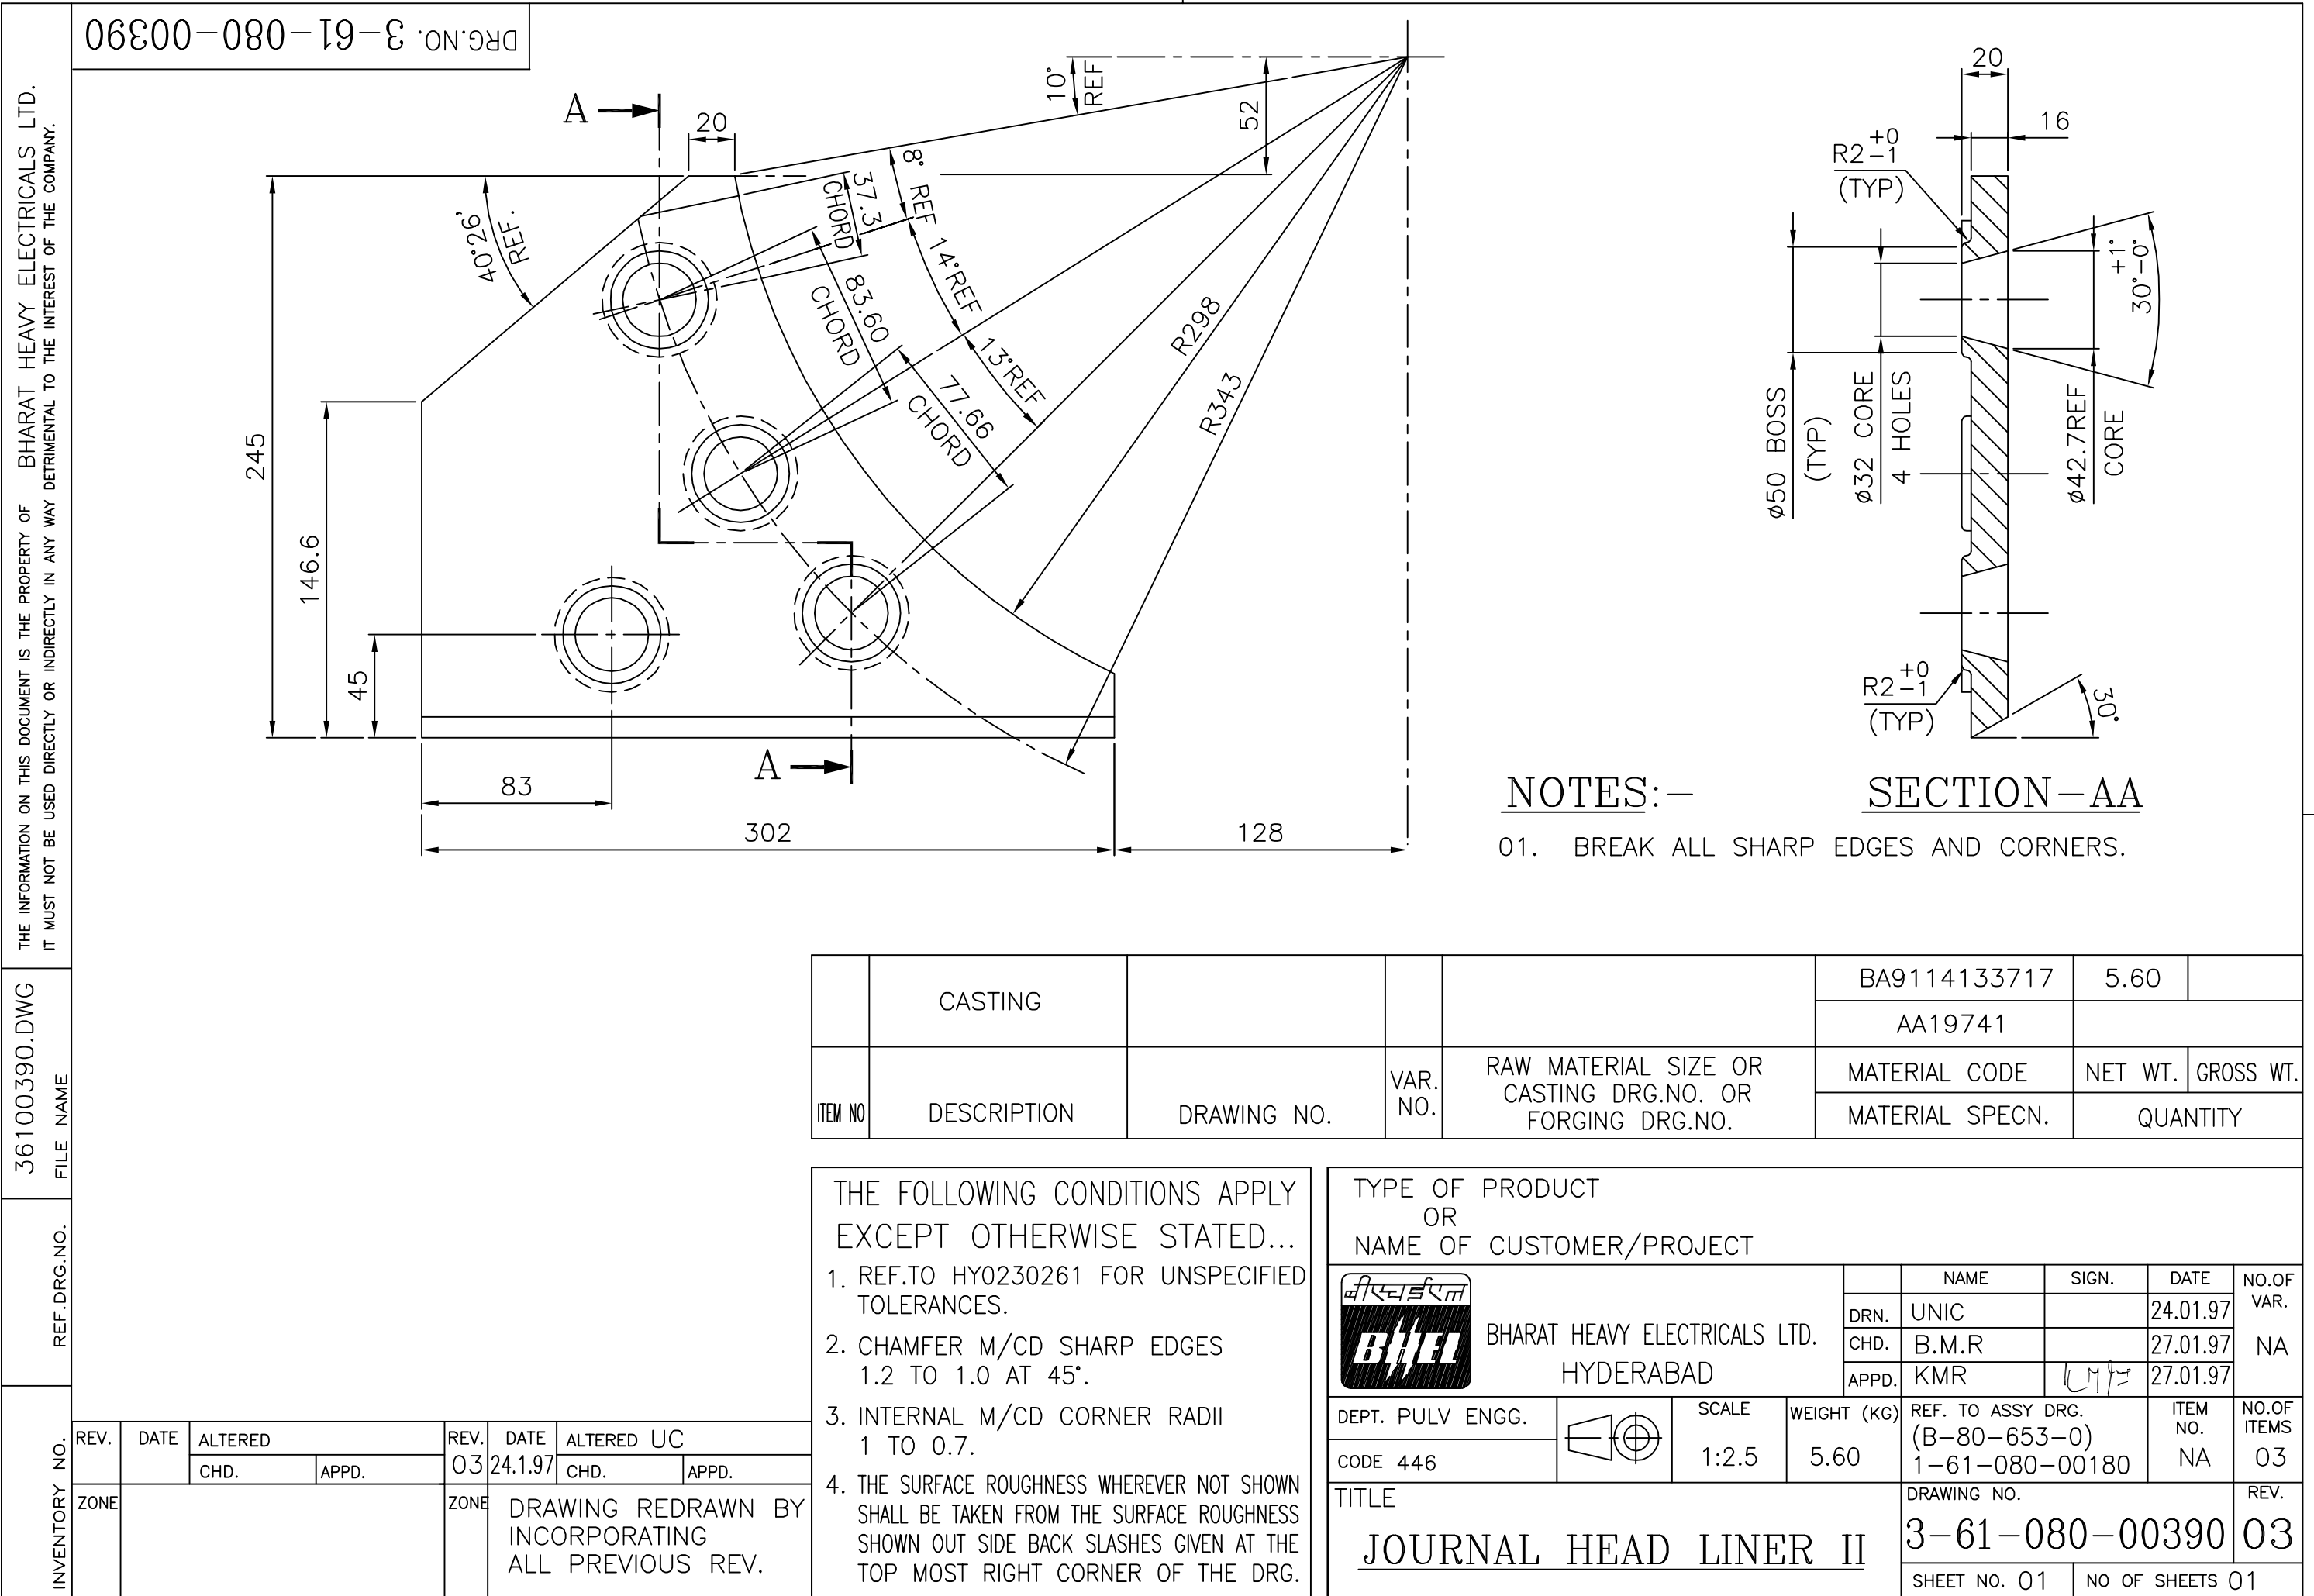



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36100391.DWG  
FILE NAME



REF.DRG.NO.

INVENTORY NO.

FIRST ANGLE PROJECTION

DRG.NO. 3-61-080-00391

(ALL DIMENSIONS ARE IN mm)

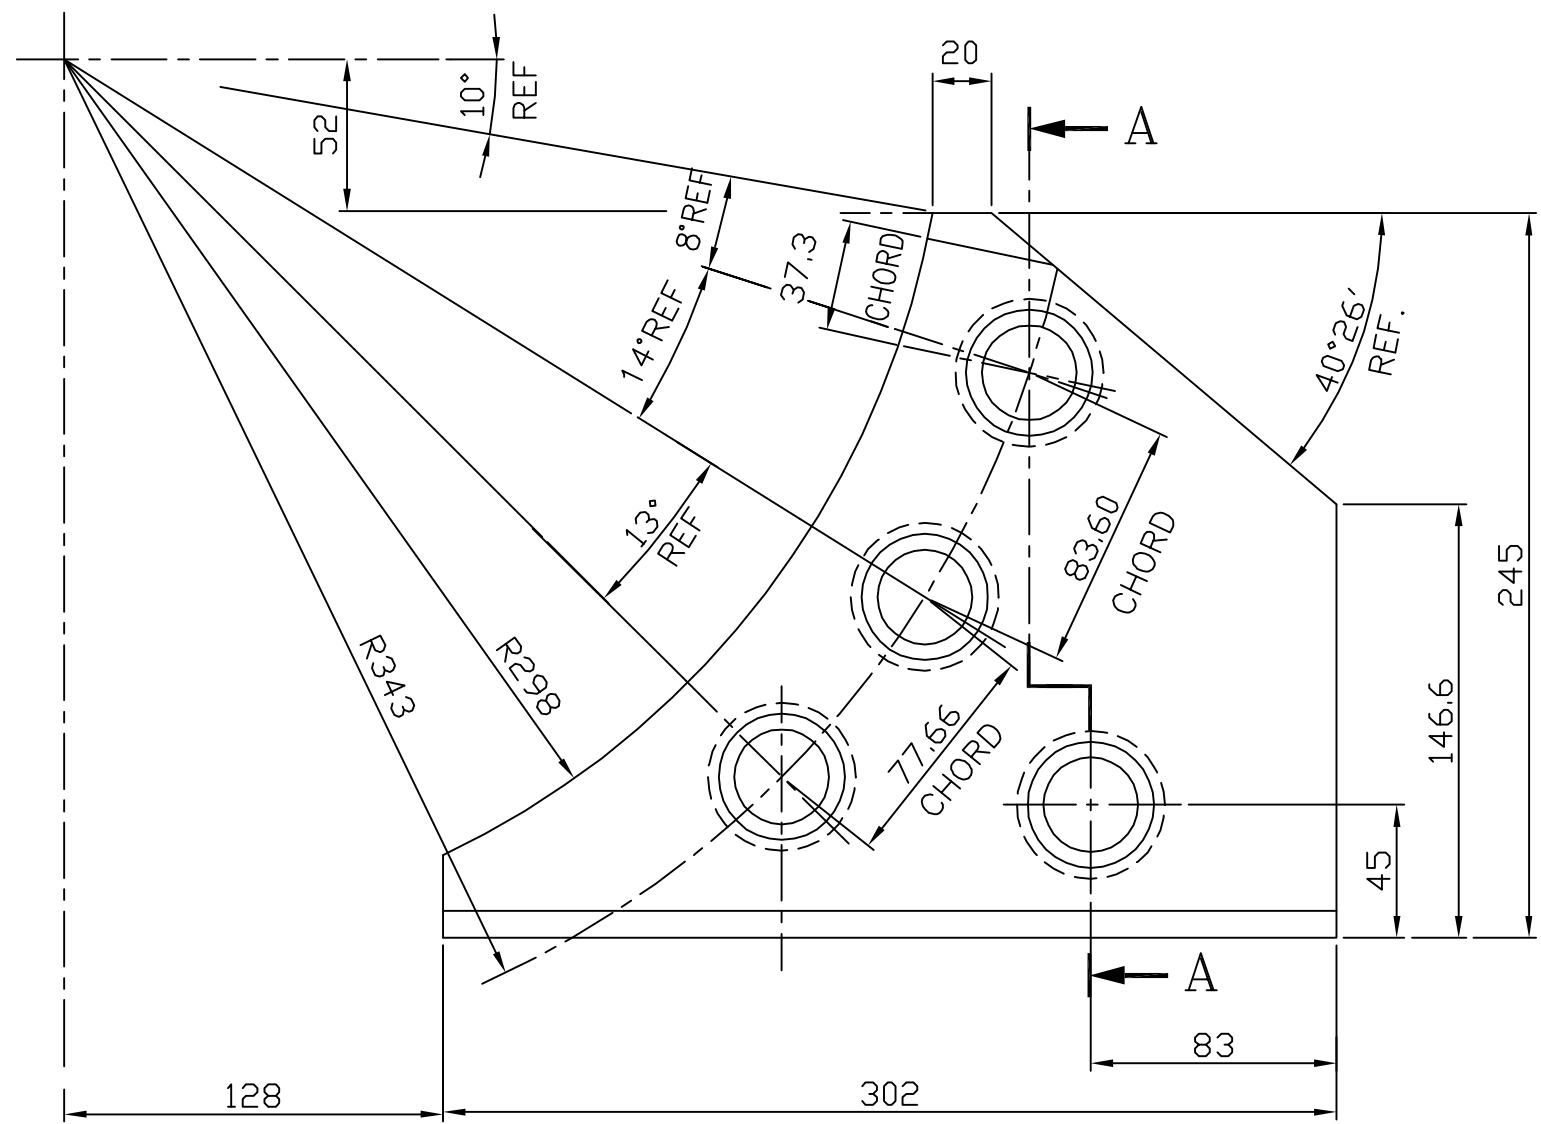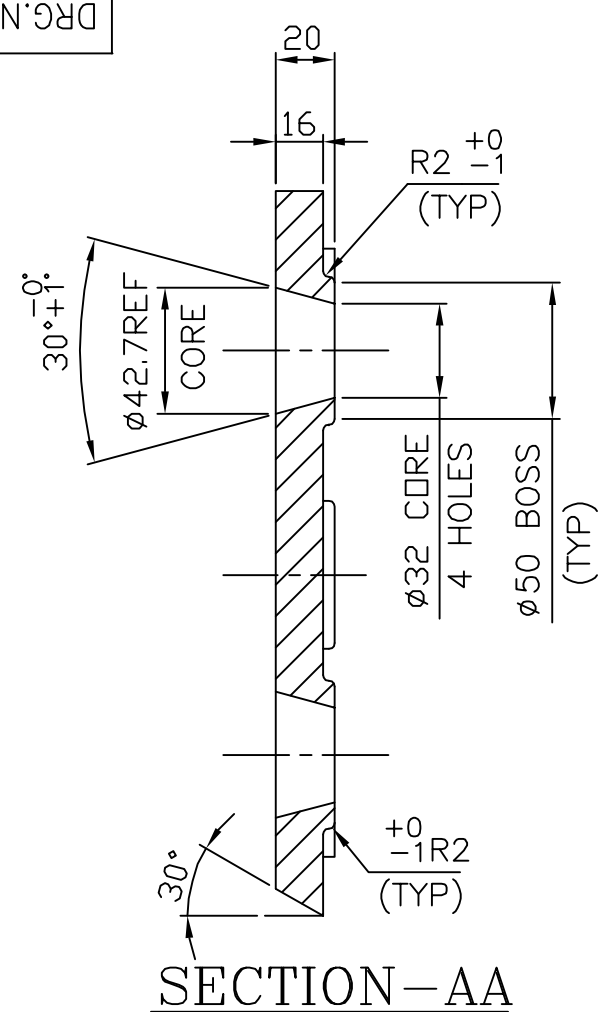


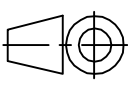
### NOTES:-

- 01. BREAK ALL SHARP EDGES AND CORNERS.
- 02. TOLERANCE UNLESS OTHER WISE NOTED.  
CASTING:  $\pm 1.6$   
ANGULAR:  $\pm 0.6'$

ITEM NO	DESCRIPTION	DRAWING NO.	VAR. NO.	RAW MATERIAL SIZE OR CASTING DRG.NO. OR FORGING DRG.NO.	BA9114133717	5.60	
					AA19741		
					MATERIAL CODE	NET WT.	GROSS WT.
					MATERIAL SPECN.	QUANTITY	

THE FOLLOWING CONDITIONS APPLY EXCEPT OTHERWISE STATED...

- REF.TO HY0230261 FOR UNSPECIFIED TOLERANCES.
- CHAMFER M/CD SHARP EDGES 1.2 TO 1.0 AT 45°.
- INTERNAL M/CD CORNER RADII 1 TO 0.7.
- THE SURFACE ROUGHNESS WHEREVER NOT SHOWN SHALL BE TAKEN FROM THE SURFACE ROUGHNESS SHOWN OUT SIDE BACK SLASHES GIVEN AT THE TOP MOST RIGHT CORNER OF THE DRG.

TYPE OF PRODUCT OR NAME OF CUSTOMER/PROJECT				
		BHARAT HEAVY ELECTRICALS LTD. HYDERABAD		
DEPT. PULV ENGG.		SCALE	WEIGHT (KG)	REF. TO ASSY DRG. (B-80-652-0)
CODE 446		1:2.5	5.60	1-61-080-00180
TITLE		DRAWING NO.		REV.
JOURNAL HEAD LINER III		3-61-080-00391		03
		SHEET NO. 01		NO OF SHEETS 01

REV.	DATE	ALTERED	REV.	DATE	ALTERED
03	23.3.04	CHD. APPD.	03	23.3.04	CHD. APPD.
ZONE		DRAWING REDRAWN ON AUTOCAD INCORPORATING EARLIEAR CHANGES			


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COMP. FILE NAME  
36100392.DWG


REF.DRG.NO.

INVENTORY NO.

DRG.NO. 3-61-080-00392

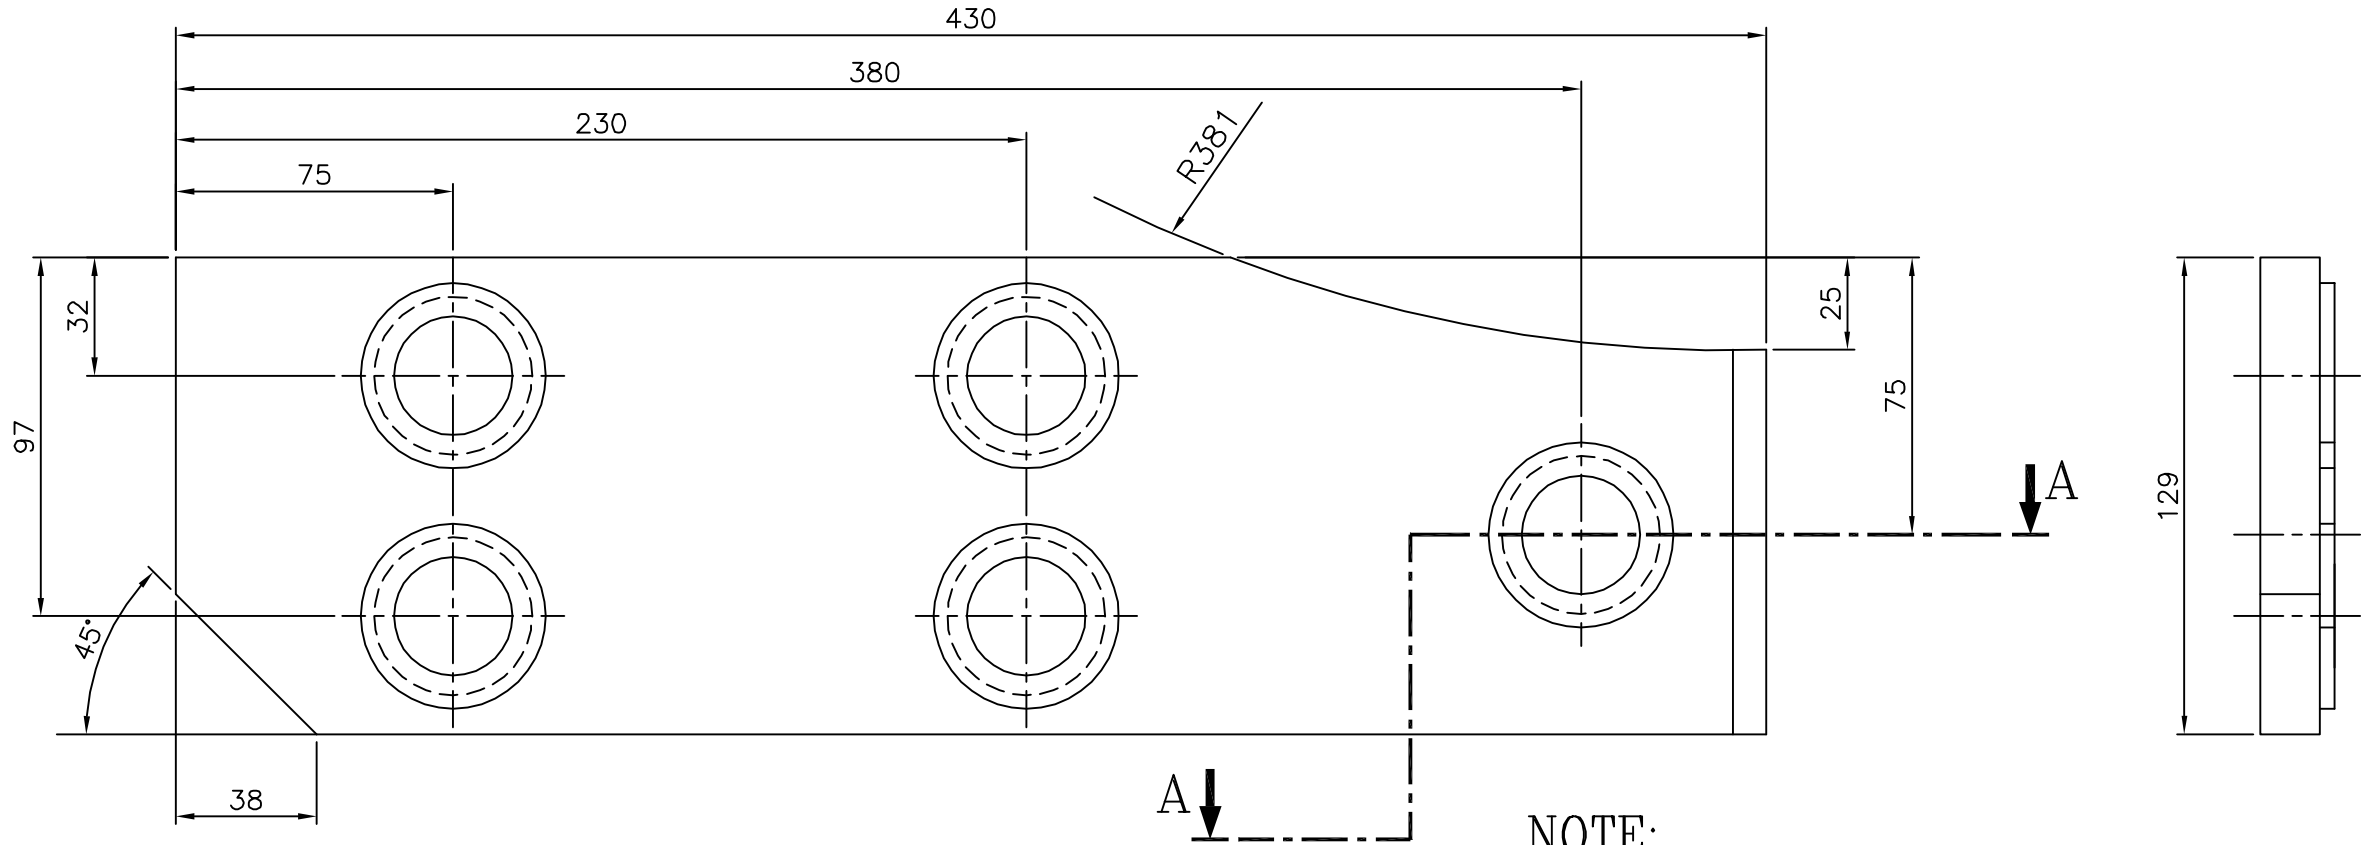


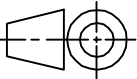
- NOTE:**
- 1. BREAK ALL SHARP EDGES AND CORNERS.
  - 2. TOLERANCE, UNLESS OTHERWISE NOTED,  
CASTING : ±1.5  
ANGULAR : ±0°6'

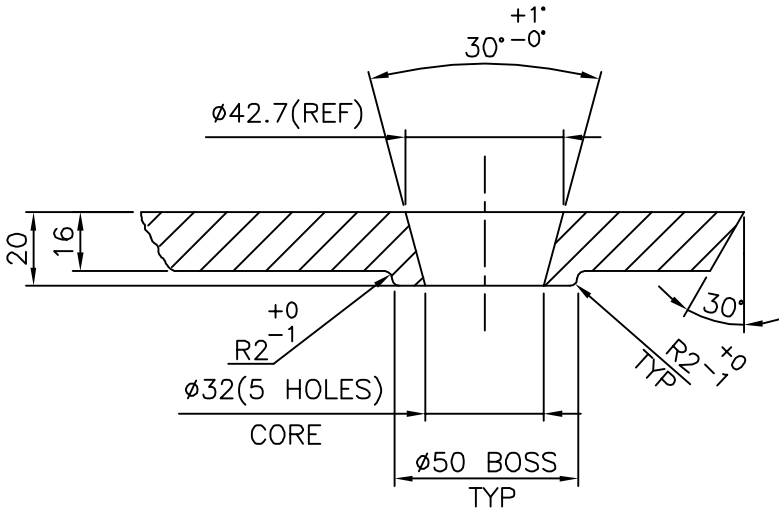

**SECTION A-A**  
(SCALE 2:5)

1	CASTING				BA9114133733	7.20	
					AA19741		1
ITEM NO	DESCRIPTION	DRAWING NO.	VAR. NO.	RAW MATERIAL SIZE OR CASTING DRG.NO. OR FORGING DRG.NO.	MATERIAL CODE	NET WT.	GROSS WT.
					MATERIAL SPECN.	QUANTITY	

- THE FOLLOWING CONDITIONS APPLY EXCEPT OTHERWISE STATED...
1. REF.TO HY0230261 FOR UNSPECIFIED TOLERANCES.
  2. CHAMFER M/CD SHARP EDGES 1.2 TO 1.0 AT 45°.
  3. INTERNAL M/CD CORNER RADII 1 TO 0.7.
  4. THE SURFACE ROUGHNESS WHEREVER NOT SHOWN SHALL BE TAKEN FROM THE SURFACE ROUGHNESS SHOWN OUT SIDE BACK SLASHES GIVEN AT THE TOP MOST RIGHT CORNER OF THE DRG.

TYPE OF PRODUCT OR NAME OF CUSTOMER/PROJECT								
<div></div> <div>BHARAT HEAVY ELECTRICALS LTD. HYDERABAD</div>					NAME	SIGN.	DATE	NO.OF VAR.
				DRN.	ASHOK		06.06.84	
					CHD.	AMAN		02.08.84
	APPD.	S.G		12.11.84				
DEPT. PULV-ENGG		SCALE 1:2 2:5	WEIGHT (KG)  7.20	REF. TO ASSY DRG. (B-80-651-0) 1-61-080-00180		ITEM NO. 05	NO.OF ITEMS NA	
CODE 4460								
TITLE  JOURNAL HEAD LINER IV				DRAWING NO. 3-61-080-00392			REV. 04	
				SHEET NO. 01		NO OF SHEETS 01		

DRAWING IS REDRAWN ON ACAD INCORPORATING ALL PREVIOUS REVISIONS.



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COMP. FILE NAME  
36100393.DWG

REF.DRG.NO.


INVENTORY NO.

DRG.NO. 3-61-080-00393

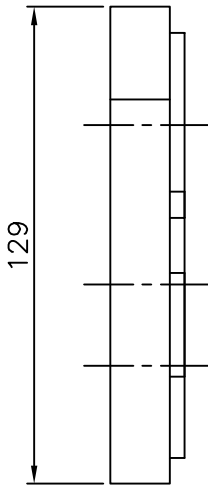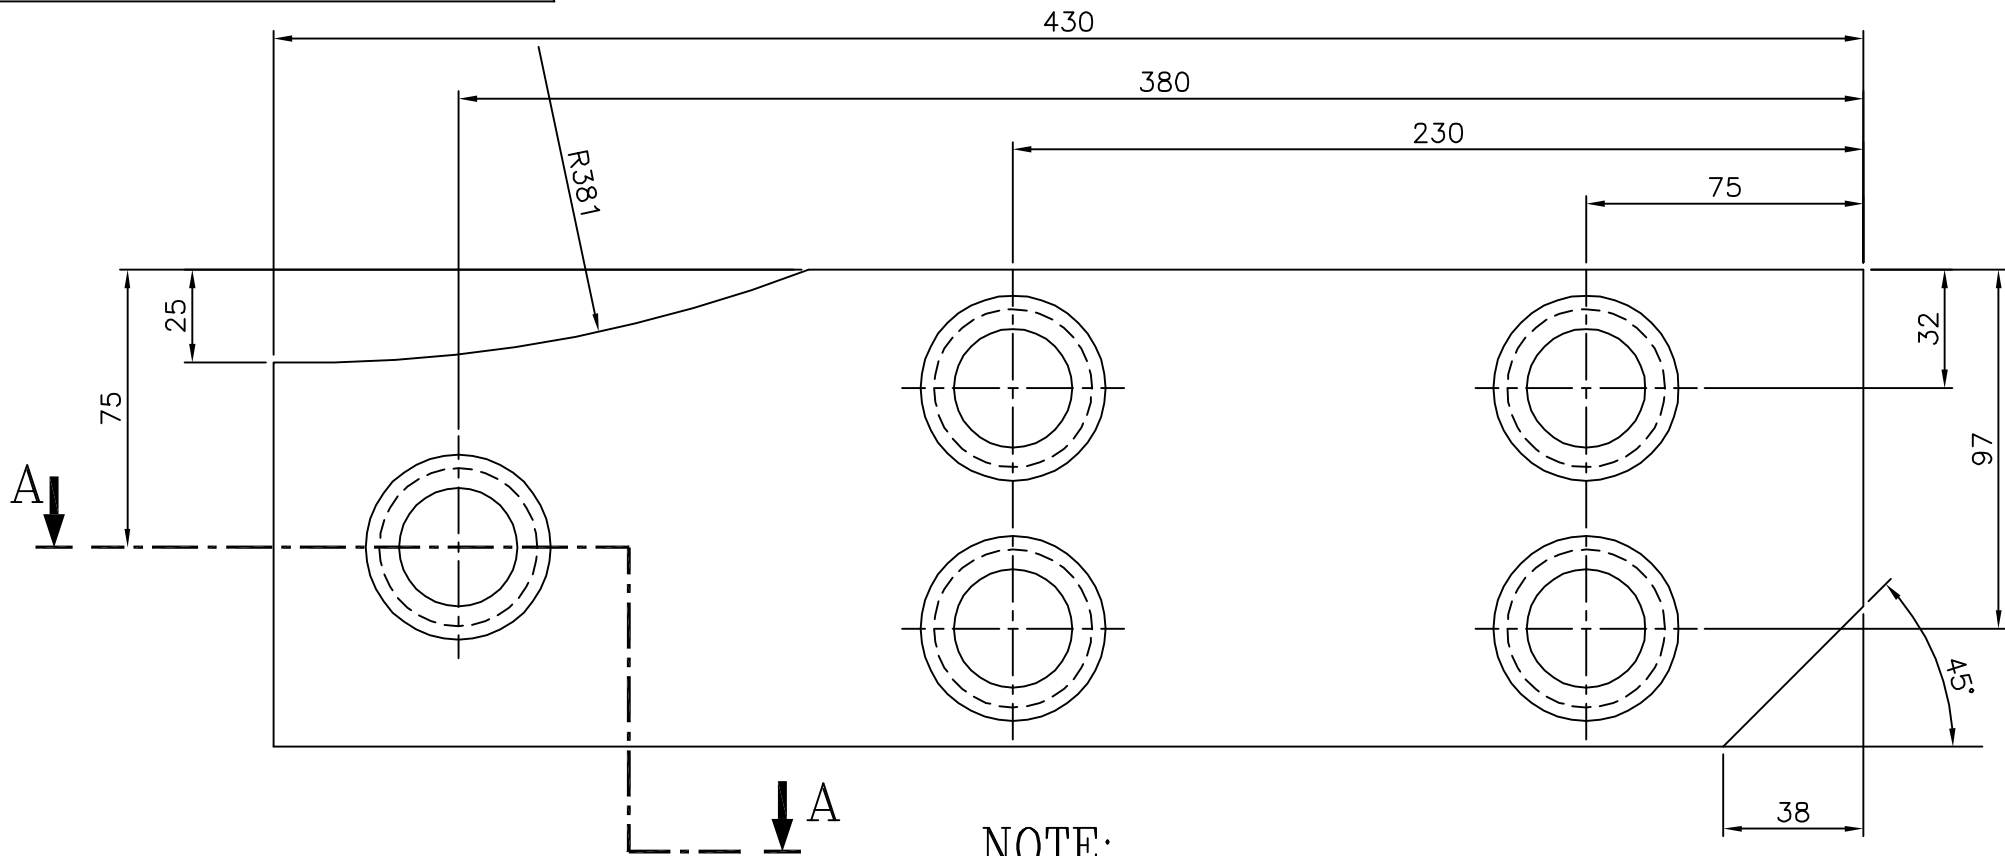

NOTE:

- 1. BREAK ALL SHARP EDGES AND CORNERS.
- 2. TOLERANCE, UNLESS OTHERWISE NOTED,  
CASTING : ±1.5  
ANGULAR : ±0°6'

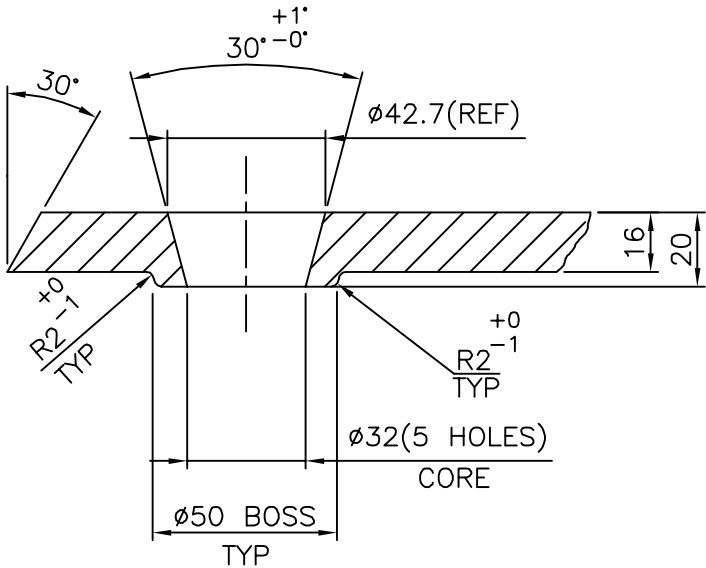
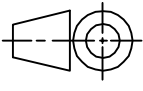


SECTION A-A  
(SCALE 2:5)

ITEM NO	DESCRIPTION	DRAWING NO.	VAR. NO.	RAW MATERIAL SIZE OR CASTING DRG.NO. OR FORGING DRG.NO.	BA9114133741	7.20	
					AA19741		
					MATERIAL CODE	NET WT.	GROSS WT.
					MATERIAL SPECN.	QUANTITY	

THE FOLLOWING CONDITIONS APPLY EXCEPT OTHERWISE STATED...



- 1. REF.TO HY0230261 FOR UNSPECIFIED TOLERANCES.
- 2. CHAMFER M/CD SHARP EDGES 1.2 TO 1.0 AT 45°.
- 3. INTERNAL M/CD CORNER RADII 1 TO 0.7.
- 4. THE SURFACE ROUGHNESS WHEREVER NOT SHOWN SHALL BE TAKEN FROM THE SURFACE ROUGHNESS SHOWN OUT SIDE BACK SLASHES GIVEN AT THE TOP MOST RIGHT CORNER OF THE DRG.

TYPE OF PRODUCT OR NAME OF CUSTOMER/PROJECT								
<div>BHARAT HEAVY ELECTRICALS LTD. HYDERABAD</div>					NAME	SIGN.	DATE	NO.OF VAR.
				DRN.	ASHOK		06.06.84	
					CHD.	AMAN		02.08.84
	APPD.	S.G		12.11.84				
DEPT. PULV-ENGG		SCALE 1:2 2:5	WEIGHT (KG)  7.20	REF. TO ASSY DRG. 1-61-080-00180 (B-80-650-0)		ITEM NO. 06	NO.OF ITEMS NA	
CODE 4460								
TITLE <u>JOURNAL HEAD LINER V</u>				DRAWING NO. 3-61-080-00393			REV. 04	
				SHEET NO. 01		NO OF SHEETS 01		

FIRST ANGLE PROJECTION

(ALL DIMENSIONS ARE IN mm)

DRG. NO. 3-61-304-02337

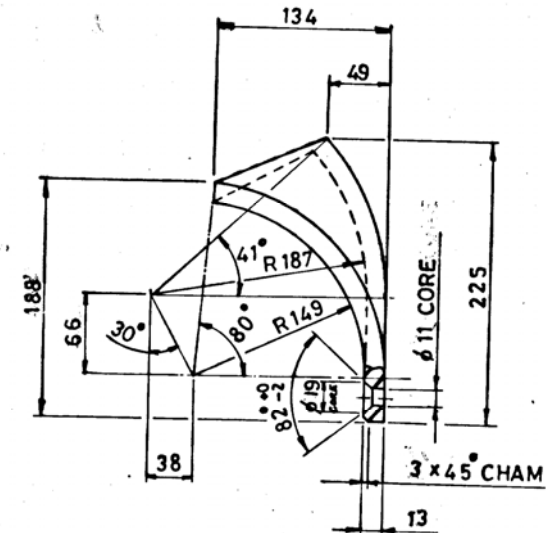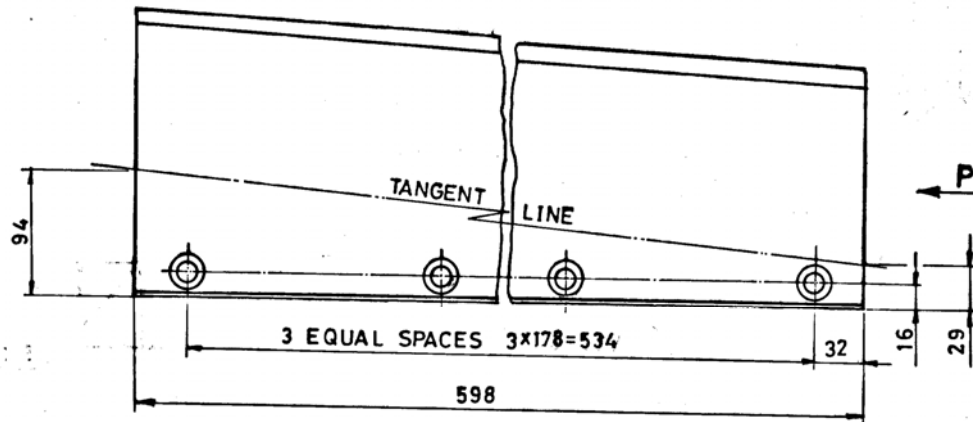

VIEW-P

NOTE:

1. BREAK ALL SHARP EDGES AND CORNERS.
2. CORED HOLES ARE TO BE CLEANED AND FREE FROM FINS AND SAND.
3. DIMENSIONS & LOCATIONS OF THE CORED HOLES ARE TO BE ENSURED WITH A TEMPLATE.

REFER PLANT STANDARD  
HY 0230261 FOR  
UNSPECIFIED TOLERANCES

VAR. 00		REMARKS		ITEM NO.		DESCRIPTION		DRAWING NO.		MATL. CODE		UNIT WT.		QTY.	
59		64		75		78		79		84		85		86	
28		28		28		28		28		28		28		28	
CARD TYPE-3		CARD TYPE-2		CARD TYPE-1		CARD TYPE-1		CARD TYPE-1		CARD TYPE-1		CARD TYPE-1		CARD TYPE-1	
ADDITIONAL INFORMATION		STATUS OF DRAWING		DISTRIBUTION OF PRINTS		TYPE OF PRODUCT OR NAME OF CUSTOMER/PROJECT		CHANDRAPUR 500 MW		NAME D C		SIGN.		DATE	
Bharat Heavy Electricals Ltd.		HYDERABAD		DEPT. PULV ENG		GRADE OF TOL. DIM. C/M/F		SCALE NTS		WEIGHT (Kg) 13.00		REF. TO ASSY. DRG. C GP-2959		ITEM NO. 75	
CODE 446		C/M/F		NTS		13.00		C GP-2959		DRAWING NO. 3-61-304-02337		REV. 00		SHEET NO. 01	
NO. OF SHEETS 01		NO. OF SHEETS 01		NO. OF SHEETS 01		NO. OF SHEETS 01		NO. OF SHEETS 01		NO. OF SHEETS 01		NO. OF SHEETS 01		NO. OF SHEETS 01	

TD-151. REV. NO. 2

SIZE A 3

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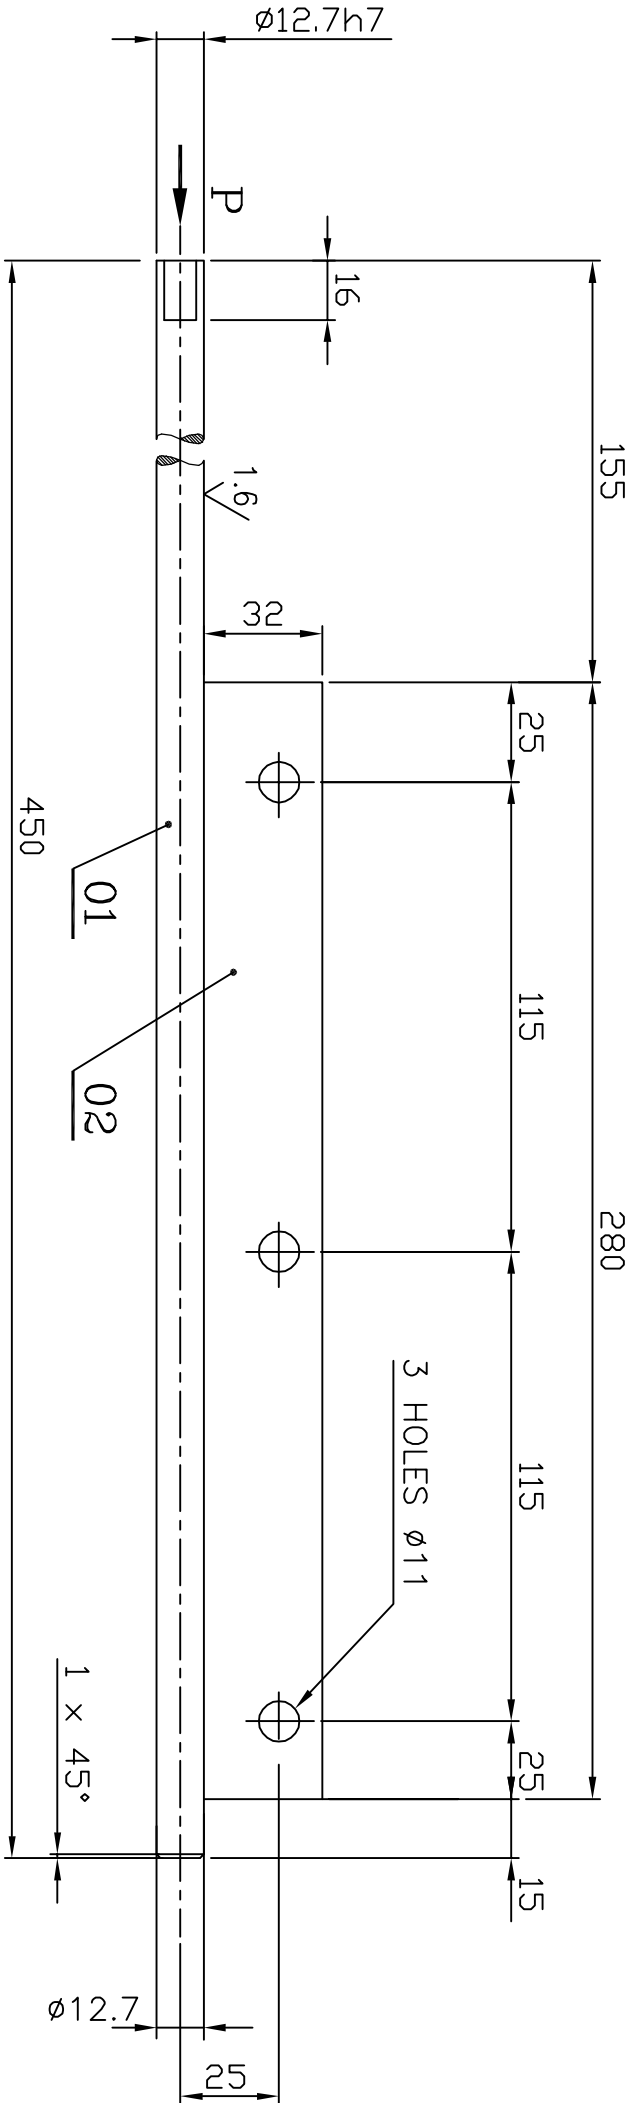
INVENTORY NO. SIGN. & DATE REF. DRG. NO.

REV.	DATE	ALTERED	REV.	DATE	ALTERED	REV.	DATE	ALTERED
		CHECKED			CHECKED			CHECKED
ZONE			ZONE			ZONE		

36100653.DWG

WPS No. WE 006

12.5/6.3/1.6



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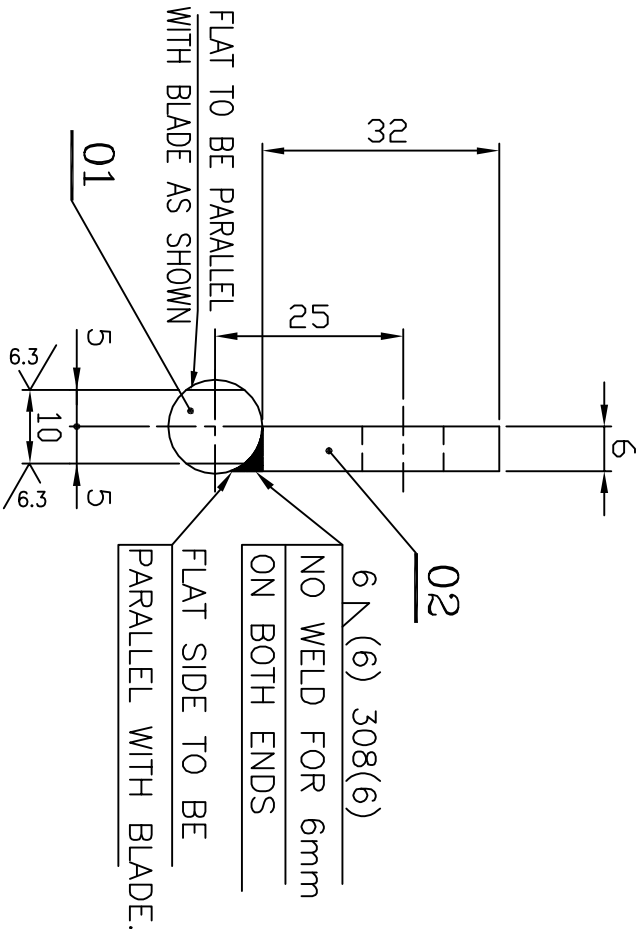
36100653.DWG  
FILE NAME

REF.DRG.NO.

INVENTORY NO.

REV.	DATE	ALTERED	REV.	DATE	ALTERED
02	22.12.05	CHD. N.D.S	01	2.11.02	CHD. N.D.S
ZONE	Ø8X12 STEP REMOVED. Ø12.7 h7 WAS Ø12.7±0.01.	ZONE	DRG.RETRACED.		

VIEW-P



02	PL. 6x32x280			AA 1011808030	0.420	
01	ROD Ø16x455			AA 10108		1
				HY 1010299086	0.440	
				HY 10199		1
ITEM NO	DESCRIPTION	DRAWING NO.	VAR. NO.	RAW MATERIAL SIZE OR CASTING DRG.NO. OR FORGING DRG.NO.	MATERIAL CODE	NET WT. GROSS WT. QUANTITY

THE FOLLOWING CONDITIONS APPLY EXCEPT OTHERWISE STATED...  
1. REF.TO HY0230261 FOR UNSPECIFIED TOLERANCES.  
2. CHAMFER M/CD SHARP EDGES 1.2 TO 1.0 AT 45°.  
3. INTERNAL M/CD CORNER RADII 1 TO 0.7.  
4. THE SURFACE ROUGHNESS WHEREVER NOT SHOWN SHALL BE TAKEN FROM THE SURFACE ROUGHNESS SHOWN OUT SIDE BACK SLASHES GIVEN AT THE TOP MOST RIGHT CORNER OF THE DRG.

TYPE OF PRODUCT OR NAME OF CUSTOMER/PROJECT		BHARAT HEAVY ELECTRICALS LTD. HYDERABAD		SCALE N.T.S		WEIGHT (KG) 0.860		REF. TO ASSY DRG.		ITEM NO. NA		NO.OF ITEMS NA	
DEPT. B.M.D		CODE 446		TITLE DEFLECTOR HINGED SHAFT		DRAWING NO. 3-61-362-00653		SHEET NO. 01		NO OF SHEETS 01		REV. 02	



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36100375.DWG  
FILE NAME


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REF.DRG.NO.

INVENTORY NO.


DRG.NO. 3-61-380-00375

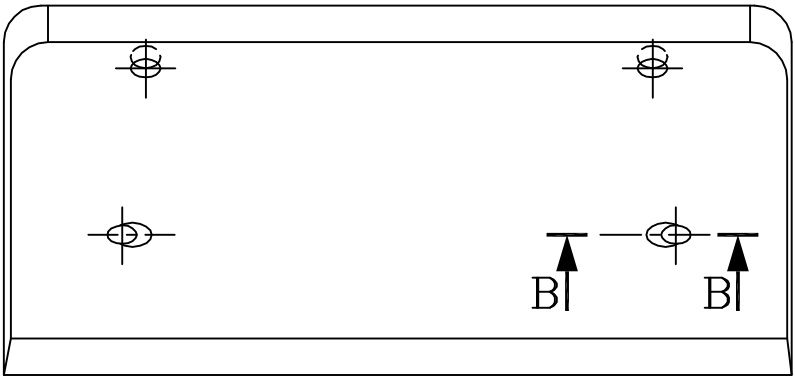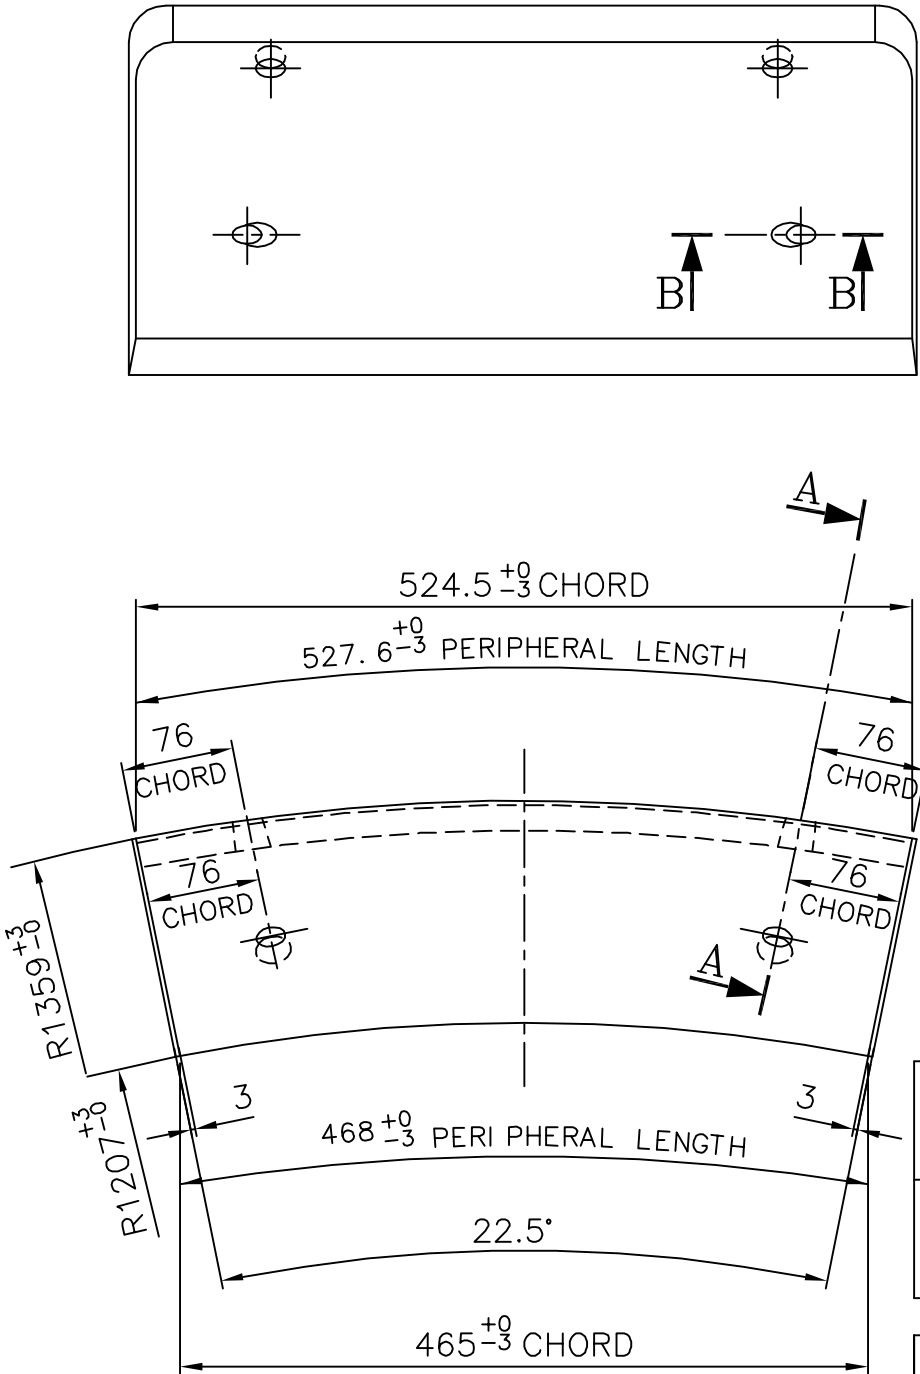

CAST PATTERN NO. 3-61-380-00375  
THIS SIDE 3mm MAX. HEIGHT  
IF RAISED LETTERS ARE USED

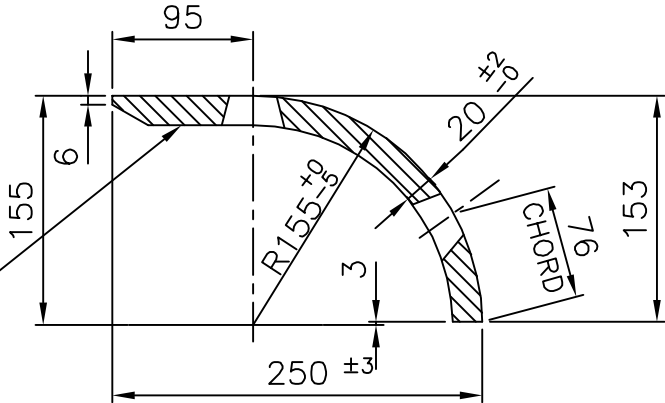

SECTION-AA

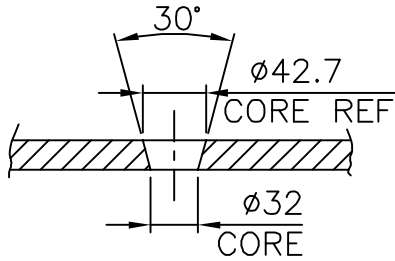

SECTION-BB  
(4 PLACES)

NOTES:-

01. BREAK ALL SHARP EDGES & CORNERS  
UNLESS OTHERWISE NOTED.

ITEM NO	DESCRIPTION	DRAWING NO.	VAR. NO.	RAW MATERIAL SIZE OR CASTING DRG.NO. OR FORGING DRG.NO.	BA9114133474	25.10	
					AA19741		
					MATERIAL CODE	NET WT.	GROSS WT.
					MATERIAL SPECN.	QUANTITY	

THE FOLLOWING CONDITIONS APPLY EXCEPT OTHERWISE STATED...

- REF.TO HY0230261 FOR UNSPECIFIED TOLERANCES.
- CHAMFER M/CD SHARP EDGES 1.2 TO 1.0 AT 45°.
- INTERNAL M/CD CORNER RADII 1 TO 0.7.
- THE SURFACE ROUGHNESS WHEREVER NOT SHOWN SHALL BE TAKEN FROM THE SURFACE ROUGHNESS SHOWN OUT SIDE BACK SLASHES GIVEN AT THE TOP MOST RIGHT CORNER OF THE DRG.


TYPE OF PRODUCT OR NAME OF CUSTOMER/PROJECT



BHARAT HEAVY ELECTRICALS LTD.  
HYDERABAD

DEPT. PULV ENGG.

CODE 446

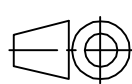

SCALE

1:5

WEIGHT (KG)

2510

NAME	SIGN.	DATE	NO.OF VAR.
DRN. UNIC		05.08.97	
CHD. B.M.R		10.09.97	
APPD. K.M.R		10.09.97	

REF. TO ASSY DRG. (C-80-481-0)

ITEM NO.

NO.OF ITEMS

01

TITLE  
**SEPARATOR TOP LINER**

DRAWING NO.

**3-61-380-00375**

REV.

**03**

SHEET NO. 01




NO OF SHEETS 01



FIRST ANGLE PROJECTION

(ALL DIMENSIONS ARE IN mm)


DRG. NO. 3-61-388-02019

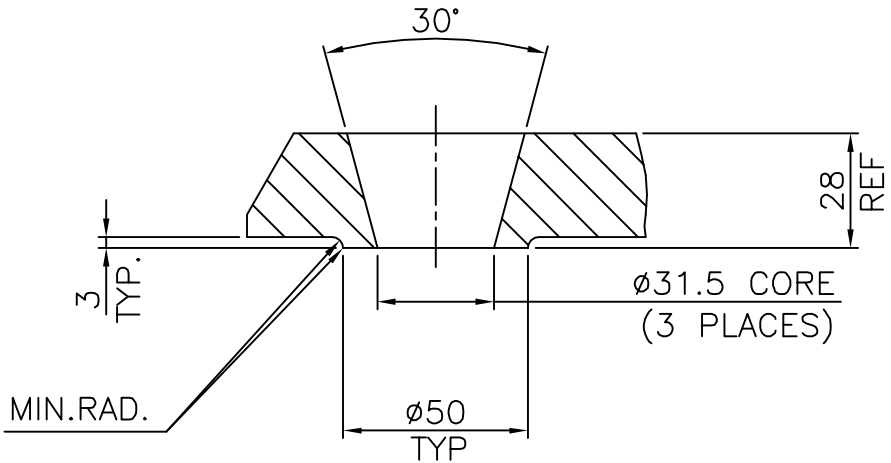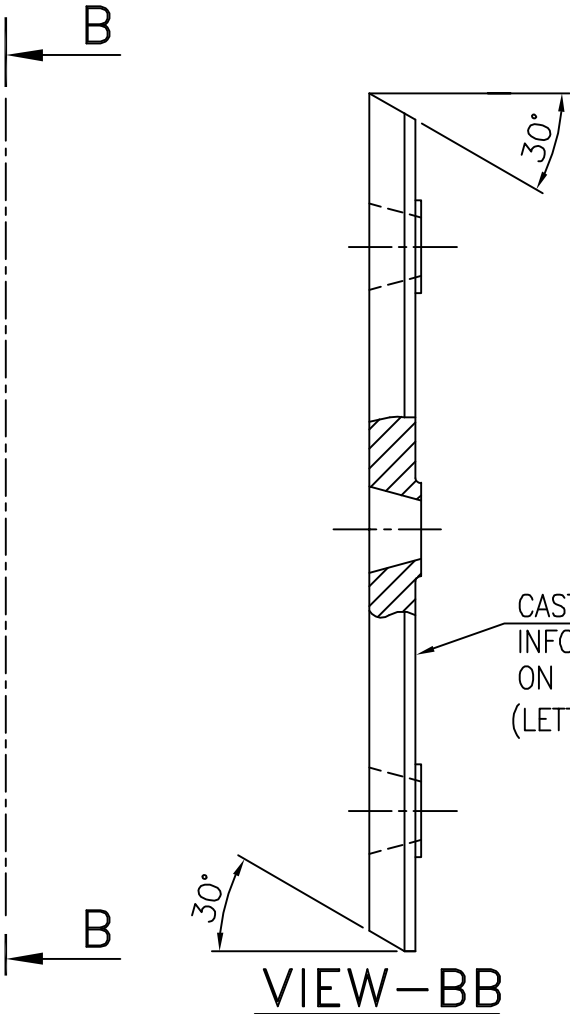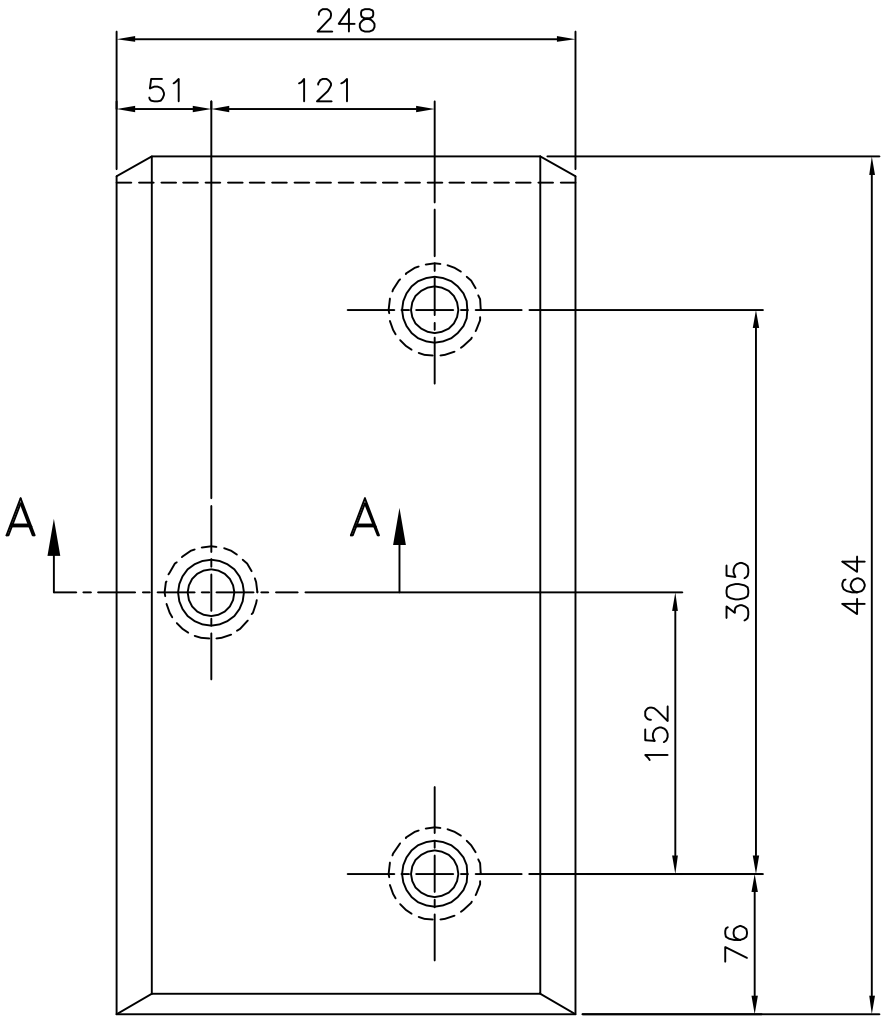

SECTION-AA

NOTE:-

1. ALL RADII TO BE R1.5 UNLESS OTHERWISE SPECIFIED.
2. CASTING TOL. SHOULD BE WITH IN +0.0 -1.6 ANGULER 0°6'
3. PATTERN NO. 3-61-388-02019.
4. BREAK ALL SHARP EDGES & CORNERS UNLESS OTHERWISE NOTED.

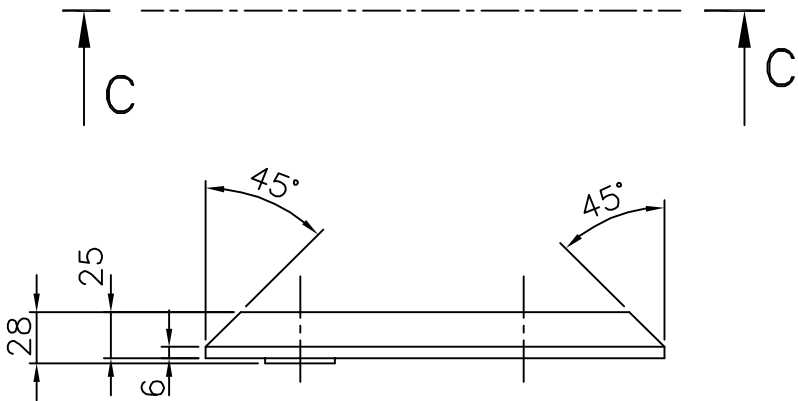

VIEW-CC

01	CASTING				BA9114134845	22.0	
					AA19741		1
ITEM NO.	DESCRIPTION	DRAWING NO.	VAR. NO.	RAW MATERIAL SIZE OR CASTING DRG. NO. OR FORGING DRG. NO.	MATERIAL CODE	NET WT.	GROSS WT.
					MATERIAL SPECN.	QUANTITY	

THE FOLLOWING CONDITIONS APPLY EXCEPT OTHERWISE STATED.				TYPE OF PRODUCT				883 XRP BOWL MILL			
1. REF. TO HY0230261 FOR UNSPECIFIED TOLERANCES.				NAME OF CUSTOMER/PROJECT							
2. CHAMFER M/CD. SHARP EDGES 1.2 TO 1.0 AT 45°.				BHARAT HEAVY ELECTRICALS LIMITED				DRN.			
3. INTERNAL M/CD. CORNER RADII 1 TO 0.7				HYDERABAD				CHD.			
4. THE SURFACE ROUGHNESS WHERE-EVER NOT SHOWN SHALL BE TAKEN FROM THE SURFACE ROUGHNESS SHOWN OUT SIDE THE BACK SLASH GIVEN OR THE TOP MOST RIGHT CORNER OF THE DRG.				APPD.				TMRAO			
				DEPT. PULV ENGG.				NAME			
				CODE 446				SIGN.			
				UNTOL. DIMS. GR.				DATE			
				SCALE 1:4				NO.OF VAR.			
				WEIGHT (KG) 22.00				REF. TO ASSY DRG.			
				TITLE				ITEM NO. 3			
				JOURNAL OPENING				NO.OF ITEMS 15			
				FRAME LINER-III				DRAWING NO.			
								3-61-388-02019			
								REV. 01			
								SHEET NO. 01			
								NO OF SHEETS 01			



1. PRIOR TO WELDING, PROPER SURFACE PREPARATION OF THE BASE METAL MUST BE MADE. WIRE BRUSHING OR GRINDING MAY BE USED TO REMOVE ANY RUST, SCALE, SLAG, PAINT OR OTHER FOREIGN MATTER.
2. ALL WELDERS USED TO INSTALL THESE PLUG WELDS MUST DEMONSTRATE THE ABILITY TO MAKE SOUND WELDS BY WELDING THREE (3) TEST PLUGS. THE WELDS SHOULD BE EXAMINED BY SECTIONING THROUGH EACH WELD. EACH SECTION SHALL BE POLISHED AND ETCHED AND EXAMINED FOR ADEQUATE FUSION: NO LACK OF FUSION WILL BE ALLOWED.
3. PLUGS MUST BE LIGHTLY SEATED INTO THE LINER TO ENSURE THAT THEY DO NOT FALL OUT DURING HANDLING. DO NOT FORCE THE PLUG TO ROTATE OUT IN THE LINER. THIS CAN CAUSE LINER BREAKAGE.
4. IT IS RECOMMENDED THAT THE SHIELDED METAL ARC PROCESS BE USED. A 3/32 DIA. E-6010 ELECTRODE IS RECOMMENDED FOR MAXIMUM PENETRATION. RECOMMENDED AMPERAGE 60-90 AMPS, 10-28 VOLTS (USE THE HIGH AMPERAGE RANGE FOR THIS ELECTRODE).

NOTE:- THIS DRG. IS SUPPLEMENTARY TO DRG. NO. 4-61-080-00610

GENERAL DIMENSIONS, LIMITS FITS &  
TOLERANCES AS PER PS. HY 0230261


KORBA-6

PREPARED	VP RAHIN/ELISAVIA	APP. <i>[Signature]</i>	PVS.	MILLS
CHECKED	K.A. P.N.O.	DATE		DESIGN
APPLICATION OF WELD PLUGS			4-61-080-00797	REV



REV.	DATE	ALTERED	REV.	DATE	ALTERED	REV.	DATE	ALTERED
03	09.10.98	CHECKED <i>[Signature]</i> APPROVED <i>[Signature]</i>	04	19.10.05	CHECKED <i>[Signature]</i> APPROVED V.KUMAR			CHECKED <i>[Signature]</i> APPROVED
DRAWING REDRAWN ON CAD INCORPORATING ALL THE PREVIOUS REVISIONS.			Ø30 WAS Ø33. AND Ø40 WAS Ø43.7 ANGLE 28° WAS 30°. DEV. LENGTH CHANGED. REVISION MADE AS PER SHOP FEEDBACK					

**NOTES:-**

- BREAK ALL SHARP EDGES AND CORNERS UNLESS OTHERWISE NOTED.
- TOLERANCES UNLESS OTHERWISE SPECIFIED  
DECIMAL  $\pm 0.13$  mm.  
ANGULAR  $\pm 0^{\circ}-6'$

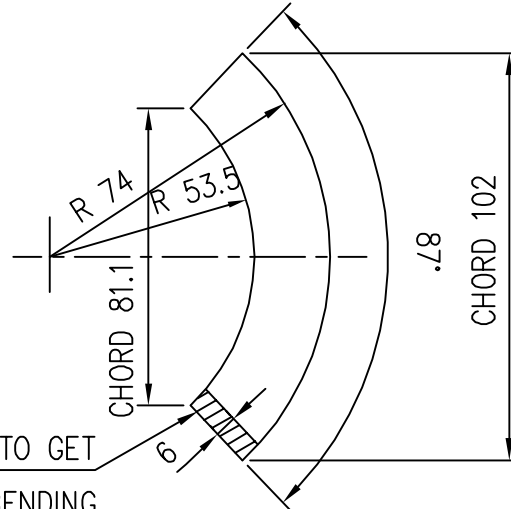


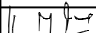
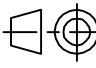


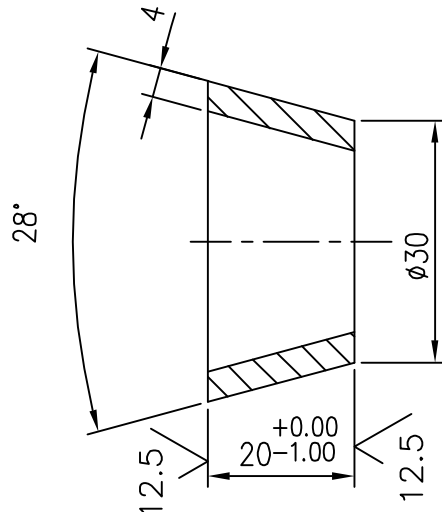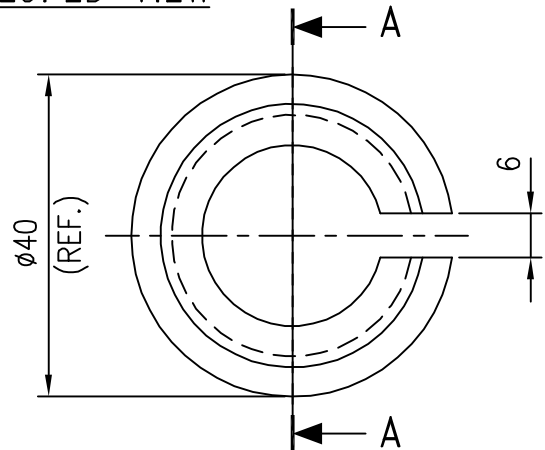
CUT OFF THE HATCHED PORTION TO GET  
A GAP OF 6 mm. AFTER BENDING

**DEVELOPED VIEW****SECTION A-A**

SHEET		4 x 38 x 102	AA1011711168	0.13	
			AA10111		1
DESCRIPTION & DRG. No.	VAR No.	RAW MATERIAL SIZE OR CASTING DRG.NO. OR FORGING DRG.NO.	MATL. CODE	NET.WT.	GROSS WT
			MATL. SPECN.	QTY.	

TYPE OF PRODUCT OR  
NAME OF CUSTOMER/PROJECT

REF. TO HY0230261 FOR UNSPECIFIED TOLERANCES.			BHARAT HEAVY ELECTRICALS LTD. HYDERABAD			NAME	SIGN	DATE	NO.OF VAR.  —
					DRN.	N.D.S.		09.10.98	
					CKD.	S.G		09.10.98	
					APPD.	K.M.R		09.10.98	
	DEPT. PULV. ENGG.	GRADE OF TOL. DIM.		SCALE	WEIGHT(K.G.)	REF.TO ASSY.DRG.		ITEM No.	No.OF ITEM
CODE 446	Ø/M/F	1:1 & 1:2		0.13	—		—	—	
TITLE  <u>WELDING PLUG — 1”</u>					DRAWING No.  4-61-162-00749			REV.  04	
					SHT. No. 1		No. OF SHT. 1		

	<h1 style="margin: 0;">CORPORATE PURCHASING SPECIFICATION</h1>	<div style="border-bottom: 1px solid black; padding-bottom: 2px;">AA10108</div> <div style="border-bottom: 1px solid black; padding-bottom: 2px;">Rev No. 11</div> <div style="padding-bottom: 2px;">PAGE 1 of 2</div>																		
<h2 style="margin: 0;">STRUCTURAL STEEL-STANDARD QUALITY</h2> <h3 style="margin: 0;">(PLATES, SECTIONS, STRIPS, FLATS &amp; BARS)</h3> <h4 style="margin: 0;">(ORDERING DESCRIPTION)</h4>																				
<p><b>1.0 GENERAL:</b></p> <p>This specification governs the quality requirements of structural steel plates, strips, flats, bars and sections such as angles, beams, channels and tees etc. of IS: 2062 – 2011, Gr: E250, Quality A</p> <p><b>2.0 APPLICATION:</b></p> <p>For general engineering purpose.</p> <p><b>3.0 CONDITION OF DELIVERY:</b></p> <p>Plates, Bars &amp; Sections: Hot rolled in straight lengths without twists &amp; Bends</p> <p><b>4.0 COMPLIANCE WITH NATIONAL STANDARDS:</b></p> <p>Material shall comply with the requirements of IS: 2062 – 2011, Gr: E250, Quality A</p> <p>Material offered to EN 10025-2:2004 Gr. S275JR is also acceptable. The tolerance on dimensions for plates shall comply with EN 10029.</p> <p><b>5.0 DIMENSIONS AND TOLERANCES:</b></p> <p><b>5.1 DIMENSIONS:</b></p> <p><b>5.1.1 Sizes</b></p> <p>Material shall be supplied to the dimensions specified on BHEL Order.</p> <p><b>5.1.2 Length</b></p> <p>Unless otherwise specified, hot rolled bars and sections shall be supplied in 3 to 6 metres length.</p> <p><b>5.2 Tolerances:</b></p> <p><b>5.2.1</b> The tolerances on hot rolled material shall comply with IS: 1852. However, no plate shall be under the specified thickness at any point.</p>																				
<table border="1" style="width: 100%; border-collapse: collapse;"> <tr> <td colspan="3" style="padding: 5px;">           Revisions:            As per Cl. No. 38.1 of MOM of MRC-S&amp;GPS         </td> <td colspan="3" style="text-align: center; padding: 5px;"> <b>APPROVED:</b>            INTERPLANT MATERIAL RATIONALISATION            COMMITTEE – MRC(S&amp;GPS)         </td> </tr> <tr> <td style="width: 20%; padding: 5px;">Rev No.11</td> <td style="width: 20%; padding: 5px;">Amd No.</td> <td style="width: 20%; padding: 5px;">Reaffirmed</td> <td style="width: 20%; padding: 5px;">Prepared</td> <td style="width: 20%; padding: 5px;">Issued</td> <td style="width: 20%; padding: 5px;">Dt. of 1<sup>st</sup> Issue</td> </tr> <tr> <td style="padding: 5px;">Dt:22-02-2014</td> <td style="padding: 5px;">Dt:</td> <td style="padding: 5px;">Year:</td> <td style="padding: 5px;">HPEP, Hyderabad</td> <td style="padding: 5px;">Corp.R&amp;D</td> <td style="padding: 5px;">July, 1976</td> </tr> </table>			Revisions: As per Cl. No. 38.1 of MOM of MRC-S&GPS			<b>APPROVED:</b> INTERPLANT MATERIAL RATIONALISATION COMMITTEE – MRC(S&GPS)			Rev No.11	Amd No.	Reaffirmed	Prepared	Issued	Dt. of 1 <sup>st</sup> Issue	Dt:22-02-2014	Dt:	Year:	HPEP, Hyderabad	Corp.R&D	July, 1976
Revisions: As per Cl. No. 38.1 of MOM of MRC-S&GPS			<b>APPROVED:</b> INTERPLANT MATERIAL RATIONALISATION COMMITTEE – MRC(S&GPS)																	
Rev No.11	Amd No.	Reaffirmed	Prepared	Issued	Dt. of 1 <sup>st</sup> Issue															
Dt:22-02-2014	Dt:	Year:	HPEP, Hyderabad	Corp.R&D	July, 1976															

# CORPORATE PURCHASING SPECIFICATION



## 5.2.2 Straight for hot rolled bars:

Unless otherwise specified, the permissible deviation in straightness shall not exceed 5 mm in any 1000 mm length.

## 6.0 HARDNESS (BRINELL):

When tested in accordance with IS: 1500, the material shall show a brinell hardness in the range of 120-156 HB.

Note: Hardness test shall be conducted only when tensile test cannot be performed.

## 7.0 TEST CERTIFICATES:

Unless otherwise specified, three copies of test certificates shall be supplied.

In addition, the supplier shall ensure to enclose one copy of the test certificate along with their dispatch documents to facilitate quick clearance of the material.

The test certificate shall bear the following information.

AA10108 Rev.11 / IS:2062 Grade: E250 Quality A / EN 10025-2 Gr. S275JR,

BHEL order no., Melt no. Size, Results of chemical analysis and Mechanical tests, Supplier's name, Identification no. TC no., Signature of competent authority etc.

## 8.0 PACKING AND MARKING:

Plates shall be transported suitably to avoid damage during transit.


For plates below 10 mm thick, each pile (preferably of 16 plates) and each plate 10 mm thick & over shall be marked with melt no. AA10108, BHEL order no., Supplier's name, Identification no., Size & weight on any one corner and encircled with paint preferably of white colour.

## 9.0 REFERRED STANDARDS (Latest publications including amendments):

1) IS: 1500

2) IS: 1852

3) EN 10029

	<h1 style="margin: 0;">CORPORATE PURCHASING SPECIFICATION</h1>	<div style="border-bottom: 1px solid black; padding: 2px;">AA10111</div> <div style="border-bottom: 1px solid black; padding: 2px;">Rev No. 06</div> <div style="padding: 2px;">PAGE 1 of 4</div>																		
<h2 style="margin: 0;">HOT ROLLED CARBON STEEL SHEET (410 N/mm<sup>2</sup> Tensile)</h2>																				
<p><b>1.0 GENERAL:</b></p> <p>This specification governs the quality requirements of Hot Rolled Carbon Steel Sheet of thickness of 2.5 mm to 4.0 mm (both inclusive).</p> <p><b>2.0 APPLICATION:</b></p> <p>Suitable for cold forming / drawing / fabrication by welding.</p> <p><b>3.0 CONDITION OF DELIVERY:</b></p> <p>Sheets shall be supplied in hot rolled, decaled and oiled condition. Imported sheets shall be supplied in straight lengths. The edges shall be flattened and sheared. Mill edges are not acceptable. Sheets shall be free from waviness and shall have a uniformly dull (matt) finish.</p> <p>Oil used for rust prevention should be free from pungent smell. The following oils are suggested:</p> <ul style="list-style-type: none"> <li>a) SERVO RP 125 of M/s. IOC.</li> <li>b) RUSTOP 387/388 of M/s. HPC</li> <li>c) Bharat TCPF of M/s. Bharat Petroleum</li> <li>d) Any other TRP conforming to IS: 1154</li> </ul> <p><b>4.0 COMPLIANCE WITH NATIONAL STANDARDS:</b></p> <p>The material shall comply with the requirements of the following National standards and also meet the requirements of this specification.</p> <p>IS: 5986 – 2011, Gr.: 255: Hot rolled steel flat products for structural forming and flanging purposes - Specification.</p> <p><b>5.0 DIMENSIONS AND TOLERANCES:</b></p> <p><b>5.1 Sizes:</b></p> <p>Hot rolled carbon steel sheets shall be supplied to the dimensions in BHEL order.</p> <p><b>5.2 Tolerances:</b></p> <p>The tolerances on sheets shall comply with the following:</p> <p><b>5.2.1 Thickness (IS: 1852):</b></p> <table border="1" style="margin-left: auto; margin-right: auto; border-collapse: collapse; text-align: center;"> <thead> <tr> <th style="padding: 5px;">Thickness, mm</th> <th style="padding: 5px;">Tolerance, mm</th> </tr> </thead> <tbody> <tr> <td style="padding: 5px;">2.50</td> <td style="padding: 5px;">± 0.20</td> </tr> <tr> <td style="padding: 5px;">3.15</td> <td style="padding: 5px;">± 0.22</td> </tr> <tr> <td style="padding: 5px;">4.0</td> <td style="padding: 5px;">± 0.25</td> </tr> </tbody> </table>			Thickness, mm	Tolerance, mm	2.50	± 0.20	3.15	± 0.22	4.0	± 0.25										
Thickness, mm	Tolerance, mm																			
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Revisions: As per Cl.No.38.1 of MOM of MRC – S&GPS			<b>APPROVED:</b> INTERPLANT MATERIAL RATIONALISATION COMMITTEE – MRC(S&GPS)																	
Rev No.06	Amd No.	Reaffirmed	Prepared	Issued	Dt. of 1 <sup>st</sup> Issue															
Dt:22-02-2014	Dt:	Year:	HEP, Bhopal	Corp.R&D	April, 1978															

# CORPORATE PURCHASING SPECIFICATION



## 5.2.2 Width, Length, Flatness, Edge chamber and Out of square tolerance for cut lengths:

As per IS:5986

## 6.0 MANUFACTURE:

Process of manufacture is left to the discretion of the manufacturer except Bessemer process.

Material shall be manufactured from semi killed or killed steel.

## 7.0 FREEDON FROM DEFECTS:

The sheets shall be free from harmful defects, twists, buckle, rust, scale and waviness and shall be reasonably smooth, flat and square.

## 8.0 CHEMICAL COMPOSITION:

The melt analysis of steel and the permissible variation in the composition of the material from the melt analysis shall be as follows:

Element	Melt analysis, percent, max.	Permissible variation, percent, max.
Carbon	0.15	0.03
Manganese	1.20	0.05
Sulphur	0.040	0.005
Phosphorus	0.040	0.005

**Carbon equivalent (C.E.): 0.42 max.**

## 9.0 TEST SAMPLES:

### 9.1 Tensile Test:

One sample shall be taken per thickness per consignment from each melt.

As far as possible test pieces shall be cut transverse to the direction of rolling and shall be of full thickness of the sheet rolled.

### 9.2 Bend Test:

One sample shall be taken per thickness per consignment from each melt.

Bend test pieces shall be cut so that the axis of the bend is parallel to the direction of rolling viz. transverse.

**Note:** When more than one thickness is rolled from the same melt, one additional test piece for each thickness shall be taken.

## 10.0 MECHANICAL PROPERTIES:

### 10.1 Bend:

When tested in accordance with IS: 1599, the test pieces shall be capable of being bent cold through 180° close. The outer convex surface of the test piece shall be free from cracks.

## 10.2 Tensile:

When tested as per IS : 1608, the test pieces shall show the following properties:

Tensile strength	: 410 – 520 N/mm <sup>2</sup>
Yield strength	: 255 N/mm <sup>2</sup> , min.
Elongation:	
For sheets up to & Incl. 3 mm, thick	: 15 %, minimum on 80 mm gauge length
For sheets above 3 mm, thick	: 24 %, minimum in $5.65 \sqrt{S_0}$ gauge length

## 11.0 TEST CERTIFICATES:

Unless otherwise specified, three copies of test certificates shall be supplied.

In addition, the supplier shall ensure to enclose one copy of the test certificate along with their dispatch documents to facilitate quick clearance of the material.

The test certificate shall bear the following information:

AA10111, Rev 06: HOT ROLLED CARBON STEEL SHEET (410 N/mm<sup>2</sup> Tensile)

BHEL Order No,

Supplier's name,

Identification No

Melt No,

Process of manufacture

Details of pickling, descaling and oiling

Results of dimensional inspection


Results of Chemical analysis and Mechanical tests,

**Note:** Material procured, supplied and certified as AA10111 / IS: 5986, Gr.:255 and comply with the requirements of this specification is acceptable.

## 12.0 PACKING AND MARKING:

Steel sheets shall be supplied in bundles and shall be suitably packed in bundles to prevent corrosion and damage during transit.

The recommended packing for imported material shall be as shown below.

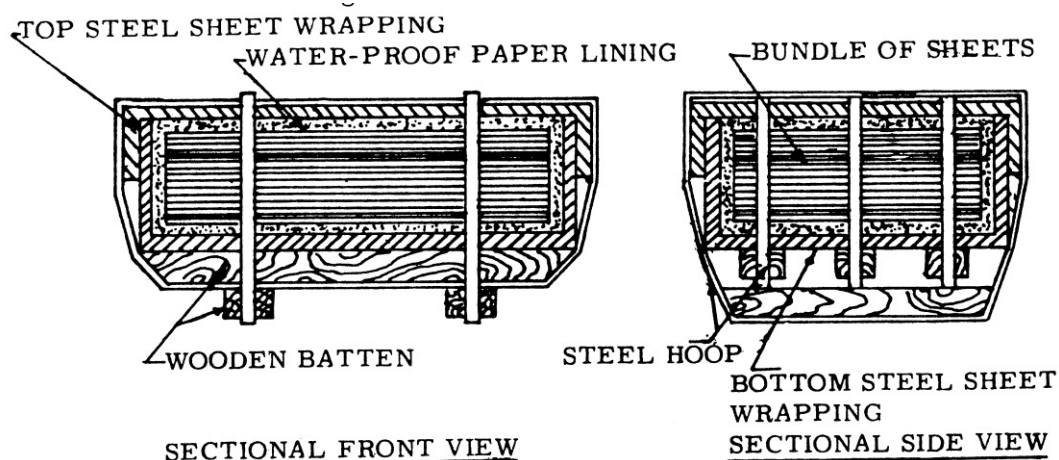

### Note:

- Water proof paper lining shall be preferably Volatile Corrosion Inhibitor (V.C.I.) Coated Paper with additional polythene (100 micron) enveloped.
- Approximate weight of each bundle shall be 2 to 3 tonnes. Bundle weighing 2 metric tonnes is however preferred.

AA10111

Rev No. 06

PAGE 4 of 4

## CORPORATE PURCHASING SPECIFICATION



A metal label shall be securely attached to each bundle and shall bear the following information:

AA10111: HOT ROLLED CARBON STEEL SHEET (410 N/mm<sup>2</sup> Tensile)

BHEL Order No,

Supplier's Name & Identification No,

Size & Thickness of sheets

Weight

### 13.0 REFERRED STANDARDS (Latest publications including amendments):

1) IS: 1154

2) IS: 1599

3) IS: 1608

4) IS: 1852





# CORPORATE PURCHASING SPECIFICATION

AA10119

Rev No. 15

PAGE 1 of 2

## STRUCTURAL STEEL - WELDABLE QUALITY (PLATES, SECTIONS, STRIPS, FLATS AND BARS)

### ORDERING DESCRIPTION

#### 1.0 GENERAL:

The material shall conform to IS 2062 – 2011, E250-Gr.BR (with mandatory Impact Test) or DIN EN 10025-2:2005, Gr. S275JR and comply with following additional requirements.

#### 2.0 APPLICATION:

For general engineering purposes, suitable for welding.

#### 3.0 CONDITION OF DELIVERY:

3.1 Bars & Sections shall be supplied in Hot rolled in straight lengths without twists and bends.

3.2 The material shall be supplied as per IS: 2062 – 2011, E250 Gr.BR (with mandatory Impact Test) or as per DIN EN 10025-2:2005 Gr. 275JR.

3.3 Any other additional requirement as per BHEL Purchase order.

#### 4.0 DIMENSIONS AND TOLERANCES:

##### 4.1 Sizes:

Material shall be supplied to the dimensions specified in BHEL Order.

##### 4.2 Tolerances:

The tolerances on hot rolled material shall comply with IS: 1852 or any other equivalent national standard.

##### 4.3 Straightness for hot rolled bars:

Unless otherwise specified, the permissible deviation in straightness shall not exceed 5 mm in any 1000 mm length.

#### 5.0 TEST SAMPLES:

The selection of test pieces for all tests like Chemical, Mechanical etc. shall be as per IS: 2062, E250-Gr.BR or DIN EN 10025-2, Gr. S275JR.

#### Revisions:

Clause No. 1, 3, 5 & 8 revised (as per MOM of 38th MRC meeting), Clause 10 added

#### APPROVED:

INTERPLANT MATERIAL RATIONALISATION  
COMMITTEE – MRC(S&GPS)

Rev No.15

Amd No.

Reaffirmed

Prepared

Issued

Dt. of 1<sup>st</sup> Issue

Dt:11-03-2014

Dt:

Year:

HPEP, Hyderabad

Corp.R&amp;D

June, 1976

26/6/14

CS-72

# CORPORATE PURCHASING SPECIFICATION



## 6.0 ULTRASONIC EXAMINATION:

Plates shall be ultrasonically examined in accordance with BHEL standard AA0850120 (or ASTM-A435) as detailed below and shall comply with the acceptance standards specified therein.

### 6.1 For plates above 40 mm thick:

Shall be ultrasonically examined unless when otherwise specified in order.

## 7.0 TEST CERTIFICATES:

Unless otherwise specified, three copies of test certificates shall be supplied.

In addition, the supplier shall ensure to enclose one copy of the test certificate along with their dispatch documents to facilitate quick clearance of the material.

The test certificate shall bear the following information:

AA10119 - Rev.No.15/ IS: 2062-Gr: BR (with mandatory Impact test) or DIN EN 10025-2, Gr. S275JR,

BHEL order No.

Melt No, Size & Quantity, Batch No with heat treatment details, Results of Chemical analysis,

Mechanical tests & NDT, Supplier's name, Identification No, TC No, Signature of Competent Authority, etc.

## 8.0 PACKING AND MARKING:

Plates shall be transported suitably to avoid damage during transit.

Each plate shall be marked with Melt No. Material grade and specification, BHEL Order No, Supplier's Name Identification No, Size & weight, on any one corner and encircled with paint preferably of white colour.

## 9.0 REJECTION AND REPLACEMENT

If the material does not comply with the requirements of this specification during receipt inspection at BHEL or if any defect is found during further processing of material, BHEL reserves the right to reject the whole consignment and the supplier shall replace the material free of cost. The rejected material shall be taken back by the supplier after fulfilling the commercial terms and conditions.

## 10.0 REFERRED STANDARDS (Latest publications including amendments):

1) IS: 1852

2) ASTM - A435

3) AA0850120

26/6/14

CS-721



## CORPORATE PURCHASING SPECIFICATION

AA 197 41

Rev. No. 03

PAGE : 1 OF 5

### ABRASION RESISTANT IRON CASTINGS

#### 1.0 GENERAL:

This specification governs the quality requirements of Abrasion Resistant Iron Castings, having good resistance to both low and high stress abrasion.

#### 2.0 APPLICATION:

Used as liners and segments for wear resistance.

#### 3.0 CONDITION OF DELIVERY:

Stress relieved.

As cast unless otherwise specified in BHEL order/drawing.

Castings shall not be painted.

#### 4.0 COMPLIANCE WITH NATIONAL STANDARDS:

The material shall comply with the requirement of the following national standard and also meet the requirements of this specification.

IS: 4771 – 1985 | Abrasion resistance iron castings.  
Type 1A: NiLCr 34/550

#### 5.0 DIMENSION AND TOLERANCES:

Castings shall be true to the pattern / drawing.

Holes for machining up to including 50mm in diameter are to be cast solid, unless otherwise stated on BHEL order / drawing.

Unless otherwise specified on BHEL order/ drawing, untoleranced dimensions for the casings shall be as per tolerance class 4 of BHEL standard AA 023 04 02.

#### 6.0 MANUFACTURE:

The iron for the castings shall be melted in an electric furnace or by any other suitable melting process as may be agreed to between BHEL and manufacturer.

#### Revisions :

Refer 28.8.38 of MOM of MRC-FCF+ HTM

#### APPROVED :

INTERPLANT MATERIAL RATIONALISATION  
COMMITTEE-MRC (FCF + HTM)

Rev. No. 03

Amd.No.

Reaffirmed

Prepared

Issued

Dt. of 1<sup>st</sup> Issue

Dt:15.01.2004

Dt :

Year :

TRICHY

Corp. R&D

JANUARY, 1978

**7.0 HEAT TREATMENT:**

All castings shall be stress relieved at a temperature of 210 - 235<sup>0</sup> C for a minimum soaking period of 4 hours.

Test pieces shall also be stress relieved along with the castings they represent.

**8.0 FINISH:**

All castings shall be properly fettled and dressed and all surfaces shall be thoroughly cleaned. Whenever specified, the machined surfaces shall have the surface finish as indicated in the drawing.

**9.0 FREEDOM FROM DEFECTS:**

Castings shall be free from defects such as porosity, blow holes, sand inclusions, shrinkage, cavities, hard spots, cold shuts, cracks, etc., which may adversely affect machining and utility of castings.

**10.0 CHEMICAL COMPOSITION:**

The melt analysis of the iron shall be as follows:

Element	<u>Melt analysis, Percent</u>	
	Min.	Max
Carbon	3.2	3.6
Silicon	0.3	0.6
Manganese	0.3	0.6
Nickel	3.0	5.5
Chromium	1.5	2.5
Molybdenum	--	0.5
Sulphur	--	0.150
Phosphorus	--	0.300
Iron	Remainder	

**Note:**

The amount of silicon, chromium and nickel shall be balanced depending upon the carbon content and the thickness of the castings to ensure of free graphite and coarse bainite. Graphite carbon should not exceed 0.1 percent.



## CORPORATE PURCHASE SPECIFICATION

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### 11.0 TEST SAMPLES:

#### 11.1 Chemical Analysis:

The foundry shall analyse each heat for chemical composition. A sample way to obtain chips is to dip a cooled mild steel bar in the liquid metal and withdraw quickly. The solidified iron can be easily knocked off the bar with a hammer. The chips must be free from sand, carbon and other contaminations.

#### 11.2 Hardness Test:

The foundries shall pour the test bar of size 150 X 150 X 25 mm for each heat representing each heat treatment batch. When possible, the test bar shall be cast integrally with the castings so as to receive the same cooling rate. All the test specimens shall be identified with heat numbers by proper painting.

### 12.0 MECHANICAL PROPERTIES:

#### Hardness (Brinell):

Hardness shall be measured as per IS:1500 on the test blocks and on castings at random by a hardness tester using 10 mm diameter tungsten carbide ball. The hardness shall not be less than 550 HB.

**Note:** Minimum hardness value upto 50 Brinell points lower than specified shall be permitted for castings having sectional thickness above 125 mm.

### 13.0 MICROSTRUCTURE:

This shall consist of carbides in a matrix of martensite, bainite and austenite and shall be free from graphite, pearlite and ferrite.

### 14.0 ADDITIONAL TESTS:

#### 14.1 Magnetic particle inspection:

As per BHEL standard AA 085 01 33 and norms of acceptance as per BHEL standard AA 085 01 34.

#### 14.2 If specified on the drawing/order, castings shall be subjected to non-destructive testing.

Norms of acceptance shall be as per mutual agreement between BHEL and the manufacturer.

### 15.0 REPAIR OF CASTINGS:

Repair of castings shall not be carried out by the manufacturer without the prior permission of BHEL.

**16.0 TEST CERTIFICATES:**

Three copies of test certificates shall be supplied unless otherwise stated on BHEL order, preferably in the test certificate format annexed to this specification (Annexure -1).

In addition, the supplier shall ensure to enclose one copy of the test certificate along with their despatch documents to facilitate quick clearance of the material.

The test certificate shall bear the following information:

Dimensional inspection.

Details of heat treatment.

Reduction ratio

Chemical composition

Results of mechanical tests

Results of additional tests called for in the order / drawing.

**17.0 PACKING AND MARKING:**

Castings shall be suitably packed to prevent corrosion and damage during transit. Machined surfaces shall be properly protected with anticorrosive compounds.

Each package or casting (when supplied separately) shall be legibly marked with the following information.

AA 197 41: Abrasion resistant iron castings

BHEL Order No.

Consignment/Identification No.

Melt No.

Weight

Supplier's Name

**18.0 REFERRED STANDARDS (Latest Publications Including Amendments):**

1. AA 023 04 02

2. AA 085 01 33

3. AA 085 01 34

4. IS : 1500

5. IS:4771



## CORPORATE PURCHASING SPECIFICATION



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## ANNEXURE 1 - RECOMMENDED TEST CERTIFICATE FORMAT FOR CASTINGS

SUPPLIERS'S NAME AND ADDRESS													
1. Customer :							6. Cast No. & Date :						
2. TC No. & Date :							7. Batch No. :						
3. PO No. :							8. Heat Code :						
4. Process of Melting :							9. Spec.. No. :						
5. Deoxidisation Process							10. Test Bar Size						
II. CASTING COVERED BY T.C.													
Sl. No.		Drawing No. & Item No.				Description				Quantity & Weight			
12. CHEMICAL COMPOSITION (PERCENT)													
Element		C	Si	Mn	S	P							
As per Min.													
Spec. Max.													
Actual Values.													
13. HEAT TREATMENT (To be accompanied by Recorder Chart, wherever called for)													
Condition		Temp. °C				Soaking Time. Hrs..				Cooling Medium			
14. MECHANICAL PROPERTIES													
		T.S. N/mm <sup>2</sup>	Y.S. 0.5% 0.2% Proof N/mm <sup>2</sup>		% E on GL 5.65 SO		% R.A. Mn		Hardness BHN Min. 3 Values		Impact Value, Joules		Bend
As per Min.													
Spec. Max.													
Actual Values.													
15. Surface Finish (When called for in the order/drg)													
16. DIMENSIONAL INSPECTION													
17. NON-DESTRUCTIVE TESTS													
Nature of Test		Acceptance Level		Instrument used		Range		Results		Any other details			
Ultrasonic													
Radiographic													
Dye Penetrant/ Magnetic Particle													
18. OTHER TESTS, IF ANY (MICRO- Scope, Hydraulic, Etc.)													
19. IDENTIFICATION ON CASTING AS PER CPS.													
We hereby certify that the items mentioned above have been tested and inspected in our presence and are found to be in accordance with the drawings, specifications and purchase order.													
Signature & Seal of the Inspecting Officer (Purchase Representative)							Signature and Seal of the Chief of Quality Control Chief Metallurgist of the Supplier.						
Date :							Date :						
INSTRUCTION:													
a) If steel is produced by LD or Oxygen process, Nitrogen content should be furnished and shall not exceed 0.009%													
b) Test Certificates are to be furnished as per Purchase Order and Specifications, in A4 Size transparent paper.													
c) All the entries including signature should be in black ink.													
d) If testing is done by outside agencies, the original TCs shall be furnished.													
e) The actual Test Certificate may run into more than one A4 size paper, if needed, to facilitate filling up of details.													

INVENTORY NO.	SIGN. & DATE	REF. DRG. NO.	COMPUTER NO.	THE INFORMATION ON THIS DOCUMENT IS THE PROPERTY OF BHARAT HEAVY ELECTRICALS LIMITED. IT MUST NOT BE USED DIRECTLY OR INDIRECTLY IN ANY WAY DETRIMENTAL TO THE INTEREST OF THE COMPANY.	REV.	DATE	ALTERED		REV.	DATE	ALTERED		REV.	DATE	ALTERED	
							CHECKED				CHECKED				CHECKED	
							APPROVED				APPROVED				APPROVED	
JR.HEAD LINER-V		5	3-61-080-00393													
JR.HEAD LINER-IV		4	3-61-080-00392		AA19741				1							
JR.HEAD LINER-III		3	3-61-080-00391		AA19741				1							
JR.HEAD LINER-II		2	3-61-080-00390		AA19741				1							
JR.HEAD LINER-I		1	2-61-080-00420		AA19741				4							
DESCRIPTION		S.NO.	DRAWING NO.		MATL. CODE		UNIT WT.(Kg.)									
					MATL. SPECN.		QTY.									
TYPE OF PRODUCT OR NAME OF CUSTOMER/PROJECT																
REF. TO HY0230261 FOR UNSPECIFIED TOLERANCES.	 BHARAT HEAVY ELECTRICALS LTD. VARANASI					NAME		SIGN		DATE		NO.OF VAR.				
					DRN.	D.BASAK				04.12.03						
					CKD.	S.TEWARI				04.12.03						
					APPD.	V.KUMAR				04.12.03						
	DEPT. P&D			NTS	WEIGHT(K.G.)	REF.TO ASSY.DRG.		ITEM NO.		NO.OF ITEM						
	CODE															
	TITLE					DRAWING NO. HY-204.00				REV. 00						
SET OF JR. HEAD LINERS																
					SHT.NO. 01		NO.OF SHT. 01									



Rv1920250673

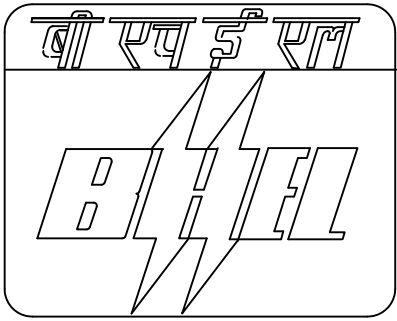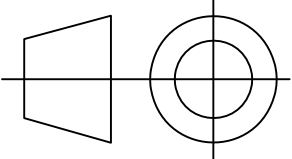S.NO.	DESCRIPTION	DRG.NO.	QTY.	WEIGHT(KG.)
1	JR. HEAD LINER	2-61-088-02062	2	10
2	JR. HEAD LINER	2-61-088-02061	1	16
3	JR. HEAD LINER	2-61-088-02060	1	16
JR. HEAD LINER SET				
Matl. AA19741				
HY-901.09.01.A				

*Vikas*

(VIKAS VERMA)

Dy. Manager  
P&D.

BHEL- Varanasi



## PLANT STANDARD HYDERABAD

**HY0230261****REV. NO. 03****PAGE 1 OF 2**

### LIST OF APPLICABLE STANDARDS ON LIMITS, FITS AND TOLERANCES


#### 1.0 SCOPE:

The standard covers the list of applicable standards on Limits, Fits and Tolerances. These standards are applicable unless or otherwise specified.

#### 2.0 LIST OF APPLICABLE STANDARDS:

SL. NO.	STANDARD NO.	TITLE
1.	AA0230201 -	Limits and Fits (Tolerance grade, Position and Class).
2.	AA0230202 -	Limits and sizes for commercial bolts and nuts.
3.	AA0230204 -	Guide for selection of Fits.
4.	AA0230206 -	Standard limits for Shafts (upto 500 mm).
5.	AA0230207 -	Standard limits for Shafts (above 500 mm and upto 3150 mm).
6.	AA0230208 -	Allowable deviations for dimensions without specified tolerances (linear and angular).
7.	AA0230402 -	Permissible deviations for untoleranced dimensions of castings.
8.	AA0230403 -	Tolerancing system ISO Metric Screw Threads
9.	AA0621101 -	Tolerances and Machining allowances for Flame cutting.
10.	AA0621104 -	General tolerances for welding constructions for length and angles.
11.	AA0621105 -	General tolerances for welded structures – form and position.

**Revisions:****Issued :****Withdrawn standards deleted (2 Nos.).****STANDARDS ENGINEERING DEPARTMENT****Rev. No. 03****Amd. No.****Reaffirmed:****Prepared:  
MANAGER  
(STDS. ENGG.)****Approved:****AGM (E&CC)****Date of 1<sup>st</sup> issue:****Dt. OCT. 06****Dt.****Year:****MAY, 1992**

HY0230261	PLANT STANDARD HYDERABAD	
REV. NO. 03		
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NOTE:

1)

AA 023 02 08

Medium class of deviation is applicable, if the same is not mentioned on the drgs./specs.

2)

AA 023 04 02

Tolerance class 5 is applicable, if the same is not mentioned on the drgs./specs.

3)

AA 062 11 04

Accuracy class A is applicable if the same is not mentioned on the drgs.

4)

AA 062 11 05

Accuracy class E is applicable, if the same is not applicable on drgs.

**BHARAT HEAVY ELECTRICALS LIMITED**

Ramachandrapuram, Hyderabad – 502 032, INDIA

**QW – 482 WELDING PROCEDURE SPECIFICATION (WPS)**

Welding Procedure Specification No.: WE006 Date: 02.08.86 Supporting PQR No.: 516, Dt : 11.05.10

Revision No.: 07

Date: 24.04.2016

Welding Process (es) : SMAWType (s) : MANUAL**JOINTS (QW 402)**Joint Design: As per manufacturing drawing (groove/fillet)Root Spacing : As per manufacturing drawingBacking (Yes) : for double side butt welds and backing strip joints(No) : for single side weldsBacking Material (Type) : Base metal / Weld metalMetal: YesNon-Fusing Metal: NoRetainer: No**BASE METALS (QW – 403)**

P. No. : 1 Group No. : 1 &amp; 2 TO P. No.: 1 Group No.: 1 &amp; 2

**OR**

Specification type &amp; grade: ----- to Specification type &amp; grade : -----

**OR**

Chemical Analysis &amp; Mechanical Properties: --- to Chemical Analysis &amp; Mechanical Properties: ----

**Thickness Range :**Base Metal : Groove: 5.0 mm to 38 mm \*\* Fillet : all sizes

Deposited pass thickness &gt; 13mm – Not Permitted

Other : None

**Filler Metals (QW – 404)**

	<b>SMAW</b>
Spec. No. (SFA)	5.1
AWS NO (CLASS)	A5.1 (E 7018)
F. No.	4
A. No.	1
Size of Filler Metals	Dia 2.5, 3.15, 4.0, 5.0mm
Filler Metal Product Form	N.A
Supplemental Filler Metal	N.A
Deposited Weld Metal	
Thickness Range : Groove:	38 mm Max.
Fillet:	38 mm Max Throat
Electrode Flux (Class)	Basic
Consumable Insert	No
Max. Bead Thickness	5 mm

\*\* Note : For Unequal thicknesses base material thickness qualified upto 50mm and weld metal thickness limited to 38mm max.

Rev : 07 – Note added regarding base material thickness

N.A – Not Applicable

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**POSITIONS (QW-405)****Position(s) Groove :** ALL POSITIONS**Welding Progression:** UP for VerticalDown –Not permitted**Position (s) Fillet:** ALL**Other :** None**POSTWELD HEAT TREATMENT (QW-407)**Not Permitted**Temperature Range:** NA**Time Range:** NA**Other :** None**PREHEAT (QW-406)****Preheat Temp Min:** 10 °C min for < 31mm100 °C min for 31mm and above**Interpass Temp Max:** 300 °C**Preheat Maintenance:** Minimum specified temperature for every restart**Other :** None**GAS (QW - 408)**Percentage Composition  
**Gas(es) Mixture Flow Rate****Shielding :** N.A - -**Trailing :** N.A - -**Backing :** N.A - -**Other :** None**ELECTRICAL CHARACTERISTICS (QW-409)**

Weld Pass (es)	Process	Filler Metal		Current type & Polarity	Amps (Range)	Wire feed speed	Energy or Power (Range)	Volts (Range)	Travel speed	Other
		Classifi-cation	Diam-eter							
<b>Root&amp; Subsequent as required</b>	<b>SMAW</b>	<b>E 7018</b>	<b>2.5mm</b>	<b>DCEP</b>	<b>60 – 90A</b>	<b>N.A</b>	<b>N.A</b>	<b>22-34V</b>	<b>N.A</b>	<i>String for horizontal; Others Weave (Max 3 times Electrode Core Dia)</i>
	-do-	-do-	3.15mm	-do-	100-150A	-do-	-do-	-do-	-do-	
	-do-	-do-	4.0mm	-do-	150-200A	-do-	-do-	-do-	-do-	
	-do-	-do-	5.0mm	-do-	200-260A	-do-	-do-	-do-	-do-	

**Pulsing Current :** NA**Heat Input :** NA**Tungsten Electrode Size and Type :** NA**Mode of Metal Transfer for GMAW (FCAW):** NA**Others :** None**TECHNIQUE (QW-410)****String or Weave Bead:** string and/or weave**Orifice or Gas Cup Size :** NA**Initial / Interpass Cleaning :** chipping / brushing / grinding**Method of Back Gouging:** grinding/gouging if required**Oscillation :** NA**Contact tube to work distance :** NA**Multiple or Single Pass :** Multiple pass**Multiple or Single Electrodes :** Single electrode**Closed to out chamber :** NA**Peening :** Not allowed**Use of thermal processes :** NA**Other :** Clean weld area to remove oil, rust, grease, etc. prior to welding.**Prepared by****Welding Engineer**

N.A – Not Applicable

**Approved by****HEAD / Welding Engg**

**PQR for Critical Regular Direct Mil items**

<b>PQR Ref No: PQR/24-25/ Critical Regular Direct Mil items</b>	<b>Date: 23.08.2024</b>
<b>Rev No: 00</b>	<b>Review Date: 23.08.2024</b>
<b>PQR Revision Date:</b>	

<b>Sl. No.</b>	<b>BHEL Terms</b>	<b>Supplier's Compliance YES/NO</b>
<b>1</b>	<b>Offers are accepted from:</b>	
1.a	Only Manufacturer's Offers shall be considered for the Tender Enquiry.	
<b>2</b>	<b>Supplier shall give list of In-House Facilities:</b>	
2.a	Vendor shall have in-House necessary Manufacturing facilities required for manufacturing and supply of item/s as per drawing/specification.	
2.b	BHEL reserves right to visit the Works of the Manufacturer for Physical verification of the Manufacturing facilities (as declared by them) and assessment of their Quality systems during Technical Evaluation of the Offers.	
2.c	Bidders shall submit detailed Manufacturing process Plan along with the Technical Offer.	
<b>3</b>	<b>Experience:</b>	
3.a	Bidders shall submit the necessary documents proving their <b>Experience in Supplying same or similar items to any Power Plant equipment Manufacturer (worldwide or within India)</b> in last three years from the date of Enquiry. Documentary evidences to be submitted in the form of Customer's Purchase Order copies / Material Acceptance Report and item drawings/specifications. Documentary evidences submitted shall strictly meet all the technical requirement of the NIT.	
3.b	BHEL reserves right to verify the details from the Bidder's customers based on Documents submitted as a part of past experience. BHEL may ask for other relevant documents in line with above to review the capacity and capability of vendor with respect to enquired items.	
<b>4</b>	<b>Financial Capability:</b>	
4.a	<b>Turn Over:-</b> Turn over of Non-MSe vendors should be 100% of tender value. Relaxation for MSe vendors/ Notified Start-Ups on turn over will be as per MSME guidelines. UDYAM Certificate required for Mse status.	
4.b	Applicable only for Non-Mse vendors:  Audited balance Sheet and Profit and Loss account Statement of last three consecutive year (with UDIN ) required along with part-1 bid. Or A CA Certified Consolidated summary (with UDIN) for last 3 consecutive years having annual turn over and Profit and Loss to be enclosed along with Part-1 bid .  For Vendors having Turn over less than 1 crore in any of the financial year, CA certified Financial Turn over and Profit Loss (with UDIN) may be accepted for that year only.	
<b>Note-1: Non Submission of the above requested documents/non compliance to the above points will result in rejection of the Offers without further Notice/Intimation to the Bidder and no correspondence will be entertained at later date.</b>		
<b>Note-2: "Similar items" means items having same/similar manufacturing process,similar nature of use of item as that of enquired items etc.</b>		

**GENERAL COMMERCIAL TERMS & CONDITIONS OF ENQUIRY  
(FOR INDIAN VENDORS)**

Amendment- 25  
ANNEXURE-A

**ITEM DESCRIPTION:**

**ENQUIRY NO:**

Sl No	BHEL STANDARD TERMS & CONDITIONS	Confirmation of supplier (Yes/No)
1	<p>A) OFFER MUST BE SUBMITTED IN TWO PART BID SYSTEM NAMELY TECHNO-COMMERCIAL BID &amp; PRICE BID FOR THE ITEM AS PER ENQUIRY IN SEPARATE SEALED COVERS:</p> <p>(I) TECHNO – COMMERCIAL BID &amp; (II) PRICE BID SHOULD BE CLEARLY SUPERSCRIBED THE ENQUIRY NO. AND DUE DATE ON THE ENVELOPES.</p> <p>(B) UN-PRICED OFFER WITH TECHNICAL BID IS REQUIRED TO BE FURNISHED BY THE VENDOR. TECHNICAL OFFER SHOULD CLEARLY REFLECT AT LEAST OUR MATERIAL CODE, ITEM DESCRIPTION &amp; QUANTITY.</p> <p>(C) THE DIFFERENCE BETWEEN “UN-PRICED OFFER” AND “PRICED OFFER” SHOULD BE ONLY THE PRICES WHEREVER APPLICABLE. THE RATES AND AMOUNT SHOULD BE CLEARLY WRITTEN IN FIGURES AND WORDS BOTH WITHOUT ANY CUTTING / OVERWRITING.</p> <p>(D) <b>IMPORTANT POINT FOR VENDOR WHO HAVE NOT SUBMITTED THE SRF (SUPPLIER REGISTRATION FORM) SO FAR:</b> THE VENDORS, WHO HAVE NOT SUBMITTED THE SRF SO FAR, MUST SUBMIT THE SAME ALONG WITH PART- 1 BID. THE SRF TO BE DOWNLOADED FROM WWW.BHEL.COM OR <a href="https://herp.bhel.com">https://herp.bhel.com</a> .</p>	
2	BID SHOULD BE FREE FROM CORRECTION, OVERWRITING, USING CORRECTIVE FLUID, ETC. ANY INTERLINEATION , CUTTING , ERASURE OR OVERWRITING SHALL BE VALID ONLY IF THEY ARE ATTESTED UNDER FULL SIGNATURE(S) OF PERSON(S) SIGNING THE BID ELSE BID SHALL BE LIABLE FOR REJECTION .	
3	YOUR TECHNO COMMERCIAL BID SHOULD MENTION THAT PRICE BID HAS BEEN SENT IN A SEPARATE ENVELOPE GIVING ITS REFERENCE.	
4	VENDOR TO ENSURE THAT ITEM & QUANTITY MENTIONED IN THE OFFERS ARE EXACTLY SAME AS PER ENQUIRY. IF ANY DEVIATION IS THERE PARTY MUST MENTION SPECIFIC HEREWITH OTHERWISE BHEL SHALL CONSIDER THAT ITEM & QUANTITY AS REQUIRED IN ENQUIRY.	
5	PLEASE MAKE SURE THAT THERE IS NO DISCREPANCY IN BETWEEN ACCEPTED TERMS & CONDITIONS MENTIONED IN THE CHECK LIST AND QUOTATION SUBMITTED BY VENDOR AND IF FOUND SO THEN THE TERMS & CONDITIONS WHICH ARE BENEFICIAL TO BHEL WOULD ONLY BE CONSIDERED.	
6	THE TENDER RECEIVED AFTER 14:00 HRS ON THE DUE DATE WILL NOT BE CONSIDERED.	
7	PART-I CONTAINING THE TECHNO-COMMERCIAL BID WILL BE OPENED ON THE DATE AND TIME SPECIFIED IN THE ENQUIRY, IN THE PRESENCE OF THOSE TENDERERS WHO WISH TO ATTEND. PART-II i.e., PRICE BID WILL BE OPENED ONLY OF THOSE BIDDERS WHO ARE FOUND TECHNO-COMMERCIALLY SUITABLE AFTER SCRUTINY OF THEIR PART-I OFFERS.	
8	NO REVISED OFFERS WILL BE ACCEPTED UNLESS ASKED BY BHEL AFTER OPENING OF PART-1 BID IN ANY CASE.	
9	THE RATE OF GST SHOULD BE CLEARLY MENTIONED IN THE OFFER.	
10	VALIDITY OF OFFER SHOULD BE MINIMUM 90 DAYS FROM THE DATE OF TECHNO - COMMERCIAL BID OPENING OR 60 DAYS FROM THE REVERSE AUCTION DATE.	
11	BHEL RESERVES THE RIGHT TO REJECT THE OFFER, WHICH IS HAVING DEVIATIONS TO THE TERMS AND CONDITIONS GIVEN IN THE TENDER ENQUIRY.	
12	<b>PRICING TERMS:</b> PRICES ONCE QUOTED SHALL REMAIN FIRM WITHIN THE VALIDITY OR ANY EXTENSION THEREOF FOR PLACEMENT OF ORDER, TILL COMPLETE EXECUTION OF THE ORDER, WITHOUT ANY ESCALATION/INCREASE FOR ANY REASON, WHATSOEVER, UNLESS SPECIFICALLY PROVIDED FOR IN THE ENQUIRY & PO. IN CASE OF FOREIGN VENDORS, THE QUOTED PRICE SHALL BE TAKEN AS INCLUSIVE OF THIRD PARTY INSPECTION AND TESTING CHARGES AS CALLED FOR IN THE NIT.	
13	<b>BID EVALUATION:</b> UNLESS SPECIFIED IN THE TENDER, VENDOR MUST NOTE THAT BHEL WILL ARRIVE THE L1 STATUS FOR EACH ITEM ON LANDED COST BASIS. ACCORDINGLY, ORDER SHALL BE PLACED ON LOWEST BIDDER ON INDIVIDUAL ITEM BASIS ONLY, UNLESS BHEL ASK FOR TERMS OTHER THAN THIS ON EXCEPTION BASIS. IN THE COURSE OF EVALUATION, IF MORE THAN ONE BIDDER HAPPENS TO OCCUPY L-1 STATUS, EFFECTIVE L-1 WILL BE DECIDED BY SOLICITING DISCOUNTS FROM THE RESPECTIVE L-1 BIDDERS. IN CASE MORE THAN ONE BIDDERS HAPPENS TO OCCUPY THE L-1 STATUS EVEN AFTER SOLICITING DISCOUNT, THE L-1 BIDDER SHALL BE DECIDED BY A TOSS/DRAW OF LOTS, IN THE PRESENCE OF THE RESPECTIVE BIDDER(S) OR THEIR REPRESENTATIVE(S). RANKING WILL BE DONE ACCORDINGLY. BHEL'S DECISION IN SUCH SITUATION SHALL BE FINAL AND BINDING.	
14	<b>TERMS OF DELIVERY:</b> <b>I. FOR INDIGENOUS SUPPLIERS:</b> THE TERMS OF DELIVERY SHOULD BE QUOTED ON F.O.R. DESTINATION (BHEL HERP STORES VARANASI) BASIS ONLY (i.e. FREIGHT & INSURANCE ON VENDOR'S ACCOUNT ONLY). IF ANY BIDDER STILL QUOTES OTHER DELIVERY TERM IN PLACE OF BHEL HERP STORES, THEIR OFFER MAY NOT BE CONSIDERED FOR FURTHER PROCESSING. IT MUST BE SPECIFICALLY NOTED.	
15	IF ANY INDIAN SUPPLIERS ARRANGE SUPPLY FROM FOREIGN PRINCIPLES/WORKS, TERMS OF DELIVERY SHOULD BE QUOTED ON CIF JNPT MUMBAI (INDIA) SEA PORT BASIS ONLY (i.e. FREIGHT & INSURANCE ON VENDOR'S ACCOUNT UPTO JNPT MUMBAI (INDIA) SEA PORT) OR CFR MUMBAI AIRPORT. HOWEVER FREIGHT CHARGES AS PER BHEL TRANSPORT CONTRACT FROM JNPT MUMBAI SEAPORT/MUMBAI AIRPORT TO BHEL VARANASI FOR EACH ITEM WILL BE LOADED AT THE TIME OF TOTAL LANDED COST CALCULATION.	
16	INSURANCE CHARGES SHALL BE TO VENDOR'S ACCOUNT ONLY IF PRICE QUOTED ON BHEL HERP STORES BASIS. IN CASE PRICE QUOTED IS ON CIF JNPT MUMBAI BASIS/ CFR MUMBAI AIRPORT BASIS, INSURANCE UP TO CIF JNPT MUMBAI/ MUMBAI AIRPORT SHALL BE IN VENDOR ACCOUNT.	
17	<p><b>PAYMENT TERMS:</b></p> <p><b>I.FOR MSEs VENDORS:</b> 100% AGAINST SRV WITHIN 45 DAYS THROUGH EFT (ELECTRONIC FUND TRANSFER) FROM THE DATE OF RECEIPT OF MATERIAL (DATE OF SRV) AT BHEL HERP VARANASI STORES AS PER PO.</p> <p><b>II.FOR MEDIUM ENTERPRISES VENDORS:</b> 100% AGAINST SRV WITHIN 60 DAYS THROUGH EFT (ELECTRONIC FUND TRANSFER) FROM THE DATE OF RECEIPT OF MATERIAL (DATE OF SRV) AT BHEL HERP VARANASI STORES AS PER PO.</p> <p><b>III. FOR NON- MSME:</b> 100% AGAINST SRV WITHIN 90 DAYS THROUGH EFT (ELECTRONIC FUND TRANSFER) FROM THE DATE OF RECEIPT OF MATERIAL (DATE OF SRV) AT BHEL HERP VARANASI STORES AS PER PO.</p> <p><b>IV.BHEL HERP WILL MAKE PAYMENTS IN TWO PARTS: -</b></p> <p><b>PART-I:</b> BASIC INVOICE VALUE AND ALL OTHER CHARGES (EXCEPT GST AMOUNT) WILL BE PAID AS PER P.O. PAYMENT TERMS.</p> <p><b>PART-II:</b> GST PORTION OF INVOICE VALUE WILL BE PAID ONLY AFTER FULFILLING FOLLOWING CONDITIONS:</p> <p>(A) PAYMENT OF GST AMOUNT INTO GOVT. ACCOUNT BY SUPPLIER AGAINST INVOICE RAISED TO BHEL.</p> <p>(B) FILING OF GST RETURN</p> <p>(C) DISPLAY OF GST CREDIT AGAINST BHEL GSTIN NO.09AAACB4146P2ZC IN GSTR-2B ON GSTN PORTAL.</p> <p>Note: 1. PAYMENT WILL BE MADE AFTER ACCEPTANCE OF MATERIAL.</p> <p>2. ADVANCE PAYMENT IS NOT ACCEPTABLE BY BHEL HERP VARANASI IN ANY CASE.</p> <p>3. IF ANY SUPPLIER FALLS UNDER “NON MSE” OR “NON MEDIUM” CATEGORY, THEIR PAYMENT TERM WILL BE CONSIDERED AS NON MSME SUPPLIER PAYMENT WITHOUT ANY INTIMATION.</p>	
18	<b>LOADING OF PAYMENT TERM:</b> IN CASE OF DEVIATION, LOADING OF INTEREST RATE @SBI MCLR RATE + 6% (AS ON PART-1 OPENING DATE) SHALL BE LOADED WHILE ARRIVING AT LANDED COST TO BHEL.	
19	<b>LIQUIDATED DAMAGES/ LATE DELIVERY (LD) PENALTY CLAUSE:</b> SUBJECT TO FORCE MAJEURE CONDITIONS, FAILURE TO SUPPLY WITHIN PURCHASE ORDER DELIVERY SCHEDULE WILL MAKE THE SUPPLIER LIABLE TO AN UNCONDITIONAL PENALTY OF 0.5 % PER WEEK OR PART THEREOF SUBJECT TO THE MAXIMUM OF 10% OF THE UNDELIVERED PURCHASE ORDER VALUE EXCLUDING TAXES & DUTIES. NO GRACE PERIOD SHALL BE GIVEN.	
20	<p><b>LOADING OF LIQUIDATED DAMAGES (LD):</b> DEVIATION TO ABOVE STANDARD PENALTY CLAUSE, MAXIMUM LOADING OF 10% (IN CASE OF NON ACCEPTANCE OF LD CLAUSE) OR PART THEREOF (IN CASE OF PART ACCEPTANCE OF LD) SHALL BE LOADED WHILE ARRIVING LANDED COST TO BHEL.</p> <p><b>LOADING OF DELIVERY TERM:</b> FURTHER IF DEVIATION IS FOUND IN THE ACCEPTED DELIVERY TERM AS WELL AS ACCEPTED PENALTY TERM, SUITABLE LOADING BASED ON TRANSPORTATION TIME TO BE TAKEN SHALL BE LOADED WHILE ARRIVING LANDED COST TO BHEL HERP STORES WHICH MAY BE AS BELOW:</p> <p>(i) 1% OF THE BASIC COST FOR INDIAN SUPPLIERS,</p>	

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21	<b>DELIVERY PERIOD:</b> VENDOR SHOULD STRICTLY QUOTE THE DELIVERY PERIOD AS MENTIONED IN NIT.	
22	IF ANY VENDOR DOES NOT SUPPLY THE ITEM WITHIN THE PURCHASE ORDER DELIVERY PERIOD, BHEL MAY/MAY NOT ACCEPT THE SUPPLY AT ITS SOLE DISCRETION.	
23	<p><b>BANK GUARANTEE:</b> THE COST OF BHEL FREE ISSUE MATERIALS PER SET/PER ASSEMBLY AND TOTAL COST OF FIM FOR THE ENQUIRY ARE MENTIONED IN NIT. IN THIS REGARD:</p> <p>1 (a). PARTY WILL HAVE TO SUBMIT EQUAL AMOUNT OF SECURITY DEPOSIT <b>(IN THE FORM OF 10% BG/FDR/DD/CHEQUE/BANK TRANSFER AND 90% INDEMNITY BOND)</b> TOWARDS THE COST OF BHEL MATERIALS TO BE ISSUED TO THEM BEFORE THE ISSUE OF BHEL MATERIALS TO THEM. AT ANY POINT OF TIME, PROPORTIONATE SECURITY DEPOSIT OF TOTAL/CUMMULATIVE MATERIAL VALUE SHOULD BE MAINTAINED.</p> <p>(b) <b>IN CASE OF TRIAL/DEVELOPMENTAL ORDER, PARTY WILL HAVE TO SUBMIT 30% BG/FDR/DD/CHEQUE/BANK TRANSFER AND 70% INDEMNITY BOND TOWARDS THE COST OF BHEL FIM.</b></p> <p>2. BHEL MAY ASK THE SUPPLIER FOR SUBMISSION OF FULL SECURITY DEPOSIT AMOUNT OR PART DEPENDING UPON THE AVAILABILITY OF FREE ISSUE MATERIALS AT OUR END.</p> <p>3. PARTY MUST HAVE TO SUBMIT THE SAME WITHIN 02 WEEK TIME FROM THE DATE OF WRITTEN INTIMATION BY BHEL WITHOUT FAIL OTHERWISE IT WOULD TREATED AS FAILURE OF HONOURING PO TERMS AND ACCORDINGLY BHEL MAY CANCEL THE PURCHASE ORDER AND INITIATE ALTERNATE PROCUREMENT ACTION AT SUPPLIER RISK &amp; COST.</p> <p>4. IN CASE OF ABSENCE OF DESIRED SECURITY DEPOSIT AT BHEL END AND ALSO NON RESPONSE OF POINT NO. 03 AS ABOVE,</p> <p>I. BHEL MAY HOLD THE PENDING PAYMENTS OF SUPPLIER AVAILABLE AT BHEL <b>ON THEIR CONSENT.</b></p> <p>II. IF NO PAYMENT IS PENDING AT BHEL END, ACTION FOR ALTERNATE PROCUREMENT ACTION MAY BE INITIATED.</p> <p><b>5. THE FORMAT OF BG AND IB SHALL BE PER ATTACHED ANNEXURE-BG/FIM AND IB-FIM RESPECTIVELY.</b></p>	
24	TRANSPORTATION CHARGES FOR SENDING BHEL FREE ISSUE MATERIALS (FIM) TO THE PARTY WORKS WILL BE BORNE BY BHEL ONLY. THE FREIGHT CHARGES FOR SENDING THE BHEL FIM FROM HERP STORES TO PARTY'S WORK FOR EACH ITEM WILL BE LOADED AS PER BHEL TRANSPORT CONTRACT AT THE TIME OF TOTAL LANDED COST CALCULATION. HOWEVER, VARANASI/LOCAL BASED VENDORS WILL LIFT THE FIM FROM BHEL STORES AND BORNE ITS TRANSPORTATION CHARGES.	
25	IF BHEL ISSUES FREE ISSUE MATERIALS TO THE SUPPLIER, IT MUST BE RETURNED WITHIN THE TIME LIMIT AS PRESCRIBED IN GST LAW (PRESENTLY 01 (ONE) YEAR FROM THE DATE OF FREE ISSUE DATE) TO COMPLY THE GST RULES. IF ANY VENDOR DOES NOT RETURN THE BHEL FREE ISSUE MATERIALS AS MENTIONED ABOVE, THE FINANCIAL IMPLICATION ON ACCOUNT OF THIS, IF ANY, SHALL BE RECOVERED FROM THE PARTY BILLS.	
26	<p><b>REVERSE AUCTION:</b> BHEL SHALL BE RESORTING TO REVERSE AUCTION (RA) (GUIDELINES AS AVAILABLE ON <a href="http://WWW.BHEL.COM">WWW.BHEL.COM</a>) FOR THIS TENDER. RA SHALL BE CONDUCTED AMONG ALL THE TECHNO-COMMERCIALLY QUALIFIED BIDDERS.</p> <p>PRICE BIDS OF ALL TECHNO-COMMERCIALLY QUALIFIED BIDDERS SHALL BE OPENED AND SAME SHALL BE CONSIDERED AS INITIAL BIDS OF BIDDERS IN RA. IN CASE ANY BIDDER(S) DO (ES) NOT PARTICIPATE IN ONLINE REVERSE AUCTION, THEIR SEALED ENVELOPE PRICE BID ALONG WITH APPLICABLE LOADING, IF ANY, SHALL BE CONSIDERED FOR RANKING.</p>	
27	IF ANY OF THE VENDORS DO NOT ACCEPT THE ABOVE POINT MENTIONED AT SL. NO. 26, THEIR OFFER MAY BE LIABLE FOR REJECTION WITHOUT INTIMATION.	
28	<p><b>RISK PURCHASE:</b> IN CASE OF DELAY IN SUPPLIES/ DEFECTIVE SUPPLIES/NON EXECUTION OF PURCHASE ORDER ETC. (FOR DETAILS, REFER GUIDELINES FOR RISK PURCHASE), BHEL MAY CANCEL THE ORDER IN FULL OR PART THEREOF/ MAY ALSO MAKE THE PURCHASE OF SUCH MATERIALS FROM ELSEWHERE/ALTERNATIVE SOURCES AT THE RISK &amp; COST OF SUPPLIER. BHEL MAY ALSO MANUFACTURE THE ITEM IN-HOUSE IN PART OR FULL DEPENDING UPON THE URGENCY OF THE ITEM.</p> <p>GUIDELINES FOR <b>RISK PURCHASE</b> IS AVAILABLE ON BHEL WEBSITE "<a href="https://herp.bhel.com">https://herp.bhel.com</a>" at "Notice". RESPECTIVE BIDDERS / SUPPLIERS MAY REFER THIS GUIDELINE BEFORE SUBMITTING THEIR OFFER AGAINST BHEL, HERP TENDER ENQUIRIES. IN CASE RISK PURCHASE IS APPLIED, BHEL SHALL TAKE ACTION AGAINST THE NON-PERFORMING AND/OR DEFAULTING SUPPLIERS/ CONTRACTORS IN LINE WITH THIS GUIDELINE ONLY.</p>	
29	<p>BHEL MAY SHORT CLOSE/CANCEL AN ORDER AT ANY TIME DURING THE CURRENCY OF THE CONTRACT/PO IRRESPECTIVE OF THE PO DELIVERY DATE, IF</p> <p>(I) THE WORK PROGRESS OF THE VENDOR IS POOR, OR</p> <p>(II) THE DELIVERY REQUIREMENT OF THE ITEM IS VERY CRITICAL &amp; NOT BEING MET BY THE VENDOR ON WHICH ORDER HAS BEEN PLACED, OR</p> <p>(III) THERE IS NO RESPONSE FOR IMPROVEMENT IN DELIVERY AS PER BHEL REQUIREMENT,</p>	
30	THE OFFERS OF THE BIDDERS WHO ARE ON THE BANNED LIST AND ALSO THE OFFER OF THE BIDDERS, WHO ENGAGE THE SERVICES OF THE BANNED FIRMS, SHALL BE REJECTED. THE LIST OF BANNED FIRMS IS AVAILABLE ON BHEL WEB SITE <a href="http://www.bhel.com">www.bhel.com</a>	
31	<b>RESERVATION RIGHTS OF BHEL:</b> – BHEL RESERVES THE RIGHT TO REJECT ANY OR ALL QUOTATIONS WITHOUT ASSIGNING ANY REASONS THEREOF. BHEL ALSO RESERVES THE RIGHT TO INCREASE OR DECREASE THE TENDERED QUANTITIES. VENDORS SHOULD BE PREPARED TO ACCEPT ORDER FOR REDUCED QUANTITIES WITHOUT ANY EXTRA CHARGES. VENDOR SHOULD ALSO BE PREPARED FOR GIVING DISCOUNT IN CASE OF INCREASE IN QUANTITY.	
32	<b>NON-DISCLOSURE AGREEMENT:</b> ALL DRAWINGS AND STANDARDS ARE PROPRIETARY OF BHEL. IT MUST NOT BE USED IN ANY WAY DETRIMENTAL TO THE INTEREST OF THE COMPANY. ALL SUPPLIERS SHALL FURNISH NDAS (NON-DISCLOSURE AGREEMENT) AGAINST USE OF DOCUMENTS FURNISHED BY BHEL TOWARDS UN-AUTHORIZED USE EXCEPT FOR THE PURPOSE IT HAS BEEN FURNISHED.	
33	<p><b>A. SETTLEMENT OF DISPUTES &amp; ARBITRATION:</b></p> <p>I. ALL QUESTIONS/INTERPRETATIONS REGARDING SUBJECT MATTER OF THE CONTRACT SHALL BE DECIDED BY THE BHEL ON THE REQUEST OF THE VENDOR AND THE DECISION OF THE BHEL SHALL BE FINAL.</p> <p>II. IN CASE OF DISPUTE, STEPS SHALL BE TAKEN BY THE PARTIES TO THE CONTRACT TO SETTLE THE SAME THROUGH NEGOTIATIONS.</p> <p>III. IN CASE, DISPUTE IS NOT SETTLED IN NEGOTIATIONS, IT SHALL BE REFERRED TO CONCILIATOR APPOINTED BY THE COMPETENT AUTHORITY OF THE BHEL. <i>THE CONCILIATION PROCEEDINGS WITH RESPECT TO A DISPUTE AS DEFINED IN THE BHEL CONCILIATION SCHEME, 2018 AND SUBSEQUENT REVISIONS CAN BE INITIATED UNDER THE SCHEME AT ANY STAGE WHETHER BEFORE, DURING OR EVEN AFTER THE COMMENCEMENT OF ARBITRATION PROCEEDINGS OR LITIGATION BEFORE COURTS. THIS CONCILIATION SCHEME IS AVAILABLE ON OUR WEBSITES <a href="https://herp.bhel.com">https://herp.bhel.com</a> AND <a href="http://www.bhel.com">www.bhel.com</a> .</i></p> <p>IV. IN CASE DISPUTE IS NOT SETTLED IN CONCILIATION PROCEEDINGS, THE SAME SHALL BE REFERRED TO ARBITRATION AS PER CORPORATE GUIDELINES OF THE BHEL AND THE ARBITRATION PROCEEDING SHALL BE CONDUCTED AS PER PROVISIONS OF THE ARBITRATION AND CONCILIATION ACT, 1996 READ WITH CORPORATE GUIDELINE AS AMENDED FROM TIME TO TIME.</p> <p>V. THE VENDOR SHALL CONTINUE TO PERFORM THE CONTRACT, PENDING SETTLEMENT OF DISPUTE(S).</p> <p><b>B. JURISDICTION:</b> ALL DISPUTES OR DIFFERENCES ARISING OUT OF OR IN CONNECTIONS WITH THE CONTRACT SHALL BE SUBJECT TO THE EXCLUSIVE JURISDICTION OF THE COURT AT VARANASI (U.P.) ONLY.</p>	
34	<b>SPECIAL NOTE FOR BIDDERS:</b> THE QUOTATION SHOULD BE FROM PRINCIPAL / ORIGINAL EQUIPMENT MANUFACTURER ONLY. THE OFFER OF THOSE OEM, AUTHORISING THEIR TRADER / DEALER / DISTRIBUTOR TO QUOTE AND TAKE ORDER IS LIABLE FOR DISQUALIFICATION. SINCE BHEL PREFER TO DEAL DIRECTLY WITH OEM AND NOT THROUGH DEALER / TRADER / DISTRIBUTOR OF OEM, THEREFORE, OEM MUST DIRECTLY QUOTE, TAKE ORDER AND DELIVER THE MATERIAL UNDER THEIR GUARANTEE / WARRANTEE.	
35	<p>I. FOLLOWING DOCUMENTS SHOULD BE ENCLOSED AND ADDRESSED TO DGM (FINANCE) AND SAME SHALL BE DISPATCHED TO MM DEPTT. BHEL, HERP, TARNA, SHIVPUR, VARANASI-221003 FOR PAYMENT PURPOSE:</p> <p>a) 05 (FIVE) COPIES OF GST INVOICES</p> <p>b) COPY OF GR/RR.</p> <p>c) TEST CERTIFICATE AND GUARANTEE/WARRANTEE CERTIFICATE AND PDI REPORT, IF APPLICABLE. (ONE COPY).</p> <p>II. FURTHER TO ABOVE, 02 (TWO) COMPLETE SETS OF DOCUMENTS (COPIES OF ABOVE MENTIONED DOCUMENTS AT SL. NO. I FOR INDIAN SUPPLIERS (UNDER THIS CLAUSE) SHALL BE SENT FOR PURCHASE AND QUALITY DEPARTMENTS. ORIGINAL COPIES OF TC, GC, PDI REPORTS &amp; OTHER QUALITY PAPERS SHALL BE ATTACHED IN THE SET OF DOCUMENTS FOR QUALITY DEPARTMENTS.</p> <p>III. THE VENDOR SHOULD PROVIDE BILLS &amp; OTHER DOCUMENTS COMPLETE IN ALL RESPECT AS PER PURCHASE ORDER ALONGWITH DESPATCH OF MATERIALS. BHEL SHALL SEEK CLARIFICATION(S) (IF ANY) RELATED TO PAYMENT DOCUMENTS IN ONE GO. THE VENDOR SHOULD PROVIDE ALL SUCH CLARIFICATION(S) IMMEDIATELY. ANY DELAY IN PROCESSING OF PAYMENT, DUE TO NON RECEIPT OF CLARIFICATION(S) SOUGHT BY BHEL, SHALL BE ATTRIBUTABLE COMPLETELY TO VENDOR.</p> <p>IV. DIGITALLY SIGNED INVOICE IS ALSO ACCEPTABLE FOR PROCESSING OF PAYMENT.</p>	



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36	THE VENDOR SHALL ENSURE THAT THEIR BANK DETAILS ARE UPDATED WITH US FOR TIMELY PAYMENT THROUGH EFT (ELECTRONICS FUND TRANSFER).	
37	<b>GUIDELINES FOR SUSPENSION OF BUSINESS DEALINGS WITH SUPPLIERS/ CONTRACTORS:</b> THE REVISED GUIDELINES FOR SUSPENSION OF BUSSINESS DEALINGS ARE AVAILABLE ON BHEL WEBSITE AT “www.bhel.com” on “SUPPLIER REGISTRATION PAGE”. RESPECTIVE BIDDERS / SUPPLIERS MAY REFER THIS BEFORE QUOTING AS PER THEIR REQUIREMENT. ACTION AGAINST THE DEFAULTED SUPPLIERS/ CONTRACTORS’ SHALL BE TAKEN AS PER THESE GUIDELINES ONLY.	
38	VENDOR MUST FOLLOW THE SEQUENTIAL DELIVERY SCHEDULE i.e. ITEMS TO BE SUPPLIED IN SUCH A MANNER THAT THE PURCHASE ORDER HAVING OLDER DELIVERY SCHEDULE SHOULD BE SUPPLIED EARLIER AND PURCHASE ORDER HAVING LATTER DELIVERY SCHEDULE TO BE SUPPLIED LATTER. IF ANY VENDOR DOES NOT FOLLOW THE SEQUENTIAL DELIVERY SCHEDULE ESPECIALLY FOR SAME ITEM, BHEL MAY ACCOUNT FOR THE ITEM IN SEQUENTIAL MANNER OR MAY RECOVER THE FINANCIAL IMPLICATION.	
39	ALL ABOVE ACCEPTED TERMS & CONDITIONS SHALL BE PART OF PURCHASE ORDER WITH OR WITHOUT MENTIONING IN THE PO/CONTRACT BASED ON YOUR ACCEPTANCE AND OFFER SUBMITTED.	
40	<b>IMPORTANT INSTRUCTION:</b> I.VENDORS ARE REQUESTED TO QUOTE THEIR RATE WITH DESCRIPTION MENTIONED IN THE ENQUIRY CONSIDERING ALL TECHNICAL TERMS & CONDITIONS OF THE ENQUIRY. ALSO RATES QUOTED SHOULD BE EXACTLY AS PER SL. NO. OF HARD COPY OF THE ENQUIRY (IF ENQUIRY HAS BEEN FLOATED THROUGH CONVENTIONAL MODE) OR AS PER SL. NO. APPEARING IN THE e-Procurement PORTAL (IF ENQUIRY HAS BEEN FLOATED THROUGH e-Procurement) ONLY. IT MUST BE FOLLOWED UP TO AVOID CONFUSION AT LATER STAGES. ALSO RATES TO BE SUBMITTED BOTH IN NUMERICS AS WELL AS IN WORD. IN CASE OF DISCREPENCY, RATES SUBMITTED IN WORDS SHALL BE CONSIDERED FOR FURTHER PROCESSING. II.DOCUMENTS SUBMITTED WITH THE OFFER SHOULD BE SIGNED AND STAMPED IN EACH PAGE BY AUTHORIZED REPRESENTATIVE OF THE BIDDER. II.II.IN CASE OF PDI, VENDOR SHALL RAISE ONLINE INSPECTION CALL IN ONLINE INSPECTION PORTAL/INTIMATE BHEL IN WRITTING (WHERE INSPECTION IS IN BHEL HERP SCOPE) AT LEAST 01 WEEK IN ADVANCE OR AS MUTUALLY AGREED PERIOD ABOUT THE DATE AND PLACE AT WHICH GOODS WILL BE READY FOR INSPECTION. IV.PURCHASER OR HIS AUTHORIZED REPRESENTATIVE SHALL BE ENTITLED TO CARRY OUT SURVEILLANCE INSPECTION OF MATERIAL AND WORKMANSHIP AT SELLER’S PREMISES OR AT HIS SUB-CONTRACTOR’S PREMISES AT ALL REASONABLE TIMES DURING EXECUTION OF THE CONTRACT. SUCH INSPECTION, EXAMINATION AND TESTING, IF MADE, SHALL NOT ABSOLVE THE SELLER FROM HIS OBLIGATIONS UNDER THE CONTRACT. V.SUCH PRE-DISPATCH INSPECTION, EXAMINATION AND TESTING, IF MADE, AT VENDOR’S WORKS SHALL NOT ABSOLVE THE SELLER FROM HIS OBLIGATIONS TO MANUFACTURE/MACHINING THE GOODS UNDER THE CONTRACT. IF DEFECTS ARE FOUND AT LATER STAGE, IT IS THE SOLE RESPONSIBILITY OF THE VENDOR TO REPLACE/RECTIFY THE SAME.	
41	<b>IMPORTANT CLAUSE FOR GST:</b> INPUT TAX CREDIT OF GST CAN BE AVAILED BY BHEL ONLY WHEN THE MATERIAL HAS BEEN PHYSICALLY RECEIVED AND GST INVOICE IS IN POSSESSION OF BHEL. THEREFORE, SUPPLIERS SHOULD ENSURE THE FOLLOWING IN RESPECT OF POS ISSUED BY BHEL: I. GST INVOICE SHOULD CONTAIN ADDRESS, GST NO. AND PAN NO. OF BHEL AS WELL AS OF SUPPLIER. APPLICABLE HSN CODE OF THE MATERIAL SHOULD BE INDICATED IN THE GST INVOICE. II. FIVE COPIES OF GST INVOICE AND LORRY RECEIPT MAY BE DESPATCHED ALONGWITH SHIPMENT OF THE GOODS IN ORDER TO AVOID ANY DELAY IN AVAILING INPUT CREDIT BY BHEL. III. DECLARE SUCH INVOICE IN HIS GSTR-1 RETURN FOR THE MONTH OF DESPATCH OF MATERIAL. IV. PAYMENT OF GST TO STATUTORY AUTHORITIES WITHIN PRESCRIBED TIME. V. IN CASE OF DISCREPANCY IN THE DATA UPLOADED BY THE BIDDER IN THE GSTN PORTAL VIS-A-VIS THE TAX INVOICE OR IN CASE OF ANY SHORTAGES OR REJECTION IN THE SUPPLY, THEN BHEL WILL NOT BE ABLE TO AVAIL THE TAX CREDIT. BIDDER HAS TO RECTIFY THE DATA DISCREPANCY IN THE GSTN PORTAL OR ISSUE CREDIT NOTE OR DEBIT NOTE (DETAILS ALSO TO BE UPLOADED IN GSTN PORTAL) FOR THE SHORTAGES OR REJECTIONS IN THE SUPPLIES OR ADDITIONAL CLAIMS FOR PROCESSING OF SUCH INVOICES. VI. GST TDS DEDUCTED AS PER GST ACT, IS UPLOADED IN GSTN PORTAL ALONG GSTR7. BIDDERS CAN DIRECTLY DOWNLOAD THE GST TDS CERTIFICATE FROM THE GSTN PORTAL.  IN CASE GST CREDIT IS DELAYED /DENIED TO BHEL DUE TO NON OR DELAYED RECEIPT OF GOODS AND OR TAX INVOICE OR EXPIRY OF TIMELINE PRESCRIBED IN GST LAW FOR AVAILING SUCH ITC OR ANY OTHER REASON NOT ATTRIBUTABLE TO BHEL, GST AMOUNT SHALL BE RECOVERABLE FROM VENDOR ALONG WITH INTEREST /PENALTY LEVIABLE ON BHEL.  IN CASE SUPPLIERS DELAYS DECLARING SUCH INVOICE IN HIS RETURN AND GST CREDIT AVAILED BY BHEL IS DENIED OR REVERSED SUBSEQUENTLY AS PER GST LAW, GST AMOUNT PAID BY BHEL TOWARDS SUCH ITC REVERSAL SHALL BE RECOVERABLE FROM SUPPLIER ALONGWITH INTEREST LEVIED/LEVIABLE ON BHEL.  IN CASE OF RAISING ANY SUPPLEMENTARY TAX INVOICE (DEBIT/ CREDIT NOTE), THE SUPPLIER SHALL ISSUE THE SAME CONTAINING ALL THE DETAILS AS REFERRED TO IN SECTION 34 READ WITH SECTION 31 OF GST ACT & RULES REFERRED THERE UNDER .	
42	<b>STATUTORY VARIATION CLAUSE :</b> ANY INCREASE IN THE RATE OF GST SHALL BE PAYABLE ONLY FOR DELIVERIES COMPLETED WITHIN THE SCHEDULED DELIVERY PERIOD, IN OTHER WORDS INCREASE IN THE RATE OF GST SHALL NOT BE PAYABLE FOR VALUE OF CONSIGNMENT DELIVERED AFTER THE SCHEDULED PURCHASE ORDER DELIVERY PERIOD.2.NEW TAXES AND DUTIES , IF IMPOSED SUBSEQUENT TO DUE DATE OF OFFER SUBMISSION, BY STATUTORY AUTHORITY DURING CONTRACT PERIOD (INCLUDING EXTENSION IF THE SAME IS NOT ATTRIBUTABLE TO BIDDER) SHALL BE REIMBURSED BY BHEL ON PRODUCTION OF RELEVANT SUPPORTING DOCUMENTS TO THE SATISFACTION OF BHEL . HOWEVER, BIDDER SHALL TAKE PRIOR APPROVAL OF BHEL BEFORE DEPOSITING NEW TAXES AND DUTIES.	
43	<b>IMPORTANT INSTRUCTION FOR MSEs SUPPLIERS:</b> I. “MSE SUPPLIERS CAN AVAIL THE INTENDED BENEFITS ONLY IF THEY SUBMIT ALONG WITH OFFER, ATTESTED COPIES OF EITHER EM-II CERTIFICATE HAVING DEEMED VALIDITY (FIVE YEARS FROM THE DATE OF ISSUE OF ACKNOWLEDGEMENT IN EM-II) OR VALID NSIC CERTIFICATE OR EM-II CERTIFICATE ALONG WITH CA CERTIFICATE (FORMAT ENCLOSED AS PER ANNEXURE-1 WHERE DEEMED VALIDITY OF EM-II CERTIFICATE OF FIVE YEARS HAS EXPIRED) APPLICABLE FOR THE RELEVANT F/Y (LATEST AUDITED).DATE TO BE RECKONED FOR DETERMINING THE DEEMED VALIDITY WILL BE THE DATE OF BID OPENING (PART -1 IN CASE OF TWO PART BID). NON SUBMISSION OF SUCH DOCUMENTS WILL LEAD TO CONSIDERATION OF THEIR BID AT PAR WITH OTHER BIDDERS. NO BENEFIT SHALL BE APPLICABLE FOR THIS ENQUIRY IF ANY DEFICIENCY IN THE ABOVE REQUIRED DOCUMENTS ARE NOT SUBMITTED BEFORE PRICE BID OPENING. IF THE TENDER IS TO BE SUBMITTED THROUGH e-procurement PORTAL, THEN THE ABOVE REQUIRED DOCUMENTS ARE TO BE UPLOADED ON THE PORTAL. DOCUMENTS SHOULD BE NOTARIZED OR ATTESTED BY A GAZETTED OFFICE. II.IN CASE OF ANY CHANGE IN THE MSE STATUS OF THE BIDDER, IT SHALL BE RESPONSIBILITY OF THE BIDDER TO NOTIFY THE CHANGE AS A PART OF THE BID DOCUMENT. IF AT A LATER DATE IT COMES TO NOTICE OF BHEL, THAT THE CHANGE IN THE STATUS HAS NOT BEEN INTIMATED BY THE BIDDER AND THE ORDER IS OBTAINED UNDER THE PREMISE OF AN MSE, THEN BHEL WOULD CANCEL THE PENDING ORDER AGAINST THIS TENDER AND TAKE NECESSARY ACTION SUSPENSION OF THE BUSSINESS DEALING WITH THE BIDDER AS PER PROCUREMENT POLICY OF BHEL. III.25 % OF THE TENDERED QUANTITY IS EARMARKED FOR MSE SUPPLIERS IN THIS TENDER. IV.OUT OF THIS 25% TENDERED QUANTITY RESERVED FOR MSE SUPPLIERS, 6.25% SHALL BE EARMARKED FOR PROCUREMENT FROM MSEs OWNED BY SC/ST ENTREPRENEURS. V.OUT OF THIS 25% TENDERED QUANTITY RESERVED FOR MSE SUPPLIERS, 3% SHALL BE EARMARKED FOR PROCUREMENT FROM MSEs OWNED BY WOMEN. VI.IN CASE MSE VENDOR PARTICIPATING IN THE TENDER QUOTES WITHIN THE PRICE BAND OF “L1+15%”, THEY WILL BE ALLOWED TO SUPPLY THE 25% PORTION OF THE REQUIREMENT SUBJECT TO ACCEPTANCE OF L1 PRICE (ON LANDED COST BASIS) BY MSE VENDOR. IN CASE OF MORE THAN ONE SUCH MSE VENDOR WITHIN THE “L1+15% PRICE BAND” THE SUPPLY SHALL BE SHARED PROPORTIONATELY (TO 25% TENDERED QUANTITY). VII.IF THE L1 VENDOR HAPPENS TO BE A MSE VENDOR AGAINST ANY ITEM CODE, THEN 100% OF THE TENDERED QTY (FOR RESPECTIVE ITEM CODE) SHALL BE PROPOSED TO ORDER ON THE L1 (MSE) VENDOR, EVEN THOUGH THERE MAY BE OTHER MSE VENDORS WITHIN THE “L1+15% PRICE BAND”. VIII.IN CASE AFTER OPENING OF PRICE BID, IT IS SEEN THAT NO MSE HAS BECOME L1, THEN DEPENDING ON THE NATURE OF THE ITEM, IF IT IS NOT POSSIBLE TO SPLIT THE TENDERED ITEMS/QUANTITIES ON ACCOUNT OF REASONS LIKE CUSTOMER CONTRACT REQUIREMENTS OF SUPPLYING ONE MAKE FOR A GIVEN PROJECT OR TECHNICAL REASONS LIKE TENDERED ITEMS BEING A SYSTEM etc. THEN BHEL WOULD NOT COUNTER OFFER THE L1 PRICES EVEN THOUGH THERE MAY BE MSE BIDDERS WITHIN THE “L1+15% PRICE BAND” OF L1.	
44	THE <b>STARTUPS</b> AS DEFINED IN THE GAZETTE OF INDIA NOTIFICATION NO.: G.S.R. 127 (E) DATED 19/02/2019 WILL BE EXEMPTED FROM FULFILLING THE CRITERIA, IF MENTIONED, IN THE PQR (PRE-QUALIFYING REQUIREMENT) REGARDING PRIOR TURNOVER AND PRIOR EXPERIENCE. HOWEVER, THERE MAY BE CIRCUMSTANCES (LIKE PROCUREMENTS OF ITEMS RELATED TO PUBLIC SAFETY, HEALTH, CRITICAL SECURITY OPERATIONS AND EQUIPMENTS ETC.) WHERE BHEL MAY PREFER THE VENDORS TO HAVE PRIOR EXPERIENCE RATHER THAN GIVING ORDER TO NEW ENTITIES. FOR SUCH PROCUREMENTS, BHEL MAY NOT RELAX THE CRITERIA OF PRIOR EXPERIENCE/TURNOVER FOR THE STARTUPS.	
45	<b>PURCHASE PREFERENCE FOR INDIAN VENDORS:</b> FOR THIS PROCUREMENT, THE LOCAL CONTENT TO CATEGORIZE A SUPPLIER AS A CLASS I LOCAL SUPPLIER / CLASS II LOCAL SUPPLIER /NON LOCAL – SUPPLIER AND PURCHASE PREFERENCE TO CLASS I LOCAL SUPPLIER, IS AS DEFINED IN PUBLIC PROCUREMENT (PREFERENCE TO MAKE IN INDIA), ORDER	

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	<p>2017 DATED 04.06.2020 ISSUED BY DPIIT. IN CASE OF SUBSEQUENT ORDERS ISSUED BY THE NODAL MINISTRY, CHANGING THE DEFINITION OF LOCAL CONTENT FOR THE ITEMS OF THE NIT, THE SAME SHALL BE APPLICABLE EVEN IF ISSUED AFTER ISSUE OF THIS NIT, BUT BEFORE OPENING OF PART –II BIDS AGAINST THIS NIT.</p> <p><b>MODEL CLAUSE FOR TENDER.</b></p> <p>I. ANY BIDDER FROM A COUNTRY WHICH SHARES A LAND BORDER WITH INDIA WILL BE ELIGIBLE TO BID IN THIS TENDER ONLY IF THE BIDDER IS REGISTERED WITH THE COMPETENT AUTHORITY.</p> <p>II. "BIDDER" (INCLUDING THE TERM 'TENDERER', 'CONSULTANT' OR 'SERVICE PROVIDER' IN CERTAIN CONTEXTS) MEANS ANY PERSON OR FIRM OR COMPANY, INCLUDING ANY MEMBER OF A CONSORTIUM OR JOINT VENTURE (THAT IS AN ASSOCIATION OF SEVERAL PERSONS, OR FIRMS OR COMPANIES), EVERY ARTIFICIAL JURIDICAL PERSON NOT FALLING IN ANY OF THE DESCRIPTIONS OF BIDDERS STATED HEREINBEFORE, INCLUDING ANY AGENCY BRANCH OR OFFICE CONTROLLED BY SUCH PERSON, PARTICIPATING IN A PROCUREMENT PROCESS.</p> <p>III. "BIDDER FROM A COUNTRY WHICH SHARES A LAND BORDER WITH INDIA" FOR THE PURPOSE OF THIS ORDER MEANS: -</p> <p>a) AN ENTITY INCORPORATED, ESTABLISHED OR REGISTERED IN SUCH A COUNTRY; OR</p> <p>b) A SUBSIDIARY OF AN ENTITY INCORPORATED, ESTABLISHED OR REGISTERED IN SUCH A COUNTRY; OR</p> <p>c) AN ENTITY SUBSTANTIALLY CONTROLLED THROUGH ENTITIES INCORPORATED, ESTABLISHED OR REGISTERED IN SUCH A COUNTRY; OR</p> <p>d) AN ENTITY WHOSE BENEFICIAL OWNER IS SITUATED IN SUCH A COUNTRY; OR</p> <p>e) AN INDIAN (OR OTHER) AGENT OF SUCH AN ENTITY; OR</p> <p>f) A NATURAL PERSON WHO IS A CITIZEN OF SUCH A COUNTRY; OR</p> <p>g) A CONSORTIUM OR JOINT VENTURE WHERE ANY MEMBER OF THE CONSORTIUM OR JOINT VENTURE FALLS UNDER ANY OF THE ABOVE</p> <p>IV. THE BENEFICIAL OWNER FOR THE PURPOSE OF (III) ABOVE WILL BE AS UNDER:</p> <p>1. IN CASE OF A COMPANY OR LIMITED LIABILITY PARTNERSHIP, THE BENEFICIAL OWNER IS THE NATURAL PERSON (S) WHO, WHETHER ACTING ALONE OR TOGETHER, OR THROUGH ONE OR MORE JURIDICAL PERSON, HAS A CONTROLLING OWNERSHIP INTEREST OR WHO EXERCISES CONTROL THROUGH OTHER MEANS.</p> <p>EXPLANATION –</p> <p>a. "CONTROLLING OWNERSHIP INTEREST" MEANS OWNERSHIP OF OR ENTITLEMENT TO MORE THAN TWENTY-FIVE PER CENT. OF SHARES OR CAPITAL OR PROFITS OF THE COMPANY</p> <p>b. "CONTROL" SHALL INCLUDE THE RIGHT TO APPOINT MAJORITY OF THE DIRECTORS OR TO CONTROL THE MANAGEMENT OR POLICY DECISIONS INCLUDING BY VIRTUE OF THEIR SHAREHOLDING OR MANAGEMENT RIGHTS OR SHAREHOLDER'S AGREEMENTS OF VOTING AGREEMENTS;</p> <p>2. IN CASE OF A PARTNERSHIP FIRM, THE BENEFICIAL OWNER IS THE NATURAL PERSON (S) WHO, WHETHER ACTING ALONE OR TOGETHER, OR THROUGH ONE OR MORE JURIDICAL OF CAPITAL OR PROFITS OF THE PARTNERSHIP;</p> <p>3. IN CASE OF AN UNINCORPORATED ASSOCIATION OR BODY OF INDIVIDUALS, THE BENEFICIAL OWNER IS THE NATURAL PERSON (S), WHO, WHETHER ACTING ALONE OR TOGETHER, OR THROUGH ONE OR MORE JURIDICAL PERSON, HAS OWNERSHIP OF OR ENTITLEMENT TO MORE THAN FIFTEEN PERCENT OF THE PROPERTY OF CAPITAL OF PROFITS OF SUCH ASSOCIATION OR BODY OF INDIVIDUALS;</p> <p>4. WHERE NO NATURAL PERSON IS IDENTIFIED UNDER (1) OR (2) OR (3) ABOVE, THE BENEFICIAL OWNER IS THE RELEVANT NATURAL PERSON WHO HOLDS THE POSITION OF SENIOR MANAGING OFFICIAL;</p> <p>5. IN CASE OF TRUST, THE IDENTIFICATION OF BENEFICIAL OWNER (S) SHALL INCLUDE IDENTIFICATION OF THE AUTHOR OF THE TRUST, THE TRUSTEE, THE BENEFICIARIES WITH FIFTEEN PERCENT OR MORE INTEREST IN THE TRUST AND ANY OTHER NATURAL PERSON EXERCISING ULTIMATE EFFECTIVE CONTROL OVER THE TRUST THROUGH A CHAIN OF CONTROL OR OWNERSHIP.</p> <p>V. AN AGENT IS A PERSON EMPLOYED TO DO ANY ACT FOR ANOTHER, OR TO REPRESENT ANOTHER IN DEALINGS WITH THIRD PERSON.</p> <p><b>CERTIFICATE:</b> IN ORDER TO AVOID THE BENEFITS, VENDORS TO SUBMIT (ALONG WITH OFFER) THE SELF-CERTIFICATION THAT THE ITEM OFFERED MEETS THE CONTENT REQUIREMENT FOR CLASS-I/ CLASS-II LOCAL SUPPLIER AS THE CASE MAY BE, INDICATING THE PERCENTAGE OF LOCAL CONTENT. AND SHALL GIVE DETAILS OF LOCATION AT WHICH THE LOCAL VALUE ADDITION IS MADE (refer attached Make in India (Model Certificate no I).</p>	
46	<p><b>FORCE MAJEURE :</b> NOTWITHSTANDING ANYTHING CONTAINED IN THE CONTRACT, NEITHER THE VENDOR NOR THE BHEL SHALL BE HELD RESPONSIBLE FOR TOTAL OR PARTIAL NON-EXECUTION OF ANY OF THE CONTRACTUAL OBLIGATIONS, SHOULD THE OBLIGATION BECOME UNREASONABLY ONEROUS OR IMPOSSIBLE DUE TO OCCURRENCE OF A 'FORCE MAJEURE' WHICH DIRECTLY AFFECTS THE OBLIGATIONS TO BE PERFORMED BY THE BHEL OR THE VENDOR ; SUCH EVENTS INCLUDE WAR, MILITARY OPERATIONS OF ANY NATURE, BLOCKAGES, REVOLUTIONS, INSURRECTIONS, RIOTS, CIVIL COMMOTIONS, INSURGENCY, SABOTAGE, ACTS OF PUBLIC ENEMY, FIRES, EXPLOSION, EPIDEMICS, QUARANTINE RESTRICTIONS, FLOODS, EARTHQUAKE, OR ACTS OF GOD, RESTRICTIONS BY GOVT. AUTHORITIES; OVER WHICH THE VENDOR OR THE BHEL HAS NO CONTROL. THE PARTY CLAIMING TO BE AFFECTED BY FORCE MAJEURE SHALL NOTIFY THE OTHER PARTY IN WRITING WITHOUT DELAY, WITHIN TWO WEEKS ON THE INTERVENTION AND ON THE CESSATION OF SUCH CIRCUMSTANCE. EXTENSION OF TIME SOUGHT BY THE VENDOR ALONG WITH SUPPORTING EVIDENCE AND SO GRANTED BY THE BHEL FOR THE SUPPLY/ WORK AFFECTED, IF ANY, SHALL NOT BE CONSTRUED AS WAIVER IN RESPECT OF REMAINING DELIVERIES. RESCHEDULING OF DELIVERIES ON ACCOUNT OF FORCE MAJEURE CONDITIONS, IF SO AGREED BY THE BHEL, WILL NOT ENTAIL THE VENDOR TO CLAIM ANY INCREASE IN THE PRICE ON WHATSOEVER ACCOUNT. NOTWITHSTANDING ABOVE PROVISIONS, BHEL SHALL RESERVE THE RIGHT TO CANCEL THE ORDER/ CONTRACT, WHOLLY OR PARTLY, IN ORDER TO MEET THE OVERALL PROJECT SCHEDULE AND MAKE ALTERNATIVE ARRANGEMENTS. IF DEEMED NECESSARY, BHEL MAY TAKEOVER PARTLY PROCESSED MATERIAL AT A MUTUALLY AGREED PRICE.</p>	
47	<p><b>FRAUD PREVENTION POLICY :</b> THE BIDDER ALONG WITH ITS ASSOCIATE/ COLLABORATORS/ SUB-CONTRACTORS/ SUB-VENDORS/ CONSULTANTS/ SERVICE PROVIDERS SHALL STRICTLY ADHERE TO BHEL FRAUD PREVENTION POLICY DISPLAYED ON BHEL WEBSITE WWW.BHEL.COM AND SHALL IMMEDIATELY BRING TO THE NOTICE OF BHEL MANAGEMENT ABOUT ANY FRAUD OR SUSPECTED FRAUD AS SOON AS IT COMES TO THEIR NOTICE.</p>	
48	<p><b>SHORT SHIPMENTS/ WARRANTY/GUARANTEE REPLACEMENTS:</b> IN CASE OF ANY SHORT SHIPMENT DURING INITIAL SUPPLY WHICH IS SUBSEQUENTLY DISPATCHED BY THE VENDOR OR ANY GUARANTEE / WARRANTY REPLACEMENTS SHALL BE DISPATCHED ON "FOR-BHEL STORES/DESIGNATED DESTINATION" BASIS FOR INDIGENOUS ITEMS. TAXES, IF ANY PAID BY INDIGENOUS VENDOR FOR GUARANTEE /WARRANTEE REPLACEMENT, REPAIR ACTIVITY EXCLUDING SHORT SUPPLY SHALL BE TO VENDOR'S ACCOUNT ONLY. THE VENDOR HAS TO RAISE A CREDIT NOTE FOR SHORT SUPPLIED QUANTITY AS PER GST PROVISIONS.</p>	
49	<p><b>E WAY BILL:</b> THE SUPPLIER HAS TO ARRANGE FOR E WAY BILL AS APPLICABLE FOR ANY MOVEMENT OF GOODS ALONG WITH OTHER PRESCRIBED DOCUMENTS AS PER GST LAW. THE SUPPLIER HAS ALSO TO COMPLY WITH ANY AMENDMENT AS PRESCRIBED FROM TIME TO TIME UNDER E WAY BILL RULE. ANY FINANCIAL IMPLICATION ARISES ON BHEL DUE TO NONCOMPLIANCE OF E WAY BILL RULE WILL BE PASSED ON TO THE SUPPLIER.</p>	
50	<p>THE BIDDER DECLARES THAT THEY WILL NOT ENTER INTO ANY ILLEGAL OR UNDISCLOSED AGREEMENT OR UNDERSTANDING, WHETHER FORMAL OR INFORMAL WITH OTHER BIDDER (S). THIS APPLIES IN PARTICULAR TO PRICES, SPECIFICATIONS, CERTIFICATIONS, SUBSIDIARY CONTRACTS, SUBMISSION OR NON- SUBMISSION OF BIDS OR ANY OTHER ACTIONS TO RESTRICT COMPETITIVENESS OR TO INTRODUCE CARTELIZATION IN THE BIDDING PROCESS. IN CASE, THE BIDDER IS FOUND HAVING INDULGED IN ABOVE ACTIVITIES, SUITABLE ACTION SHALL BE TAKEN BY BHEL AS PER EXISTANT POLICIES / GUIDELINES.</p>	
51	<p>THE BIDDER SHALL REGISTER THEMSELVES ON GEM PORTAL AND SHALL QUOTE THEIR GEM SELLER ID IN THEIR OFFER. GEM SELLER ID IS MANDATORY FOR PLACEMENT OF PURCHASE ORDER EXCEPT IN CASES WHERE FREE ISSUE MATERIAL IS TO BE ISSUED BY BHEL .</p>	
52	<p><b>REJECTION/REPLACEMENT:</b></p> <p>THE SELLER SHALL ARRANGE REPLACEMENT / REPAIR UNDER ITS OBLIGATION UNDER THE CONTRACT. SELLER SHALL BE GIVEN GROUND RENT FREE PERIOD OF 90 DAYS FROM THE DATE OF REJECTION TO LIFT REJECTED MATERIAL. BEYOND 90 DAYS, A GROUND RENT OF 0.25% OF VALUE OF REJECTED MATERIAL PER WEEK WILL BE LEVIED FOR A MAXIMUM PERIOD OF 4 WEEKS. BEYOND THIS PERIOD SUPPLIER FORFEITS THEIR RIGHT TO THE MATERIALS.</p>	
53	<p><b>CONFLICT OF INTEREST AMONG BIDDERS/AGENTS:</b></p> <p>A BIDDER SHALL NOT HAVE CONFLICT OF INTEREST WITH OTHER BIDDERS. SUCH CONFLICT OF INTEREST CAN LEAD TO ANTI-COMPETITIVE PRACTICES TO THE DETRIMENT OF PROCURING ENTITY'S INTERESTS. THE BIDDER FOUND TO HAVE A CONFLICT OF INTEREST SHALL BE DISQUALIFIED. A BIDDER MAY BE CONSIDERED TO HAVE A CONFLICT OF INTEREST WITH ONE OR MORE PARTIES IN THIS BIDDING PROCESS, IF</p> <p>a) THEY HAVE CONTROLLING PARTNER (S) IN COMMON; OR</p> <p>b) THEY RECEIVE OR HAVE RECEIVED ANY DIRECT OR INDIRECT SUBSIDY FINANCIAL STAKE FROM ANY OF THEM; OR</p> <p>c) THEY HAVE THE SAME LEGAL REPRESENTATIVE/AGENT FOR PURPOSES OF THIS BID; OR</p> <p>d) THEY HAVE RELATIONSHIP WITH EACH OTHER, DIRECTLY OR THROUGH COMMON THIRD PARTIES, THAT PUTS THEM IN A POSITION TO HAVE ACCESS TO INFORMATION ABOUT OR INFLUENCE ON THE BID OF ANOTHER BIDDER; OR</p> <p>e) BIDDER PARTICIPATES IN MORE THAN ONE BID IN THIS BIDDING PROCESS. PARTICIPATION BY A BIDDER IN MORE THAN ONE BID WILL RESULT IN THE DISQUALIFICATION OF ALL BIDS IN WHICH THE PARTIES ARE INVOLVED. HOWEVER, THIS DOES NOT LIMIT THE INCLUSION OF THE COMPONENTS/ SUB-ASSEMBLY ASSEMBLIES FROM ONE BIDDING MANUFACTURER IN MORE THAN ONE BID; OR</p>	

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	<p>f) IN CASES OF AGENTS QUOTING IN OFFSHORE PROCUREMENTS, ON BEHALF OF THEIR PRINCIPAL MANUFACTURERS, ONE AGENT CANNOT REPRESENT TWO MANUFACTURERS OR QUOTE ON THEIR BEHALF IN A PARTICULAR TENDER ENQUIRY. ONE MANUFACTURER CAN ALSO AUTHORISE ONLY ONE AGENT/DEALER. THERE CAN BE ONLY ONE BID FROM THE FOLLOWING:</p> <p>1. THE PRINCIPAL MANUFACTURER DIRECTLY OR THROUGH ONE INDIAN AGENT ON HIS BEHALF; AND</p> <p>2. INDIAN/FOREIGN AGENT ON BEHALF OF ONLY ONE PRINCIPAL; OR</p> <p>g) A BIDDER OR ANY OF ITS AFFILIATES PARTICIPATED AS A CONSULTANT IN THE PREPARATION OF THE DESIGN OR TECHNICAL SPECIFICATIONS OF THE CONTRACT THAT IS THE SUBJECT OF THE BID; OR</p> <p>h) IN CASE OF A HOLDING COMPANY HAVING MORE THAN ONE INDEPENDENTLY MANUFACTURING UNITS, OR MORE THAN ONE UNIT HAVING COMMON BUSINESS OWNERSHIP/MANAGEMENT, ONLY ONE UNIT SHOULD QUOTE. SIMILAR RESTRICTIONS WOULD APPLY TO CLOSELY RELATED SISTER COMPANIES. BIDDERS MUST PROACTIVELY DECLARE SUCH SISTER/ COMMON BUSINESS/ MANAGEMENT UNITS IN SAME/ SIMILAR LINE OF BUSINESS.</p>	
54	VENDOR MUST VISIT OUR WEBSITE <a href="https://herp.bhel.com">https://herp.bhel.com</a> REGULARLY FOR ENQUIRY/PO/CLARIFICATIONS/FOR ANY LATEST UPDATES.	
55	MSME VENDORS CAN AVAIL BENEFITS OF PAYMENT THROUGH TREDS/RXIL.	
56	<p>"THE OFFERS OF THE BIDDERS WHO ARE UNDER SUSPENSION AS ALSO THE OFFERS OF THE BIDDERS, WHO ENGAGE THE SERVICES OF THE FIRMS DEBARRED ACROSS BHEL, SHALL BE REJECTED. THE LIST OF FIRMS DEBARRED ACROSS BHEL IS AVAILABLE ON BHEL WEBSITE WWW.BHEL.COM.</p> <p>1.0 INTEGRITY COMMITMENT, PERFORMANCE OF THE CONTRACT AND PUNITIVE ACTION THEREOF:</p> <p>1.1. COMMITMENT BY BHEL: BHEL COMMITS TO TAKE ALL MEASURES NECESSARY TO PREVENT CORRUPTION IN CONNECTION WITH THE TENDER PROCESS AND EXECUTION OF THE CONTRACT.</p> <p>BHEL WILL DURING THE TENDER PROCESS TREAT ALL BIDDER(S) IN A TRANSPARENT AND FAIR MANNER, AND WITH EQUITY.</p> <p>1.2. COMMITMENT BY BIDDER/ SUPPLIER/ CONTRACTOR:</p> <p>1.2.1. THE BIDDER/ SUPPLIER/ CONTRACTOR COMMIT TO TAKE ALL MEASURES TO PREVENT CORRUPTION AND WILL NOT DIRECTLY OR INDIRECTLY INFLUENCE ANY DECISION OR BENEFIT WHICH HE IS NOT LEGALLY ENTITLED TO NOR WILL ACT OR OMIT IN ANY MANNER WHICH TANTAMOUNT TO AN OFFENCE PUNISHABLE UNDER ANY PROVISION OF THE INDIAN PENAL CODE, 1860 OR ANY OTHER LAW IN FORCE IN INDIA.</p> <p>1.2.2. THE BIDDER/ SUPPLIER/ CONTRACTOR WILL, WHEN PRESENTING HIS BID, DISCLOSE ANY AND ALL PAYMENTS HE HAS MADE, AND IS COMMITTED TO OR INTENDS TO MAKE TO AGENTS, BROKERS OR ANY OTHER INTERMEDIARIES IN CONNECTION WITH THE AWARD OF THE CONTRACT AND SHALL ADHERE TO RELEVANT GUIDELINES ISSUED FROM TIME TO TIME BY GOVT. OF INDIA/ BHEL.</p> <p>1.2.3. THE BIDDER/ SUPPLIER/ CONTRACTOR WILL PERFORM/ EXECUTE THE CONTRACT AS PER THE CONTRACT TERMS &amp; CONDITIONS AND WILL NOT DEFAULT WITHOUT ANY REASONABLE CAUSE, WHICH CAUSES LOSS OF BUSINESS/ MONEY/ REPUTATION, TO BHEL.</p> <p>IF ANY BIDDER/ SUPPLIER/ CONTRACTOR DURING PRE-TENDERING/ TENDERING/ POST TENDERING/ AWARD/ EXECUTION/ POST-EXECUTION STAGE INDULGES IN MALPRACTICES, CHEATING, BRIBERY, FRAUD OR AND OTHER MISCONDUCT OR FORMATION OF CARTEL SO AS TO INFLUENCE THE BIDDING PROCESS OR INFLUENCE THE PRICE OR ACTS OR OMMITS IN ANY MANNER WHICH TANTAMOUNT TO AN OFFENCE PUNISHABLE UNDER ANY PROVISION OF THE INDIAN PENAL CODE, 1860 OR ANY OTHER LAW IN FORCE IN INDIA, THEN, ACTION MAY BE TAKEN AGAINST SUCH BIDDER/ SUPPLIER/ CONTRACTOR AS PER EXTANT GUIDELINES OF THE COMPANY AVAILABLE ON WWW. BHEL.COM AND/OR UNDER APPLICABLE LEGAL PROVISIONS".</p>	
57	<p><b>BID SECURITY OR EARNEST MONEY DEPOSIT (EMD):</b> TO SAFE GUARD AGAINST A BIDDER'S WITHDRAWING OR ALTERING ITS/ HIS BID DURING THE BID VALIDITY PERIOD, BID SECURITY [ALSO KNOWN AS EARNEST MONEY DEPOSIT (EMD)] SHALL BE OBTAINED FROM THE BIDDERS ALONG WITH THEIR BIDS (EXCEPT MICRO AND SMALL ENTERPRISES (MSES) OR STARTUPS AS RECOGNIZED BY DEPARTMENT FOR PROMOTION OF INDUSTRY AND INTERNAL TRADE (DPIIT)). THE AMOUNT OF EMD SHALL BE AS MENTIONED IN ENQUIRY.</p> <p><b>1. MODES OF DEPOSIT</b></p> <p>A) THE EMD MAY BE ACCEPTED ONLY IN THE FOLLOWING FORMS AND THE SAME MUST BE SUBMITTED BEFORE TENDER OPENING:</p> <p>(I) ELECTRONIC FUND TRANSFER CREDITED IN BHEL ACCOUNT.</p> <p>(II) BANKER'S CHEQUE/ PAY ORDER/ DEMAND DRAFT, IN FAVOUR OF BHEL.</p> <p>(III) FIXED DEPOSIT RECEIPT (FDR).(IN THE NAME OF " BIDDER'S NAME A/C BHEL")</p> <p>(IV) BANK GUARANTEE FROM ANY OF THE SCHEDULED BANKS.</p> <p>(V) INSURANCE SURETY BONDS.</p> <p>B) IN CASE THE EMD IS MORE THAN RUPEES TWO LAKH AND IN CASE OF FOREIGN BIDDERS, IT MAY BE IN THE FORM OF A BANK GUARANTEE (IN EQUIVALENT FOREIGN EXCHANGE AMOUNT, IN CASE OF FOREIGN BIDDERS) ISSUED/ CONFIRMED FROM ANY OF THE SCHEDULED COMMERCIAL BANK IN INDIA IN AN ACCEPTABLE FORM. THE EMD SHALL REMAIN VALID FOR A PERIOD OF 45 (FORTY-FIVE) DAYS BEYOND THE FINAL BID VALIDITY PERIOD.</p> <p><b>2. FORFEITURE OF EMD</b></p> <p>I) A BIDDER'S EMD WILL BE FORFEITED IF THE BIDDER WITHDRAWS OR AMENDS ITS/HIS TENDER OR IMPAIRS OR DEROGATES FROM THE TENDER IN ANY RESPECT WITHIN THE PERIOD OF VALIDITY OF THE TENDER OR IF THE SUCCESSFUL BIDDER FAILS TO FURNISH THE REQUIRED PERFORMANCE SECURITY WITHIN THE SPECIFIED PERIOD MENTIONED IN THE TENDER.</p> <p>(II) EMD BY THE TENDERER SHALL BE WITHHELD IN CASE ANY ACTION ON THE BIDDER IS ENVISAGED UNDER THE PROVISIONS OF EXTANT "GUIDELINES ON SUSPENSION OF BUSINESS DEALINGS WITH SUPPLIERS/ CONTRACTORS" AND FORFEITED/ RELEASED BASED ON THE ACTION AS DETERMINED UNDER THESE GUIDELINES.</p> <p><b>3. RETURN OF EMD</b></p> <p>(I) BID SECURITIES OF THE UNSUCCESSFUL BIDDERS SHALL BE RETURNED TO BIDDER AT THE EARLIEST AFTER EXPIRY OF THE FINAL BID VALIDITY PERIOD AND LATEST BY THE 30TH DAY AFTER THE AWARD OF THE CONTRACT. HOWEVER, IN CASE OF TWO PACKET OR TWO STAGE BIDDING, BID SECURITIES OF UNSUCCESSFUL BIDDERS DURING FIRST STAGE I.E. TECHNICAL EVALUATION ETC. SHALL BE RETURNED WITHIN 30 DAYS OF DECLARATION OF RESULT OF FIRST STAGE I.E. TECHNICAL EVALUATION ETC.</p> <p>(II) BID SECURITY SHALL BE REFUNDED TO THE SUCCESSFUL BIDDER ON CONCLUSION OF THE ORDER/ RECEIPT OF A PERFORMANCE SECURITY (IF CALLED IN THE TENDER).</p> <p>(III) EMD SHALL NOT CARRY ANY INTEREST.</p>	
58	<p><b>PERFORMANCE SECURITY (PS):</b> TO ENSURE DUE PERFORMANCE OF THE CONTRACT, PERFORMANCE BANK GUARANTEE (PBG) OR SECURITY DEPOSIT (SD), HEREAFTER REFERRED AS PERFORMANCE SECURITY SHALL BE OBTAINED FROM THE SUCCESSFUL BIDDER AWARDED THE CONTRACT. THE PERFORMANCE SECURITY OF REQUIRED AMOUNT IS TO BE SUBMITTED BY THE DATE SPECIFIED IN THE PO/CONTRACT.</p> <p><b>1. MODES OF DEPOSIT:</b></p> <p>A) PERFORMANCE SECURITY MAY BE FURNISHED IN THE FOLLOWING FORMS:</p> <p>(I) LOCAL CHEQUES OF SCHEDULED BANKS (SUBJECT TO REALIZATION)/ PAY ORDER/ DEMAND DRAFT/ ELECTRONIC FUND TRANSFER IN FAVOUR OF BHEL.</p> <p>(II) BANK GUARANTEE FROM SCHEDULED BANKS / PUBLIC FINANCIAL INSTITUTIONS AS DEFINED IN THE COMPANIES ACT. THE BANK GUARANTEE FORMAT SHOULD HAVE THE APPROVAL OF BHEL.</p> <p>(III) FIXED DEPOSIT RECEIPT ISSUED BY SCHEDULED BANKS / PUBLIC FINANCIAL INSTITUTIONS AS DEFINED IN THE COMPANIES ACT (FDR SHOULD BE IN THE NAME OF THE <u>CONTRACTOR, A/C BHEL</u>).</p> <p>(IV) SECURITIES AVAILABLE FROM INDIAN POST OFFICES SUCH AS NATIONAL SAVINGS CERTIFICATES, KISAN VIKAS PATRAS ETC. (HELD IN THE NAME OF CONTRACTOR FURNISHING THE SECURITY AND DULY ENDORSED/ HYPOTHECATED/ PLEDGED, AS APPLICABLE, IN FAVOUR OF BHEL).</p> <p>(V) INSURANCE SURETY BOND.</p> <p>(NOTE: BHEL WILL NOT BE LIABLE OR RESPONSIBLE IN ANY MANNER FOR THE COLLECTION OF INTEREST OR RENEWAL OF THE DOCUMENTS OR IN ANY OTHER MATTER CONNECTED THEREWITH)</p> <p>B) IN CASE OF GTE TENDERS, THE PERFORMANCE SECURITY SHALL BE IN THE SAME CURRENCY AS THE CONTRACT AND MUST CONFORM TO UNIFORM RULES FOR DEMAND GUARANTEES (URDG 758) - AN INTERNATIONAL CONVENTION REGULATING INTERNATIONAL SECURITIES.</p> <p>(C) PERFORMANCE SECURITY IS TO BE FURNISHED WITHIN A SPECIFIED DATE (GENERALLY 14(FOURTEEN) DAYS AFTER NOTIFICATION OF THE AWARD) AND IT SHOULD REMAIN VALID FOR A PERIOD OF 60 (SIXTY) DAYS BEYOND THE DATE OF COMPLETION OF ALL CONTRACTUAL OBLIGATIONS OF THE SUPPLIER, INCLUDING WARRANTY OBLIGATIONS.</p> <p><b>2. FORFEITURE OF PERFORMANCE SECURITY:</b> THE PERFORMANCE SECURITY WILL BE FORFEITED AND CREDITED TO BHEL'S ACCOUNT IN THE EVENT OF A BREACH OF CONTRACT BY THE SUPPLIER.</p> <p><b>3. RETURN OF PERFORMANCE SECURITY (PS):</b> PS SHALL BE REFUNDED TO THE BIDDER WITHOUT INTEREST, AFTER HE DULY PERFORMS AND COMPLETES THE CONTRACT IN ALL RESPECTS BUT NOT LATER THAN 60(SIXTY) DAYS OF COMPLETION OF ALL SUCH OBLIGATIONS INCLUDING THE WARRANTY UNDER THE CONTRACT.</p>	

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	<b>4. THE PERFORMANCE SECURITY SHALL NOT CARRY ANY INTEREST.</b>	
59	<b>BREACH OF CONTRACT, REMEDIES AND TERMINATION:</b> IN CASE OF BREACH OF CONTRACT, WHEREVER THE VALUE OF SECURITY INSTRUMENTS LIKE PERFORMANCE BANK GUARANTEE AVAILABLE WITH BHEL AGAINST THE SAID CONTRACT IS ATLEAST 10% OF THE CONTRACT VALUE, THE SAME BE ENCASHED. IN CASE THE VALUE OF THE SECURITY INSTRUMENTS AVAILABLE IS LESS THAN 10% OF THE CONTRACT VALUE, THE BALANCE AMOUNT BE RECOVERED FROM OTHER FINANCIAL REMEDIES (I.E. AVAILABLE BILLS OF THE CONTRACTOR, RETENTION AMOUNT, ETC. WITH BHEL) OR LEGAL REMEDIES BE PURSUED. FURTHER, LEVY OF LIQUIDATED DAMAGES, DEBARMENT, TERMINATION, DE-SCOPING, SHORT-CLOSURE, ETC., SHALL BE APPLIED AS PER PROVISIONS OF THE CONTRACT.	

NOTE:

1. PLEASE FILL IN THIS FORMAT AND SEND COMPULSORILY ALONG WITH QUOTATION WITH VENDOR'S SEAL, SIGNATURE AND DATE.

**SIGNATURE ALONG WITH SEAL AND DATE:**

**INTEGRITY PACT****Between**

Bharat Heavy Electricals Ltd. (BHEL), a company registered under the Companies Act 1956 and having its registered office at "BHEL House", Siri Fort, New Delhi - 110049 (India) hereinafter referred to as "The Principal", which expression unless repugnant to the context or meaning hereof shall include its successors or assigns of the ONE PART

**and**

\_\_\_\_\_, (description of the party along with address), hereinafter referred to as "The Bidder/ Contractor" which expression unless repugnant to the context or meaning hereof shall include its successors or assigns of the OTHER PART

**Preamble**

The Principal intends to award, under laid-down organizational procedures, contract/s for \_\_\_\_\_

\_\_\_\_\_ (hereinafter referred to as "Contract"). The Principal values full compliance with all relevant laws of the land, rules and regulations, and the principles of economic use of resources, and of fairness and transparency in its relations with its Bidder(s)/ Contractor(s).

In order to achieve these goals, the Principal will appoint panel of Independent External Monitor(s) (IEMs), who will monitor the tender process and the execution of the contract for compliance with the principles mentioned above.

**Section 1- Commitments of the Principal**

1.1 The Principal commits itself to take all measures necessary to prevent corruption and to observe the following principles: -

1.1.1 No employee of the Principal, personally or through family members, will in connection with the tender for, or the execution of a contract, demand, take a promise for or accept, for self or third person, any material or immaterial benefit which the person is not legally entitled to.

1.1.2 The Principal will, during the tender process treat all Bidder(s) with equity and reason. The Principal will in particular, before and during the tender process, provide to all Bidder(s) the same information and will not provide to any Bidder(s) confidential/ additional information through which the Bidder(s) could obtain an advantage in relation to the tender process or the contract execution.

1.1.3 The Principal will exclude from the process all known prejudiced persons.

1.2 If the Principal obtains information on the conduct of any of its employees which is a penal offence under the Indian Penal Code 1860 and Prevention of Corruption Act 1988 or any other statutory penal enactment, or if there be a substantive suspicion in this regard, the Principal will inform its Vigilance Office and in addition can initiate disciplinary actions.

## **Section 2 - Commitments of the Bidder(s)/ Contractor(s)**

2.1 The Bidder(s)/ Contractor(s) commit himself to take all measures necessary to prevent corruption. The Bidder(s)/ Contractor(s) commits himself to observe the following principles during participation in the tender process and during the contract execution.

2.1.1 The Bidder(s)/ Contractor(s) will not, directly or through any other person or firm, offer, promise or give to the Principal or to any of the Principal's employees involved in the tender process or the execution of the contract or to any third person any material, immaterial or any other benefit which he/ she is not legally entitled to, in order to obtain in exchange any advantage of any kind whatsoever during the tender process or during the execution of the contract.

2.1.2 The Bidder(s)/ Contractor(s) will not enter with other Bidder(s) into any illegal or undisclosed agreement or understanding, whether formal or informal. This applies in particular to prices, specifications, certifications, subsidiary contracts, submission or non-submission of bids or any other actions to restrict competitiveness or to introduce cartelization in the bidding process.

2.1.3 The Bidder(s)/ Contractor(s) will not commit any penal offence under the relevant Indian Penal Code (IPC) and Prevention of Corruption Act; further the Bidder(s)/ Contractor(s) will not use improperly, for purposes of competition or personal gain, or pass on to others, any information or document provided by the Principal as part of the business relationship, regarding plans, technical proposals and business details, including information contained or transmitted electronically.

2.1.4 Foreign Bidder(s)/ Contractor(s) shall disclose the name and address of agents and representatives in India and Indian Bidder(s)/ Contractor(s) to disclose their foreign principals or associates. The Bidder(s)/ Contractor(s) will, when presenting his bid, disclose any and all payments he has made, and is committed to or intends to make to agents, brokers or any other intermediaries in connection with the award of the contract.

2.2 The Bidder(s)/ Contractor(s) will not instigate third persons to commit offences outlined above or be an accessory to such offences.

2.3 The Bidder(s)/ Contractor(s) shall not approach the Courts while representing the matters to IEMs and shall await their decision in the matter.

## **Section 3 - Disqualification from tender process and exclusion from future contracts**

If the Bidder(s)/ Contractor(s), before award or during execution has committed a transgression through a violation of Section 2 above, or acts in any other manner such as to put his reliability or credibility in question, the Principal is entitled to disqualify the Bidder(s)/ Contractor(s) from the tender process, terminate the contract, if already awarded, exclude from future business dealings and/ or take action as per the separate "Guidelines on Banning of Business dealings with Suppliers/ Contractors", framed by the Principal.

## **Section 4 - Compensation for Damages**

4.1 If the Principal has disqualified the Bidder (s) from the tender process before award / order acceptance according to Section 3, the Principal is entitled to demand and recover the damages equivalent to Earnest Money Deposit/ Bid Security.

4.2 If the Principal is entitled to terminate the Contract according to Section 3, or terminates the Contract in application of Section 3 above, the Bidder(s)/ Contractor (s) transgression through a violation of Section 2 above shall be construed breach of contract and the Principal shall be-entitled to demand and recover from the Contractor an amount equal to 5% of the contract value or the amount equivalent to Security Deposit/ Performance Bank Guarantee, whichever is higher, as damages, in addition to and without prejudice to its right to demand and recover compensation for any other loss or damages specified elsewhere in the contract.

#### **Section 5 - Previous Transgression**

5.1 The Bidder declares that no previous transgressions occurred in the last 3 (three) years with any other company in any country conforming to the anti-corruption approach or with any other Public Sector Enterprise in India that could justify his exclusion from the tender process.

5.2 If the Bidder makes incorrect statement on this subject, he can be disqualified from the tender process or the contract, if already awarded, can be terminated for such reason or action can be taken as per the separate "Guidelines on Banning of Business dealings with Suppliers/ Contractors", framed by the Principal.

#### **Section 6 - Equal treatment of all Bidder (s)/ Contractor (s) / Sub-contractor (s)**

6.1 The Principal will enter into Integrity Pacts with identical conditions as this Integrity Pact with all Bidders and Contractors.

6.2 In case of Sub-contracting, the Principal Contractor shall take the responsibility of the adoption of Integrity Pact by the Sub-contractor(s) and ensure that all Sub-contractors also sign the Integrity Pact.

6.3 The Principal will disqualify from the tender process all Bidders who do not sign this Integrity Pact or violate its provisions.

#### **Section 7 - Criminal Charges against violating Bidders/ Contractors /Subcontractors**

If the Principal obtains knowledge of conduct of a Bidder, Contractor or Subcontractor, or of an employee or a representative or an associate of a Bidder, Contractor or Subcontractor which constitutes corruption, or if the Principal has substantive suspicion in this regard, the Principal will inform the Vigilance Office.

#### **Section 8 -Independent External Monitor(s)**

8.1 The Principal appoints competent and credible panel of Independent External Monitor (s) (IEMs) for this Integrity Pact. The task of the IEMs is to review independently and objectively, whether and to what extent the parties comply with the obligations under this Integrity Pact.

8.2 The IEMs are not subject to instructions by the representatives of the parties and performs his functions neutrally and independently. He reports to the CMD, BHEL.

8.3 The IEMs shall be provided access to all documents/ records pertaining to the Contract, for which a complaint or issue is raised before them as and when warranted. However, the documents/records/information having National Security implications and those documents which have been classified as Secret/Top Secret are not to be disclosed.

- 8.4 The Principal will provide to the IEMs sufficient information about all meetings among the parties related to the Contract provided such meetings could have an impact on the contractual relations between the Principal and the Contractor. The parties offer to the IEMs the option to participate in such meetings.
- 8.5 The advisory role of IEMs is envisaged as that of a friend, philosopher and guide. The advice of IEMs would not be legally binding and it is restricted to resolving issues raised by a Bidder regarding any aspect of the tender which allegedly restricts competition or bias towards some Bidders. At the same time, it must be understood that IEMs are not consultants to the Management. Their role is independent in nature and the advice once tendered would not be subject to review at the request of the organization.
- 8.6 For ensuring the desired transparency and objectivity in dealing with the complaints arising out of any tendering process or during execution of Contract, the matter should be examined by the full panel of IEMs jointly, who would look into the records, conduct an investigation, and submit their joint recommendations to the Management.
- 8.7 The IEMs would examine all complaints received by them and give their recommendations/ views to the CMD, BHEL at the earliest. They may also send their report directly to the CVO, in case of suspicion of serious irregularities requiring legal/ administrative action. Only in case of very serious issue having a specific, verifiable Vigilance angle, the matter should be reported directly to the Commission. IEMs will tender their advice on the complaints within 30 days.
- 8.8 The CMD, BHEL shall decide the compensation to be paid to the IEMs and its terms and conditions.
- 8.9 IEMs should examine the process integrity, they are not expected to concern themselves with fixing of responsibility of officers. Complaints alleging mala fide on the part of any officer of the Principal should be looked into by the CVO of the Principal.
- 8.10 If the IEMs have reported to the CMD, BHEL, a substantiated suspicion of an offence under relevant Indian Penal Code / Prevention of Corruption Act, and the CMD, BHEL has not, within reasonable time, taken visible action to proceed against such offence or reported it to the Vigilance Office, the IEMs may also transmit this information directly to the Central Vigilance Commissioner, Government of India.
- 8.11 After award of work, the IEMs shall look into any issue relating to execution of Contract, if specifically raised before them. As an illustrative example, if a Contractor who has been awarded the Contract, during the execution of Contract, raises issue of delayed payment etc. before the IEMs, the same shall be examined by the panel of IEMs. Issues like warranty/ guarantee etc. shall be outside the purview of IEMs.
- 8.12 However, the IEMs may suggest systemic improvements to the management of the Principal, if considered necessary, to bring about transparency, equity and fairness in the system of procurement.
- 8.13 The word 'Monitor' would include both singular and plural.

## **Section 9 - Pact Duration**

- 9.1 This Integrity Pact shall be operative from the date this Integrity Pact is signed by both the parties till the final completion of contract for successful Bidder, and for all other Bidders 6 months after the



**Clause on IP in the tender****“Integrity Pact (IP)”**

- (a) IP is a tool to ensure that activities and transactions between the Company and its Bidders/ Contractors are handled in a fair, transparent and corruption free manner. Following Independent External Monitors (IEMs) on the present panel have been appointed by BHEL with the approval of CVC to oversee implementation of IP in BHEL.

Sl	IEM	Email
1.	Shri Otem Dai, IAS (Retd.)	iem1@bhel.in
2.	Shri Bishwamitra Pandey, IRAS (Retd.)	iem2@bhel.in
3.	Shri Mukesh Mittal, IRS (Retd.)	iem3@bhel.in

- (b) The IP as enclosed with the tender is to be submitted (duly signed by authorized signatory) along with techno-commercial bid (Part-I, in case of two/ three part bid). Only those bidders who have entered into such an IP with BHEL would be competent to participate in the bidding. In other words, entering into this Pact would be a preliminary qualification.
- (c) Please refer Section-8 of IP for Role and Responsibilities of IEMs. In case of any complaint arising out of the tendering process, the matter may be referred to any of the above IEM(s). All correspondence with the IEMs shall be done through email only.

**Note:**

*No routine correspondence shall be addressed to the IEM (phone/ post/ email) regarding the clarifications, time extensions or any other administrative queries, etc on the tender issued. All such clarification/ issues shall be addressed directly to the tender issuing (procurement) department's officials whose contact details are provided below:*

Details of contact person(s):

(1)  
 Name: Pankaj Kumar  
 Deptt: Purchase  
 Address: Bhel  
 Phone: (Landline/ Mobile) 6303771603  
 Email: kumar-pankaj@bhel.in  
 Fax: \_\_\_\_\_

(2)  
 Name: Amit Kumar  
 Deptt: Purchase  
 Address: Bhel  
 Phone: (Landline/ Mobile) 8874200814  
 Email: amit.kumar@bhel.in  
 Fax: \_\_\_\_\_

Contract has been awarded. Any violation of the same would entail disqualification of the bidders and exclusion from future business dealings.

9.2 If any claim is made/ lodged during currency of this Integrity Pact, the same shall be binding and continue to be valid despite the lapse of this Pact as specified above, unless it is discharged/ determined by the CMD, BHEL.

#### Section 10 - Other Provisions

10.1 This Integrity Pact is subject to Indian Laws and exclusive jurisdiction shall be of the competent Courts as indicated in the Tender or Contract, as the case may be.

10.2 Changes and supplements as well as termination notices need to be made in writing.

10.3 If the Bidder(s)/ Contractor(s) is a partnership or a consortium or a joint venture, this Integrity Pact shall be signed by all partners of the partnership or joint venture or all consortium members.

10.4 Should one or several provisions of this Integrity Pact turn out to be invalid, the remainder of this Integrity Pact remains valid. In this case, the parties will strive to come to an agreement to their original intentions.

10.5 Only those bidders / contractors who have entered into this Integrity Pact with the Principal would be competent to participate in the bidding. In other words, entering into this Integrity Pact would be a preliminary qualification.

10.6 In the event of any dispute between the Principal and Bidder(s)/ Contractor(s) relating to the Contract, in case, both the parties are agreeable, they may try to settle dispute through Mediation before the panel of IEMs in a time bound manner. In case, the dispute remains unresolved even after mediation by the panel of IEMs, either party may take further action as the terms & conditions of the Contract. The fees/expenses on dispute resolution through mediation shall be shared by both the parties. Further, the mediation proceedings shall be confidential in nature and the parties shall keep confidential all matters relating to the mediation proceedings including any settlement agreement arrived at between the parties as outcome of mediation. Any views expressed, suggestions, admissions or proposals etc. made by either party in the course of mediation shall not be relied upon or introduced as evidence in any further arbitral or judicial proceedings, whether or not such proceedings relate to the dispute that is the subject of mediation proceedings. Neither of the parties shall present IEMs as witness in any Alternative Dispute Resolution or judicial proceedings in respect of the dispute that was subject of mediation.

For & On behalf of the Principal  
(Office Seal)

Place BHEL HERP, Varanasi  
Date \_\_\_\_\_

Witness: \_\_\_\_\_  
(Name & Address) BHEL HERP Varanasi

For & On behalf of the Bidder/ Contractor  
(Office Seal)

Witness: \_\_\_\_\_  
(Name & Address) \_\_\_\_\_

**On Bidder's office letter pad**

## **Make in India (Model Certificate) Annexure-I**

### **Self-Declaration**

<b>Enquiry No.</b>	
<b>Enquiry Date</b>	

In line with Government public procurement order Number P-45021/2/2017-B.E-II dated 15.06.2017, and further modified order dt. 28.05.2018, 29.05-2019 and 04.06.2020

I / We hereby declare that I / We are a "Local Supplier" meeting the requirement of minimum local content (.....%) defined in the above government notification for the goods against above mentioned enquiry Number.

Details of location at which local value addition will be made is as follows:

Door No.	
Street / Address 1	
Street / Address 2	
District	
State	
Country	
PIN Code	

We also understand that the false declarations will be considered as breach of Integrity and liable for action.

**For Company Name:**

**Seal:**

**Signature:**

**Date:**

**Place:**

(Please fill all Yellow color field )